

#### **OWNER:**

RAMCO/CORAL CREEK, LLC.

P.O. BOX 4900 (PT 365) SCOTTSDALE, AZ 85261 (248) 592-6316 ATTN: DANIEL FEDERSPIEL

#### **TENANT:**

WENDY'S PROPERTIES, LLC.

1145 SANCTUARY PARKWAY, SUITE 225 ALPHARETTA, GA. 30009 (503) 562-9680 ÀTTN: VICTOR EVERINGHAM, LEED BD&C

#### FRANCHISEE:

JAE RESTAURANT GROUP, LLC.
1100 PARK CENTRAL BOULEVARD SOUTH

POMPANO BEACH , FL 33064 (561) 997-6602 X114 ÀTTN: LUIS RIVERA

#### **ARCHITECT:**

CKE GROUP, INC.

15500 NEW BARN ROAD, SUITE 106 MIAMI LAKES, FL 33014 (305) 558-4124 ÀTTN: LUIS VARGAS, LEED AP

#### **ENGINEER:**

CKE GROUP, INC.

15500 NEW BARN ROAD, SUITE 106 MIAMI LAKES, FL 33014 (305) 558-4124 ÀTTN: EDUARDO L. CARCACHE, P.E.

#### LANDSCAPE:

RICHARD BARTLETT LANDSCAPE, INC.

12773 W. FOREST HILL BLVD. SUITE 213 WELLINGTON, FLORIDA 33414 (561) 795-0443 ÀTTN: RICHARD BARTLETT

#### PLANNER/APPLICANT:


CORPORATE PROPERTY SERVICES 1239 E. NEWPORT CENTER DRIVE - SUITE 113 DEERFIELD BEACH, FL 33442 (954) 426-5144

ÀTTN: CRAIG McDONALD

AT CORAL CREEK US-441 & JOHNSON ROAD COCONUT CREEK, FLORIDA





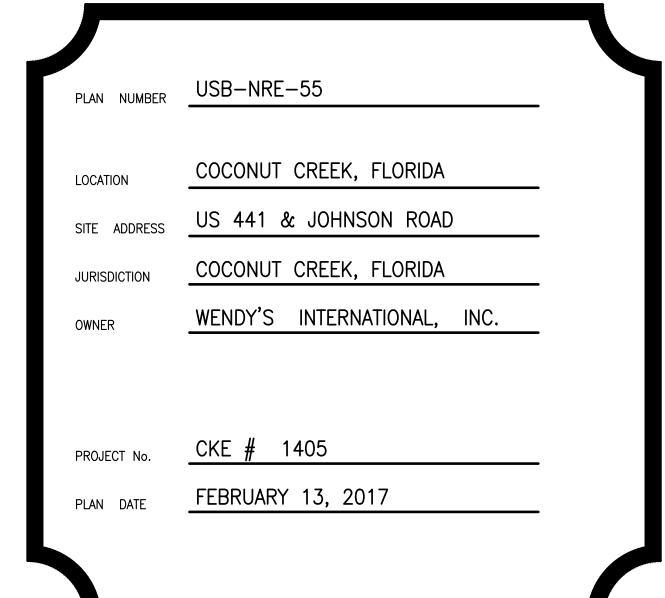




engineering \* architecture \* planning

(305) 558-4124 15500 New Barn Road #106

Miami Lakes, Florida 33014 ANA A. GONZALEZ-VALDEZ EDUARDO CARCACHE ARCHITECT - AR-0097769 ENGINEER - PE 31914

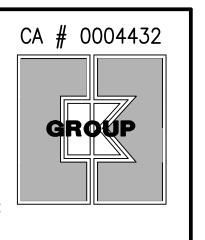



# INDEX OF DRAWINGS

-	
NO.	DESCRIPTION
CS-1	COVER SHEET
CS-2	INDEX OF SHEETS
SP-1	MASTER SITE PLAN
SP-2	SITE PLAN
SP-3	SITE DETAILS
SP-4	TRASH ENCLOSURE DETAILS
SP-5	PEDESTRIAN SITE PLAN
SP-6	TRELLIS DETAILS
SURV-1	SURVEY
SURV-2	SURVEY
PLAT-1	RECORDED PLAT
A-1.1	FLOOR PLAN
A-2.1	ELEVATIONS
A-2.2	ELEVATIONS
TS-1	TREE DISPOSITION PLAN
LP-1	LANDSCAPE PLAN
LP-2	LANDSCAPE SPECIFICATION & DETAILS
LP-3	IRRIGATION PLAN
PH-1	PHOTOMETRIC PLAN
C-1	PAVING & DRAINAGE PLAN
C-2	PAVING & DRAINAGE DETAILS
C-3	SITE UTILITY PLAN
C-4	PAVEMENT MARKING PLAN
C-5	STORMWATER POLLUTION PREVENTION DETAILS
C-6	SITE DEMOLITION PLAN
C-7	CONSTRUCTION FENCE & ACCESS PLAN
C-8	TRUCK PATH PLAN

GREEN STANDARDS	DESCRIPTION
13-320(b)(1)	
LEED Accredited Professional	LUIS VARGAS LEED COORDINATOR, VICTOR EVERINGHAM, LEED E
SUSTAINABLE SITE DEVELOPMENT	1
	Wind screen to be provided - Site will be watered to minimize of
Construction Pollution Prevention	during construction. Filter fabric provided at catch basin inlets
	Contractor shall dispose of 75% minimum of all appropriate
	construction material with qualified C & D recycling facility.
Construction site materials recycling	Verification will be required.
	Utilizing exfiltration trench and reducing the amount of asphalt
Stormwater management	the current site to reduce stormwater runoff from this parcel.
Alternative transportation	1 bicycle parking rack provided.
Minimizing heat island effect	Roof is white, highly reflective.
WATER EFFICIENT	1
	Water source & methods comply with Florida friendly Landscape
	Nine Principles. Low flow restroom fixtures. At lease 80% of
	landscape is drought tolerant. Native plants are provided need
Innovative water technologies	less irrigation.
	Rain sensor/timer is provided for landscape irrigation. Irrigation
Water efficient	water source is a well. Low flow restroom fixtures provided.
ENERGY EFFICIENCY	1
	Building lighting will be high efficiency, LED fixtures. Site parki
Minimum energy performance	lighting will be high efficiency LED fixtures.
On-site renewable energy	N/A
Indoor environmental quality	N/A
Indoor air quality	Interior to be low VOC products
MATERIALS & RECYCLING	
	Contractor shall dispose of 75% minimum of all appropriate
Recycling of demolition waste	construction material with qualified C & D recycling facility.
	Recycling dumpster provided for operator to use & all cardboard
Storage & collection of recyclables post occupancy	from delivery will be recycled.
Building re-use	N/A
Regional materials	Regional materials will be used as much as possible
13-320(b)(3)	
Acknowledgement to maintain the green building	
components for the life of the building	JAE Restaurant Group, LLC
GREEN ACTION ITEMS	
ACTION ITEMS	DESCRIPTION
Action 1.6 - Ensure 100% of new development projects	
throughout the City contain conspicuous displays of green	
technology that function in the project design while	
providing a social, artistic and environmental value.	N/A
Action 2.1 - Achieve 40% tree canopy coverage throughout	
the City with maximum tree coverage on public & private	
land by 2020.	Provide 40% of parcel
Action 2.2 - Achieve 40% greenroof coverage for new	
construction in MainStreet. Project area & 10% greenroof	
coverage for new construction for areas outside of	
MainStreet. (i.e. high albedo paint on roof).	White roof membrane incorporated
Action 5.1 - Increase recycling throughout the City by 25%	
BY 2014 & 50% BY 2020.	Enclosure for recycling provided
Action 5.3 - Require all construction & demolition debris	
to divert 75% of waste from landfills.	Will coordinate with Republic Services
Action 6.2 - Bicycle parking on site	Bicycle rack will be provided.
Action 6.4 - Alternative vehicle parking.	N/A

DEPLAN NUMBER USB-NRE-55

LOCATION COCONUT CREEK, FLORIDA

SITE ADDRESS US 441 & JOHNSON ROAD

JURISDICTION COCONUT CREEK, FLORIDA

OWNER WENDY'S INTERNATIONAL, INC.

PROJECT No. CKE # 1405

PLAN DATE FEBRUARY 13, 2017

CKE GROUP, INC.

engineering • architecture • planning


[305] 558-4124 15500 New Barn Road #106

Miami Lakes, Florida 33014


ANA A. GONZALEZ-VALDEZ
ARCHITECT - AR-0097769

ENGINEER - PE 31914



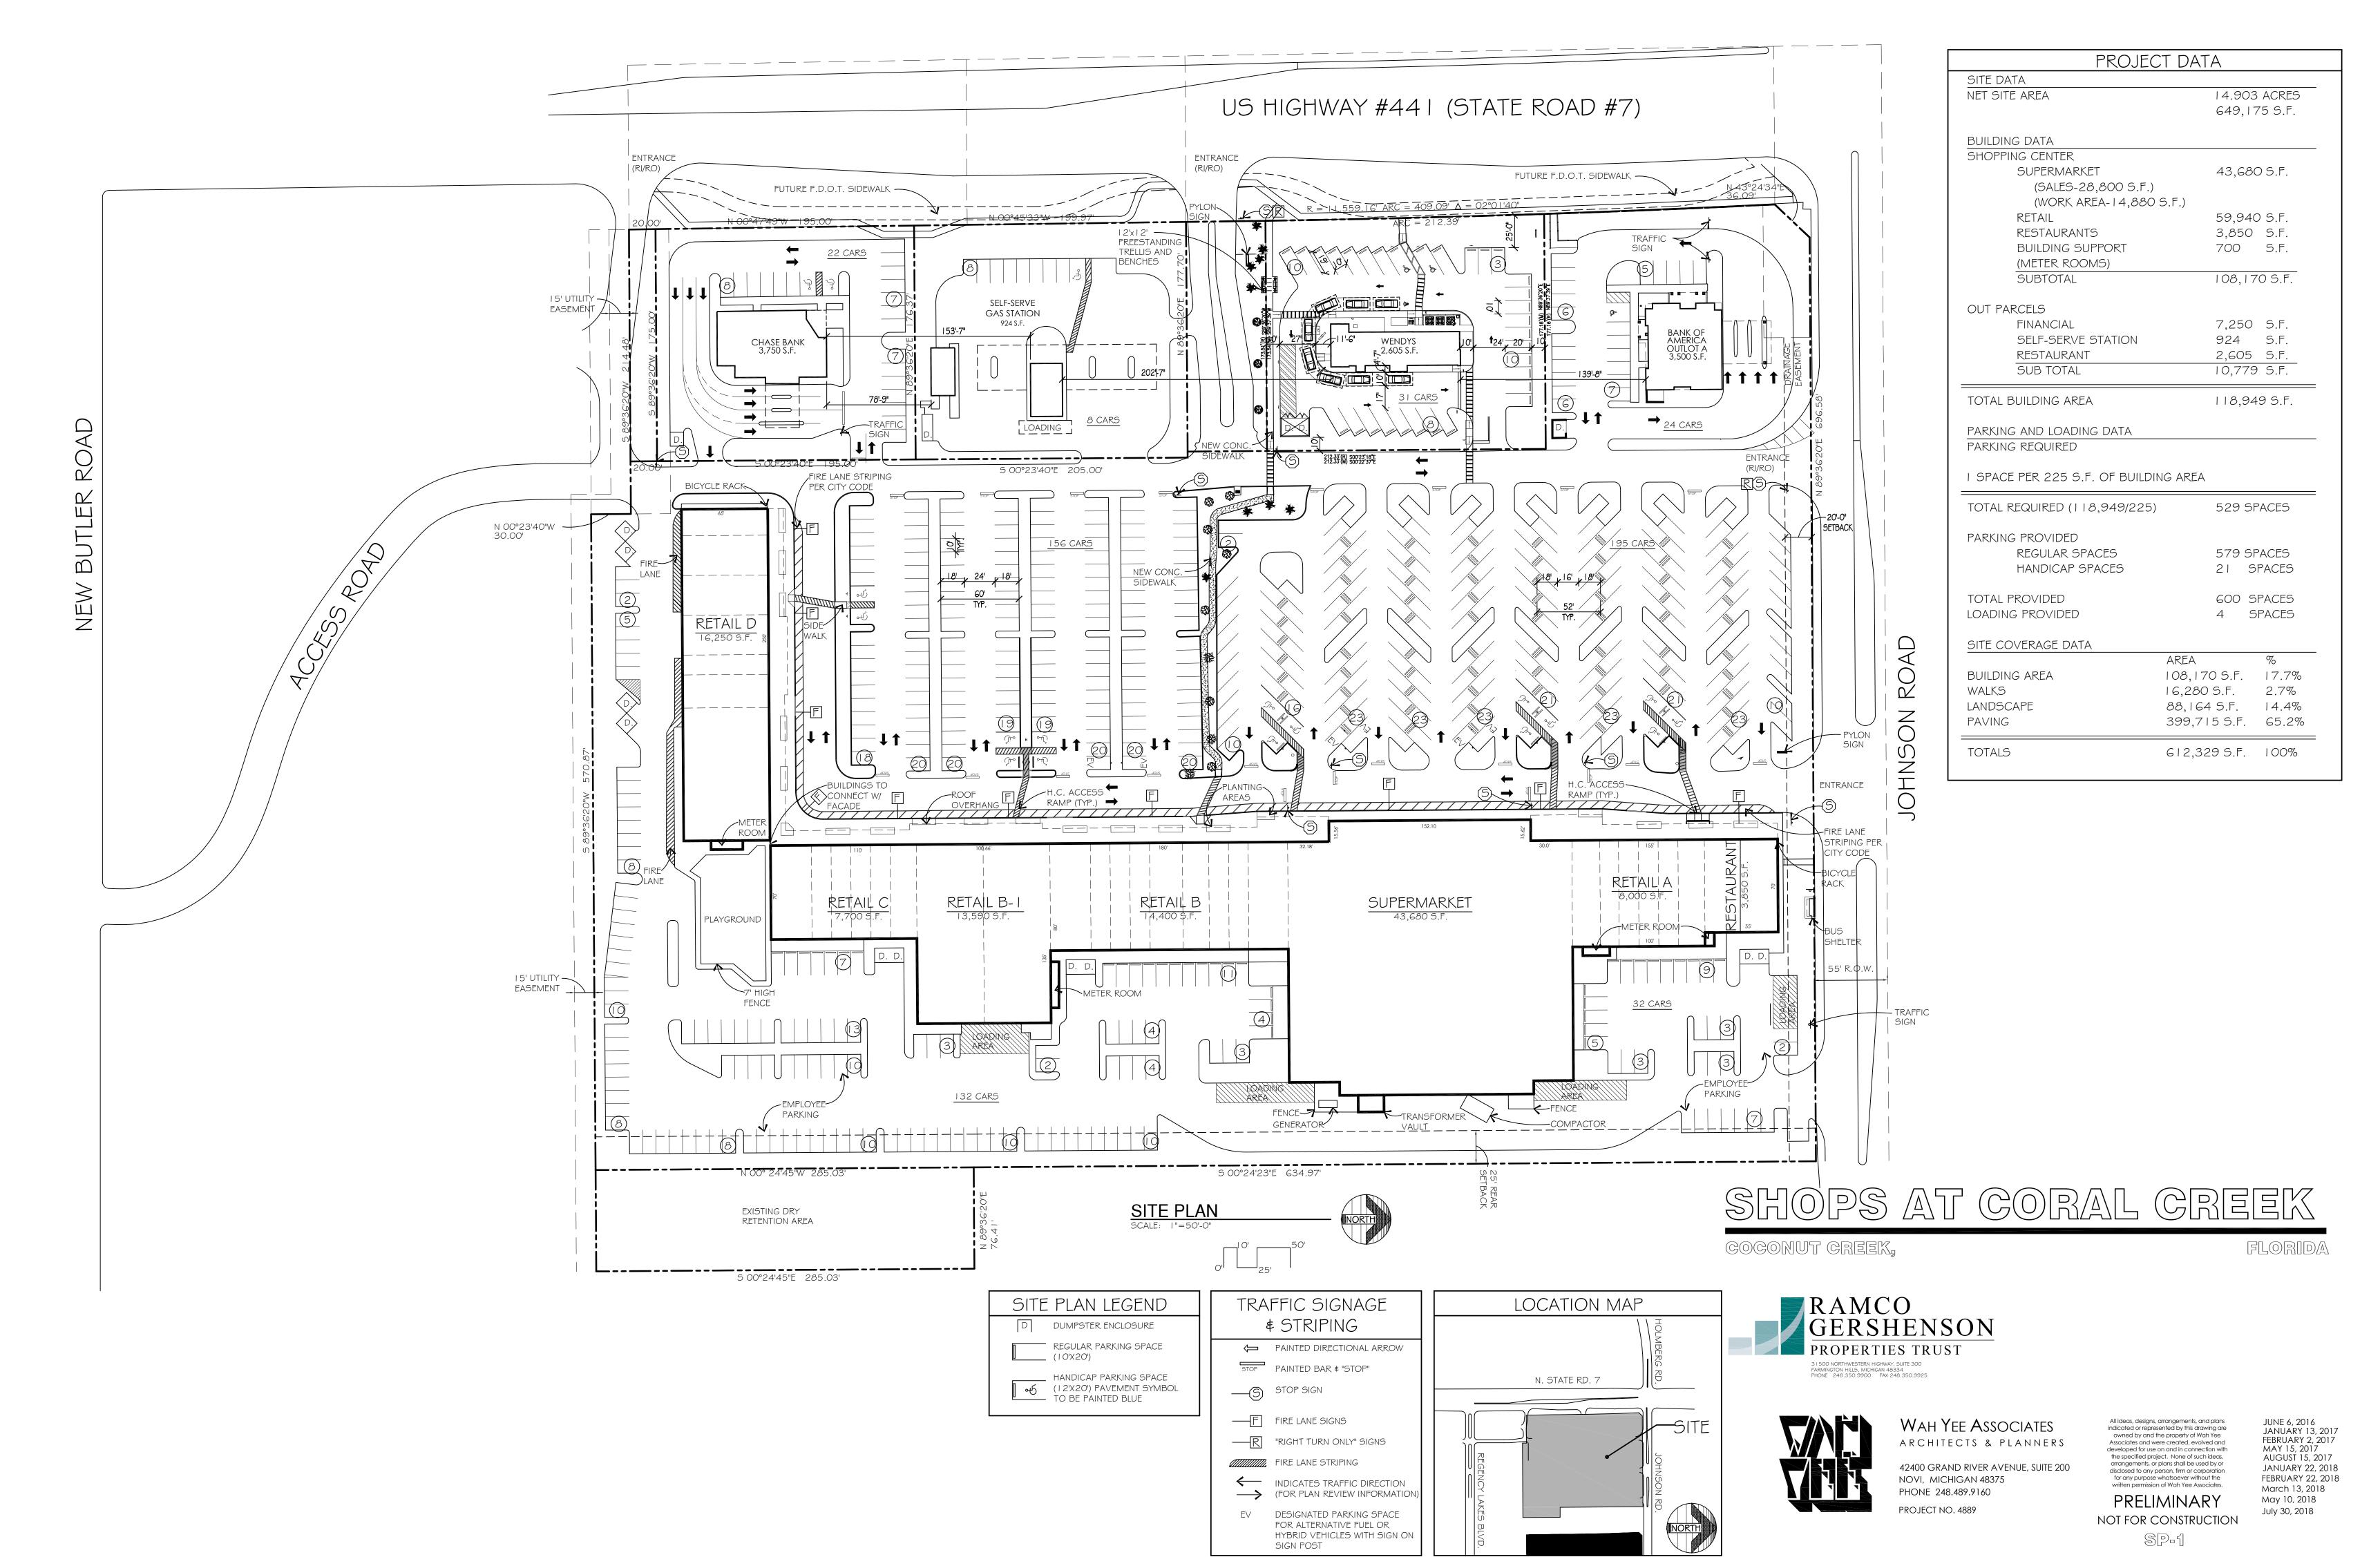

CAD DWG 030-SP-1-CORAL CREEK-MASTER SITE PLAN-7\_30\_18.DWG

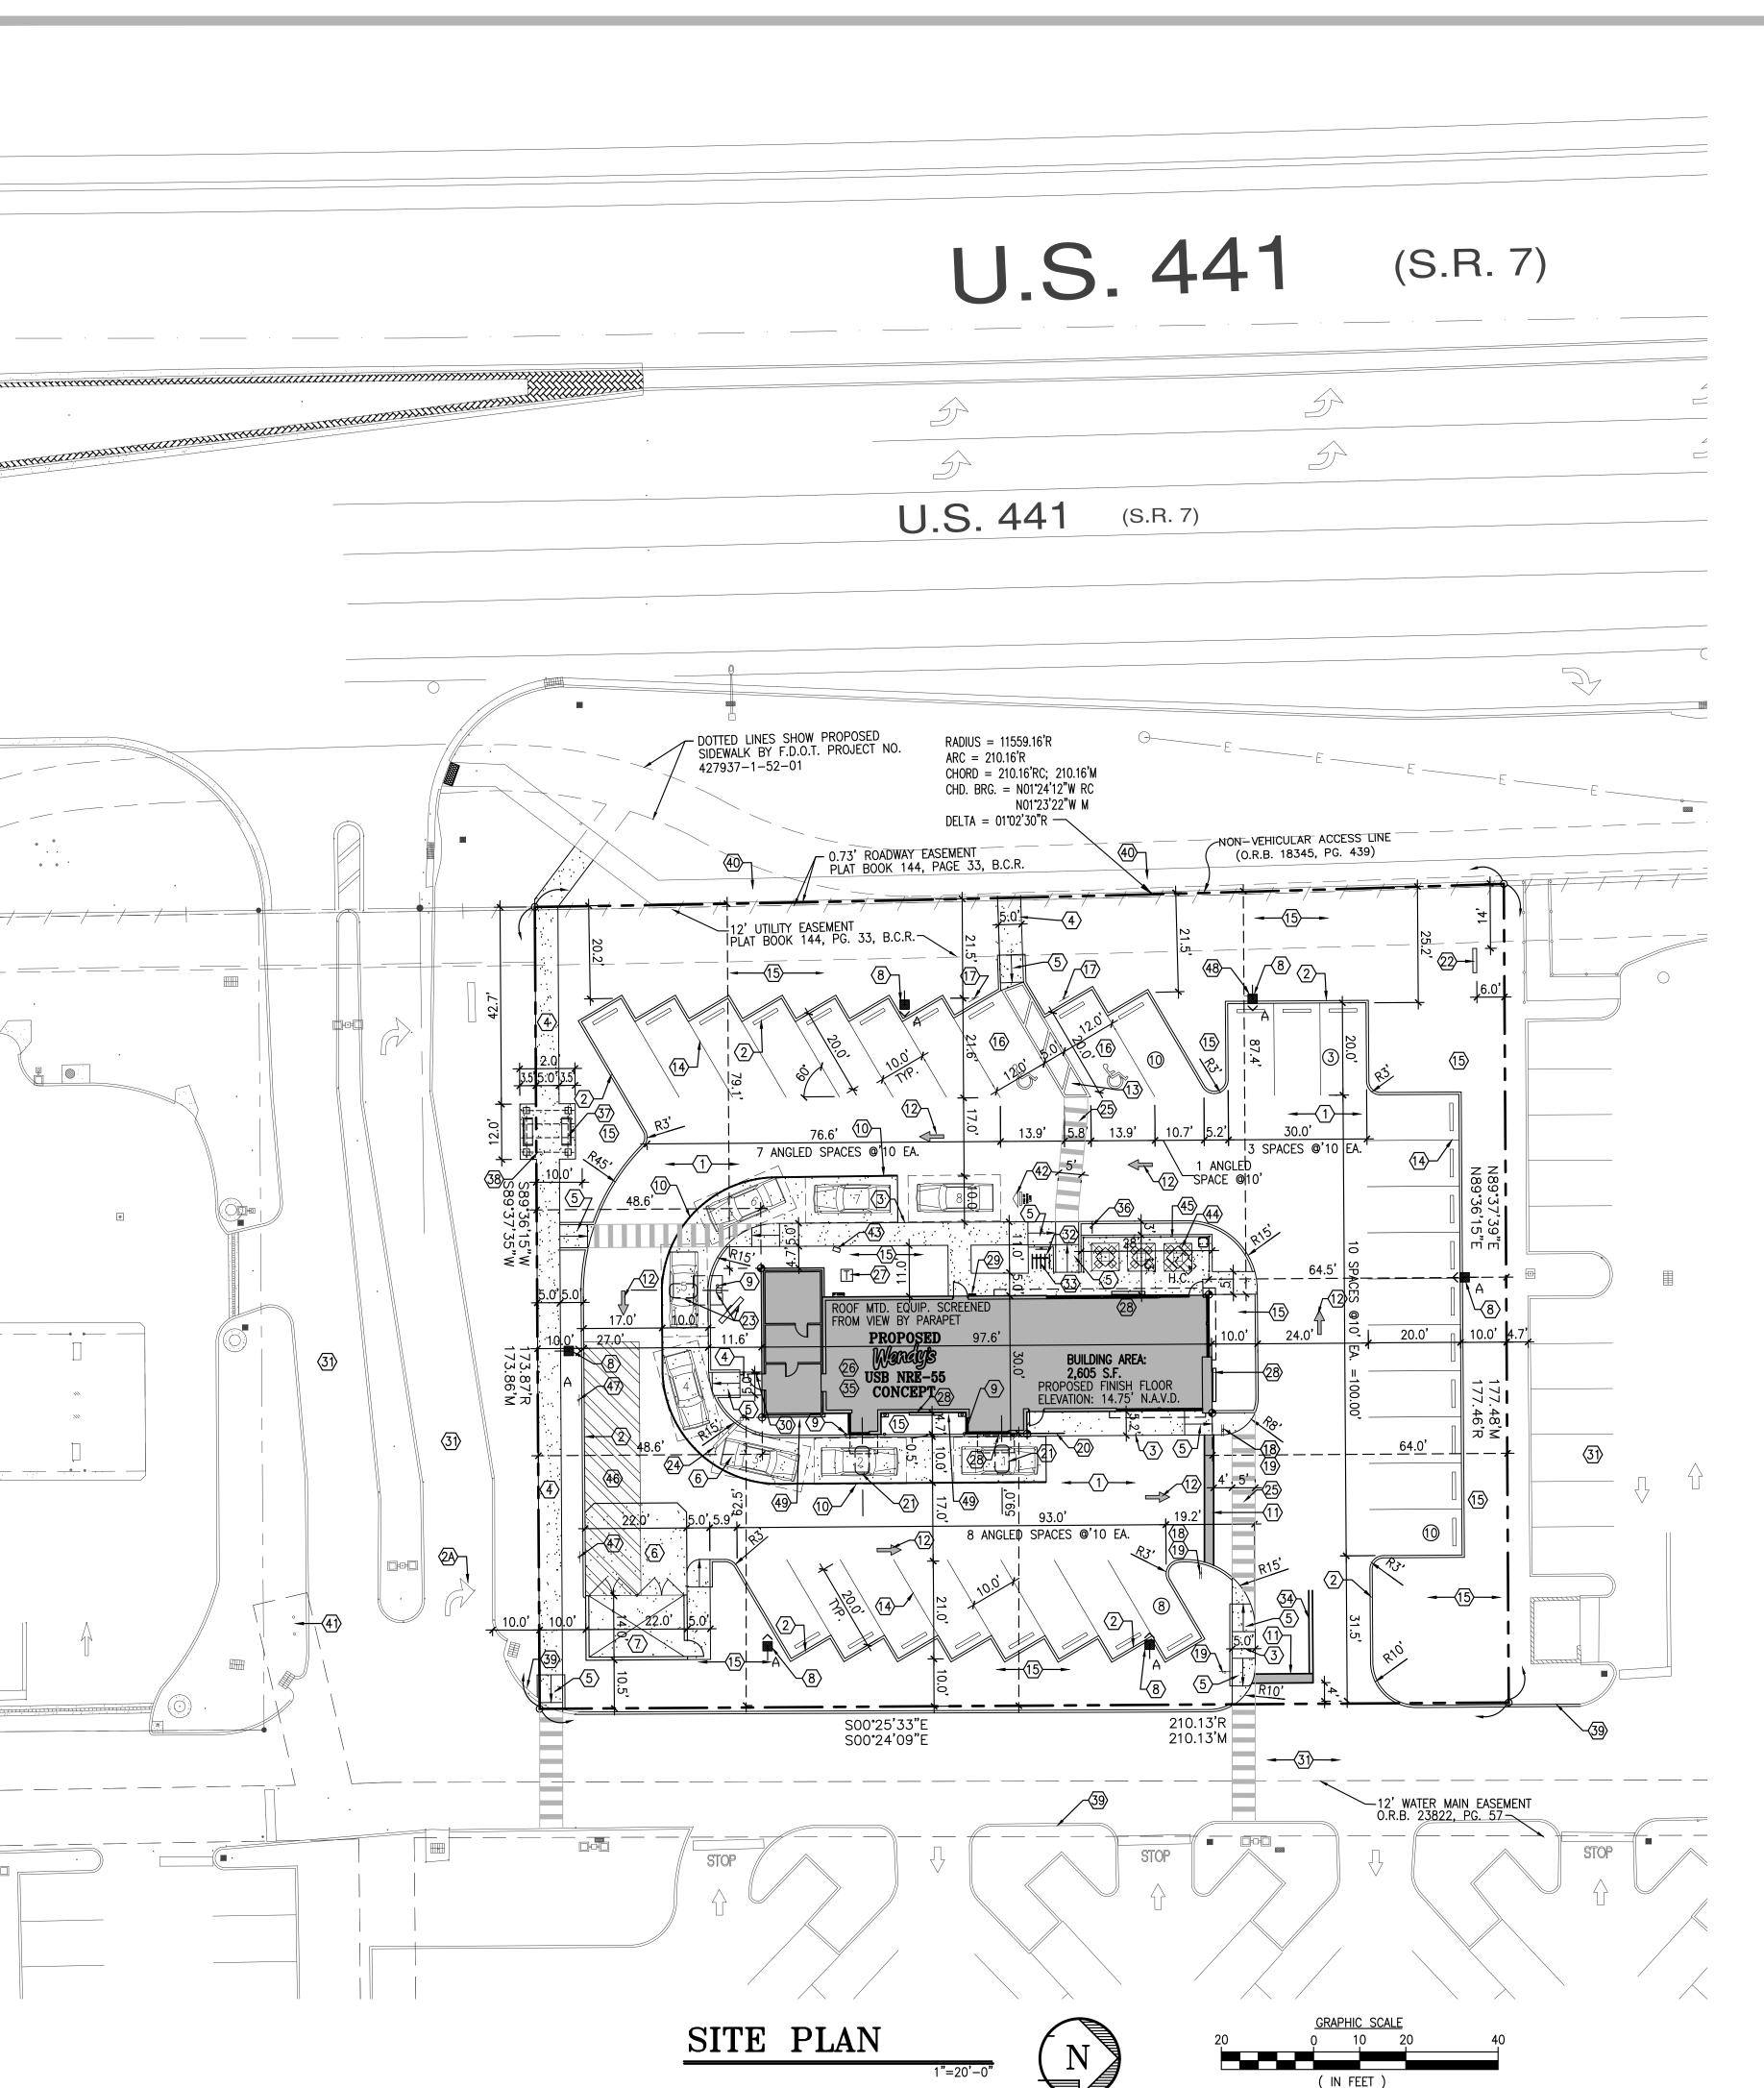


#### **CONSTRUCTION NOTES:**

- (1) ASPHALT PAVEMENT AS PER DETAIL.
- (2) 6" P.C.C. TYPE 'D' CURB AS PER DETAIL
- ②A EXISTING PAVEMENT MARKINGS
- 3 P.C.C. CURB EDGE SIDEWALK AS PER DETAIL
- 4 P.C.C. CONCRETE SIDEWALK AS PER DETAIL
- (5) P.C.C. HANDICAP RAMP MAX SLOPE 1:12.
- $\langle 6 \rangle$  6" THICK P.C.C. PAD W/ 6"x6" -10/10 W.W.M. OVER CRUSHED AGGREGATE OR GRAVEL BASE. CONSTRUCTION JOINTS AT 10 FEET ON CENTER. (COLOR BLACK)
- (7) TRASH ENCLOSURE AS PER DETAIL.
- (8) LED PARKING LIGHT AS PER SITE LIGHTING (PH-1)
- (9) STEEL BOLLARD AS PER DETAIL.
- (10) 215-LF 6" YELLOW. (THERMOPLASTIC)
- (11) 24" STOP BAR WHITE. (THERMOPLASTIC)
- 12 TRAFFIC ARROWS PAINTED WHITE.
- (13) 6" WHITE STRIPES AT 60" (PER FDOT INDEX No. 17346)
- (14) 4" WHITE STRIPES (TYPICAL AT PARKING SPACES)
- (15) LANDSCAPE AREA
- (16) HANDICAP PARKING AS PER DETAIL.
- (17) HANDICAP SIGN 7'-0" A.F.F.
- (18) STANDARD F.D.O.T. "DO NOT ENTER" SIGN (R5-1)
- (19) STANDARD F.D.O.T. HIGH INTENSITY "STOP" SIGN. R1-1 (30"x30")
- 20 RAILING PAINTED BLACK
- 21) SENSOR LOOP AT D/T WINDOW
- (22) MONUMENT SIGN
- MENU BOARD AND SENSOR LOOP W/ SPEAKER PEDESTAL
- 24) CLEARANCE BAR
- 25) PEDESTRIAN CROSSING PER F.D.O.T. INDEX No. 17346
- 26 PROPOSED BUILDING
- TRANSFORMER PAD (COORDINATE LOCATION WITH FPL)
- 28 BUILDING SIGN
- 29 PROVIDE BUILDING ADDRESS "1234" WITH NUMERALS 9 INCHES HIGH. REFER TO BUILDING ELEVATION
- (30) PROVIDE BUILDING ADDRESS AND BUSINESS NAME ON SERVICE DOOR. REFER TO BUILDING ELEVATION ALL LETTERS TO BE CONSISTENT IN STYLE (4" HIGH)
- (31) EXISTING PAVEMENT
- (32) 'BICYCLE PARKING' SIGN
- 33 BICYCLE RACK BY HUNTCO-MODEL BR3 OR APPROVED EQUAL FINISH: POWDER COATED BLACK (SEE DETAIL ON SHEET SP-3)
- 34 25 L.F. 4" DOUBLE YELLOW
- 35 ALL ROOF MOUNTED EQUIPMENT AND ACCESSORIES SHALL BE SCREENED FROM VIEW BY PARAPET
- (36) PEDESTRIAN CROSSING SIGN
- CW86 CREEKVIEW BENCH WITH BASE (SILVER) BY KEYSTONE RIDGE DESIGNS
- (38) 12'x12' FREE STANDING TRELLIS
- (39) EXIST. CURB
- (40) EXIST. SIDEWALK
- (41) EXIST. FIRE HYDRANT
- (42) PAVEMENT MARKINGS
- (43) PREVIEW MENU BOARD
- (44) OUTDOOR SEATING AREA (PATIO)
- 45 PATIO FENCE (3' HEIGHT, MIN.)
- 46 12'x55' LOADING ZONE (47) "NO PARKING SIGN"
- (48) 'HYBRID PARKING ONLY' SIGN.
- 49 GREEN WALL, REFER TO BUILDING ELEVATIONS

#### NOTES

- ALL PAVEMENT MARKINGS ARE TO COMPLY WITH BROWARD COUNTY TRAFFIC ENGINEERING STANDARDS/MUTCD.
- ALL MARKINGS EXCEPT PARKING SPACE LINES SHALL BE THERMOPLASTIC
- AND 6" WIDE. ALL SIGNS BY SEPARATE PERMIT.
- 4. ALL RADII AND DIMENSIONS ARE TO FACE OF CURB/EDGE OF PAVEMENT. 5. THE ELEVATIONS SHOWN HEREON ARE BASED ON NORTH AMERICAN VERTICAL
- DATUM OF 1988 (N.A.V.D. 1988) AS ESTABLISHED FROM N.G.S. CONTINUOUSLY OPERATING REFERENCE STATIONS (C.O.R.S.) "MIAMI WAAS 1 CORS ARP", "MIAMI THT CORS ARP" AND "WEST PALM CORS ARP" USING THE ONLINE POSTITIONING USER SERVICE (O.P.U.S.) ON APRIL 26, 2016. TO CONVERT ELEVATIONS TO THE NATIONAL GEODETIC VERTICAL DATUM OF 1929 (N.G.V.D. 1929), ADD 1.55 FEET.
- 6. ALL SIDEWALKS SHALL BE A MIN. OF 5 FEET IN WIDTH.

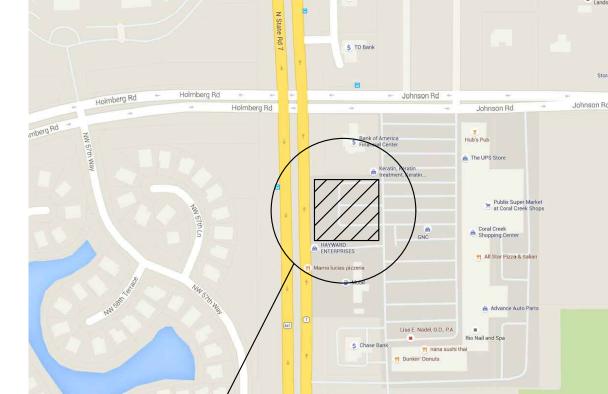

23,931.20 SQ. FT. ( 64.95 % ) (0.549± ACRES)



#### LEGAL DESCRIPTION

A PORTION OF TRACT "A", SAWGRASS PARK OF COMMERCE COMMERCIAL SECTION "B", ACCORDING TO THE PLAT THEREOF, AS RECORDED IN PLAT BOOK 144, PAGE 33, OF THE PUBLIC RECORDS OF BROWARD COUNTY, FLORIDA, BEING MORE PARTICULARLY DESCRIBED AS FOLLOWS.

COMMENCING AT THE WESTERLY NORTHWEST CORNER OF SAID TRACT "A", SAID POINT BEING ON THE EASTERLY RIGHT-OF-WAY LINE OF U.S. HIGHWAY NO. 441 (STATE ROAD NO. 7) AS SHOWN ON SAID PLAT AND ON THE ARC OF A CURVE CONCAVE WESTERLY, TO WHICH A RADIAL LINE BEARS NORTH 87'12'47" EAST; THENCE SOUTHERLY ON SAID EASTERLY RIGHT-OF-WAY LINE, ON THE WESTERLY LINE OF SAID TRACT "A" AND ON THE ARC OF A CURVE TO THE RIGHT, HAVING A RADIUS OF 11,559.16 FEET, A CENTRAL ANGLE OF 0°51'46", FOR AN ARC DISTANCE OF 174.06 FEET TO THE POINT OF BEGINNING; THENCE NORTH 89'36'15" EAST ON A NON-RADIAL LINE 177.46 FEET; THENCE SOUTH 00°25'33" EAST 210.13 FEET; THENCE SOUTH 89°36'15" WEST ON A LINE NON-RADIAL TO THE FOLLOWING DESCRIBED CURVE 173.87 FEET TO THE INTERSECTION WITH THE AFOREMENTIONED EASTERLY RIGHT-OF-WAY LINE OF U.S. HIGHWAY NO. 441 (STATE ROAD NO. 7), SAID WESTERLY LINE OF TRACT "A" AND A POINT ON SAID CURVE CONCAVE WESTERLY, TO WHICH A RADIAL LINE BEARS NORTH 89°07'03" EAST; THENCE NORTHERLY ON THE ARC OF SAID CURVE TO THE LEFT, HAVING A RADIUS OF 11,559.16 FEET, A CENTRAL ANGLE OF 1°02'30", FOR AN ARC DISTANCE OF 210.16 FEET TO THE POINT OF BEGINNING.

SAID LANDS SITUATE, LYING AND BEING IN THE CITY OF COCONUT CREEK, BROWARD COUNTY, FLORIDA, CONTAINING 36,846 SQUARE FEET (0.8459 ACRES), MORE OR LESS.

#### ZONING: B-3 COMMUNITY SHOPPING DISTRICT LAND USE: COMMERCIAL

BUILDING HEIGHT: 26-9 1/2"

SITE ANALYSIS

<u>PROPOSED</u> 36,846.00 SQ. FT. ( 0.846± ACRES ) 36,846.00 SQ. FT. ( 0.846± ACRES )

31 SPACES

TOTAL BUILDING COVERAGE: 2,605.00 SQ. FT. ( 7.07 % ) **TOTAL LANDSCAPED AREA:** 8,056.38 SQ. FT. ( 21.87 % ) 12,914.80 SQ. FT. ( 35.05 % )

28,789.62 SQ. FT. ( 78.13 % ) (0.661± ACRES)

TOTAL PAVED AREA & WALKS: 28,789.62 SQ. FT. ( 78.13 % ) 21,326.20 SQ. FT. ( 57.88 % ) PERVIOUS AREA: 8,056.38 SQ. FT. ( 21.87 % ) (0.185± ACRES) 12,914.80 SQ. FT. ( 35.05 % ) (0.296± ACRES)

TOTAL LAND AREA:

IMPERVIOUS AREA:

TOTAL PARKING SPACES PROVIDED:

(INCLUDING HANDICAP IN OUT PARCEL)

**PARKING ANALYSIS** TOTAL PARKING SPACES REQUIRED: (1/150 SF OF CUST. SERVICE AREA - 951/150=7) 14 SPACES 1/300 SF OF NON-CUST. SERVICE AREA - 917/300=4) (1/150 SF OF PATIOAREA - 364/150=3) HANDICAP SPACES REQUIRED: 1 SPACES HANDICAP SPACES PROVIDED: 2 SPACES

LOCATION PLAN



SITE NUMBER:

BASE MODEL:

ASSET TYPE:

CLASSIFICATION:

BASE VERSION:

PROJECT YEAR:

FURNITURE PACKAGE:

DRAWING RELEASE

OWNER: JAE REST. GROUP, LLC

UPGRADE CLASSIFICATION:

USB NRE 55 R3

XXXXXXXXX

2016 R3

CORP. NEW BUILD

**GROUP** INCORPORATED 15500 NEW BARN ROAD SUITE 106 MIAMI LAKES , FLORIDA 33014

GROUP

FAX: (305) 826-0619

PHONE: (305) 558-4124

PROJECT TYPE: USB NRE 55

REV. DATE 1 05-01-18 /2\ 07-18-18


ISSUE DATE:

EDUARDO L. CARCACHE, PE 31914 ANA A. GONZALEZ VALDES, AR 97769 LUIS VARGAS, LEED AP #701023753163800 CKE GROUP, INC. COA-4432

SITE PLAN

SHEET NAME

SHEET NUMBER

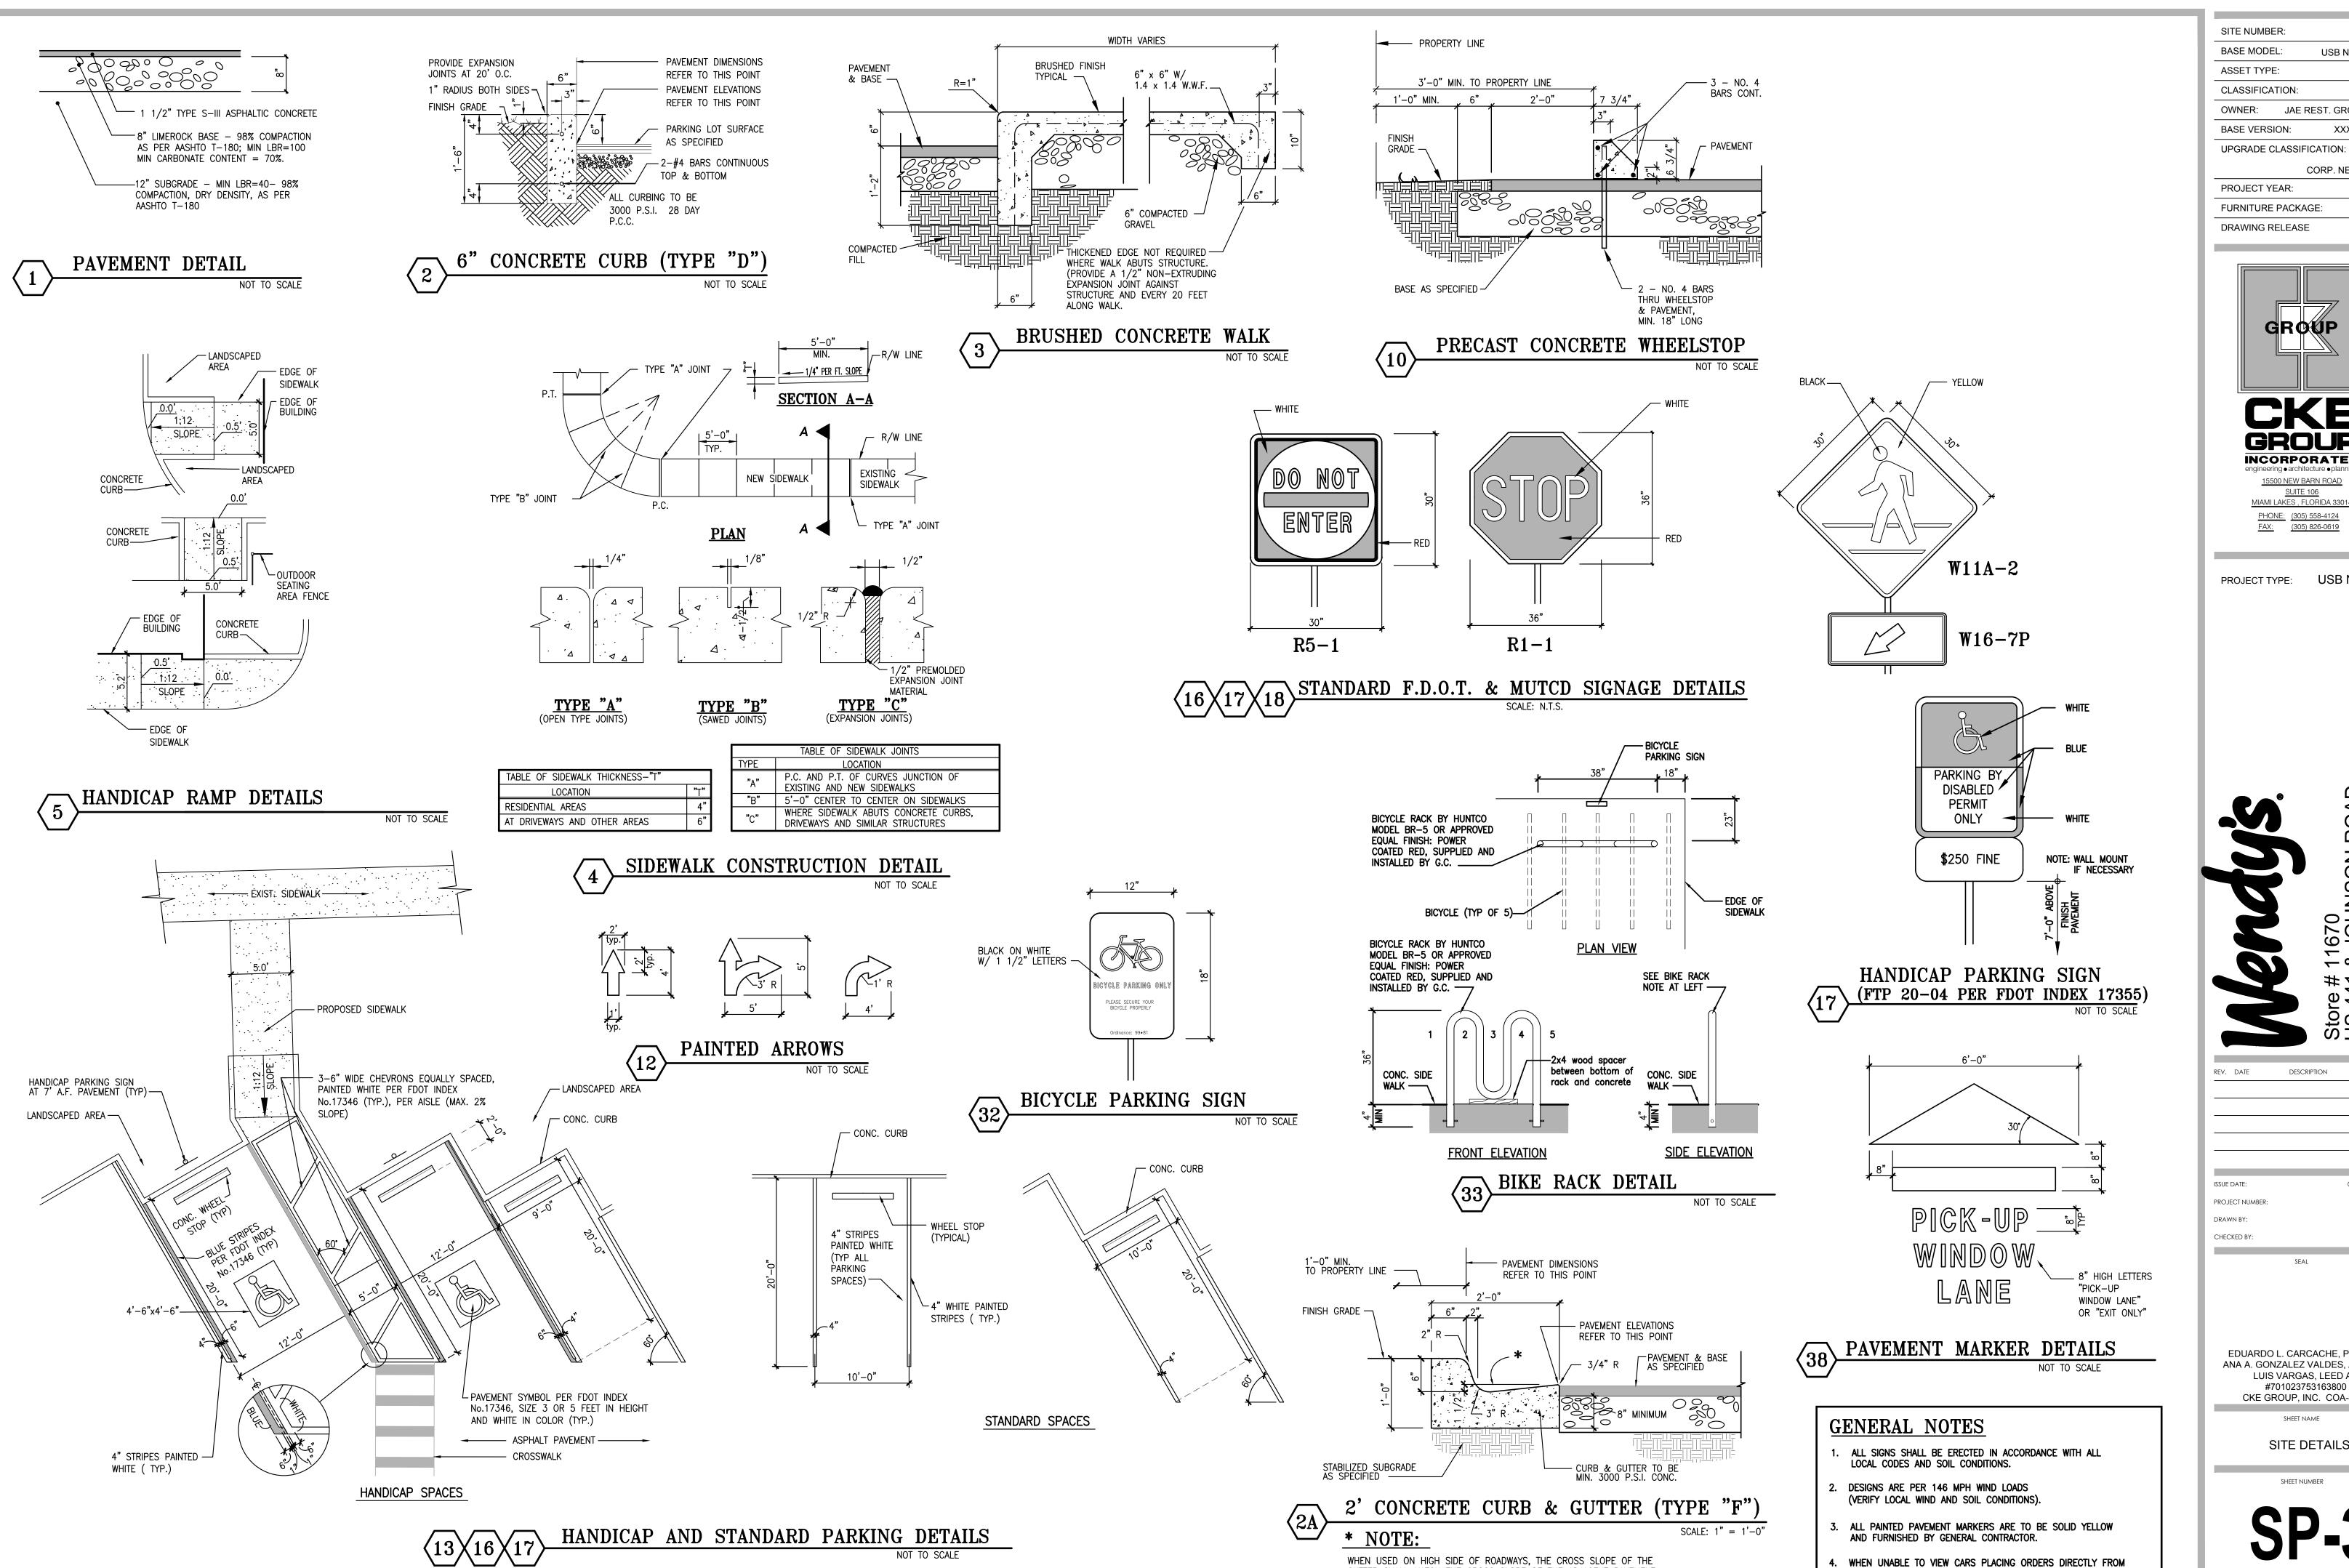

GUTTER SHALL MATCH THE CROSS SLOPE OF THE ADJACENT PAVEMENT

THE THICKNESS OF THE LIP SHALL BE 6", UNLESS OTHERWISE SHOWN

SITE NUMBER: BASE MODEL: USB NRE 55 R3 ASSET TYPE: CLASSIFICATION:

OWNER: JAE REST. GROUP, LLC XXXXXXXXX

CORP. NEW BUILD PROJECT YEAR: FURNITURE PACKAGE: 2016 R3 2016 R3



INCORPORATED SUITE 106 MIAMI LAKES , FLORIDA 33014

PROJECT TYPE: USB NRE 55

DESCRIPTION


EDUARDO L. CARCACHE, PE 31914

ANA A. GONZALEZ VALDES, AR 97769 LUIS VARGAS, LEED AP #701023753163800 CKE GROUP, INC. COA-4432

> SHEET NAME SITE DETAILS

PICK-UP WINDOW A 24" CONVEX MIRROR SHALL BE PLACED IN AN

APPROPRIATE LOCATION TO VIEW CUSTOMERS AT ORDER STATION.

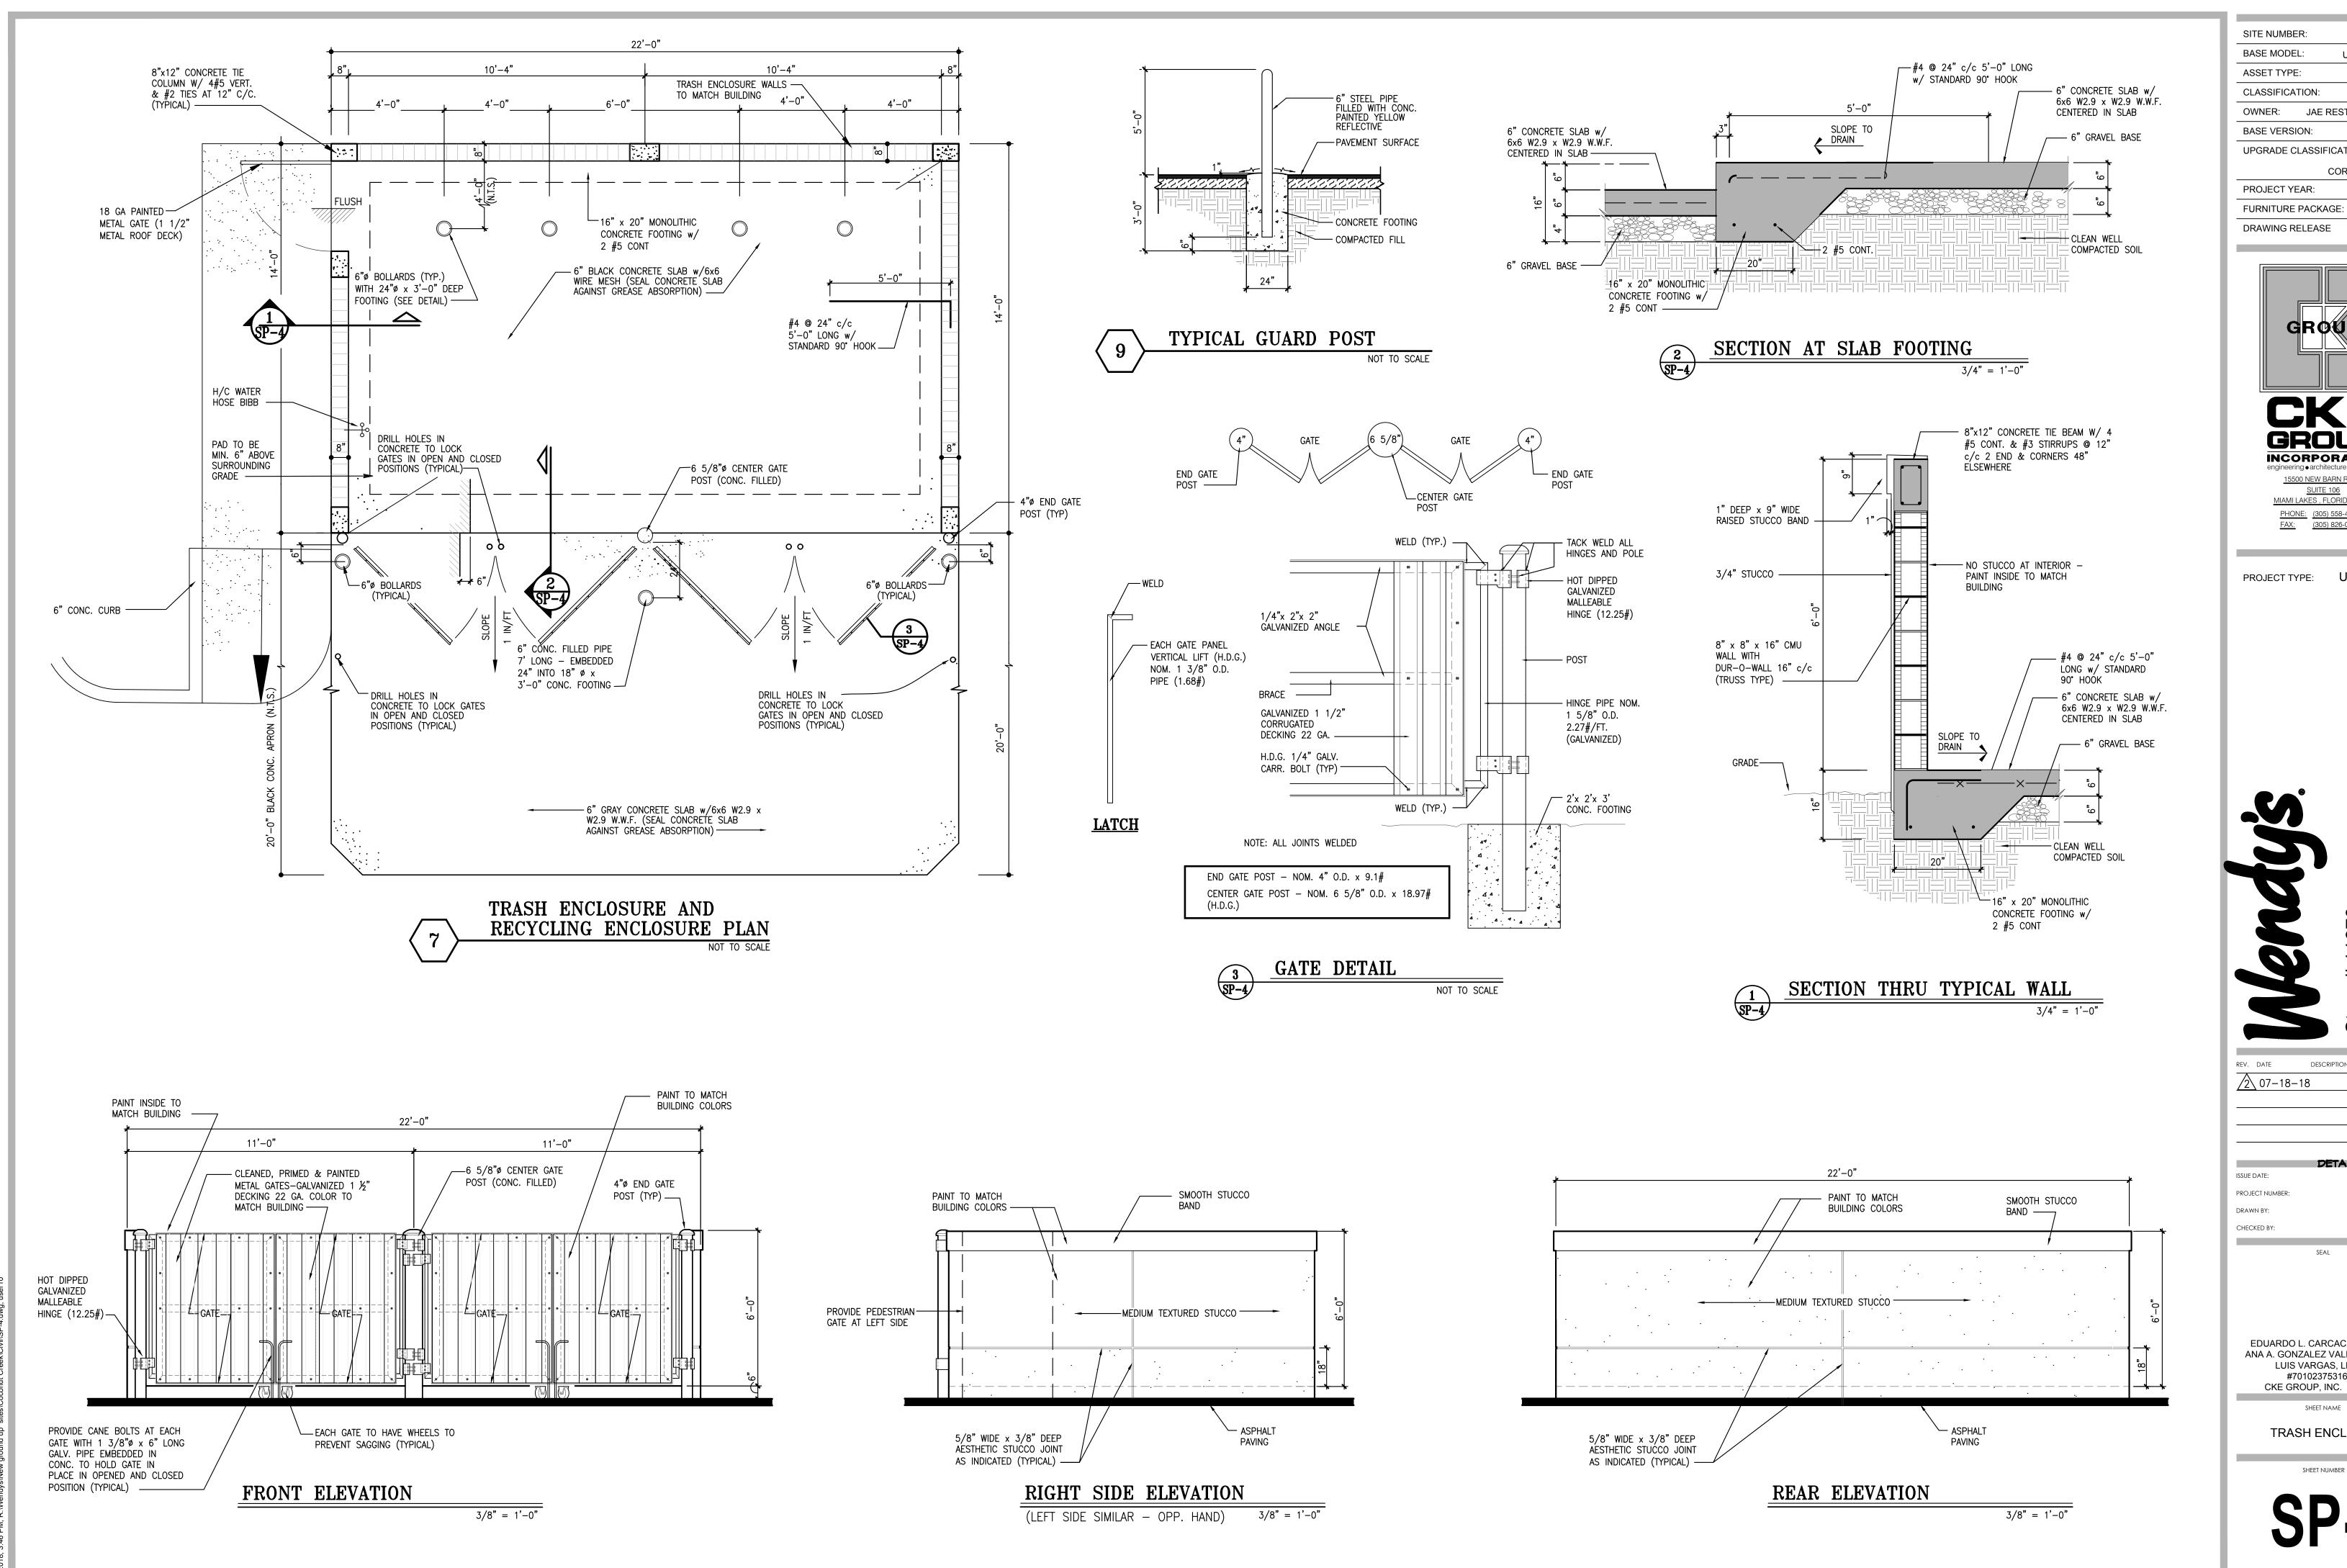

SITE NUMBER: 11670 BASE MODEL: USB NRE 55 R3 ASSET TYPE: CLASSIFICATION: NEW

OWNER: JAE REST. GROUP, LLC XXXXXXXX

UPGRADE CLASSIFICATION: CORP. NEW BUILD PROJECT YEAR: 2017

DRAWING RELEASE 2016 R3 GROUP

2016 R3

NEW

**GROUP** INCORPORATED

15500 NEW BARN ROAD SUITE 106 MIAMI LAKES , FLORIDA 33014 PHONE: (305) 558-4124 FAX: (305) 826-0619

PROJECT TYPE: USB NRE 55


REV. DATE


ISSUE DATE: PROJECT NUMBER DRAWN BY: CHECKED BY:

EDUARDO L. CARCACHE, PE 31914 ANA A. GONZALEZ VALDES, AR 97769 LUIS VARGAS, LEED AP #701023753163800 CKE GROUP, INC. COA-4432

> SHEET NAME TRASH ENCLOSURE

### US HIGHWAY #441 (STATE ROAD #7)

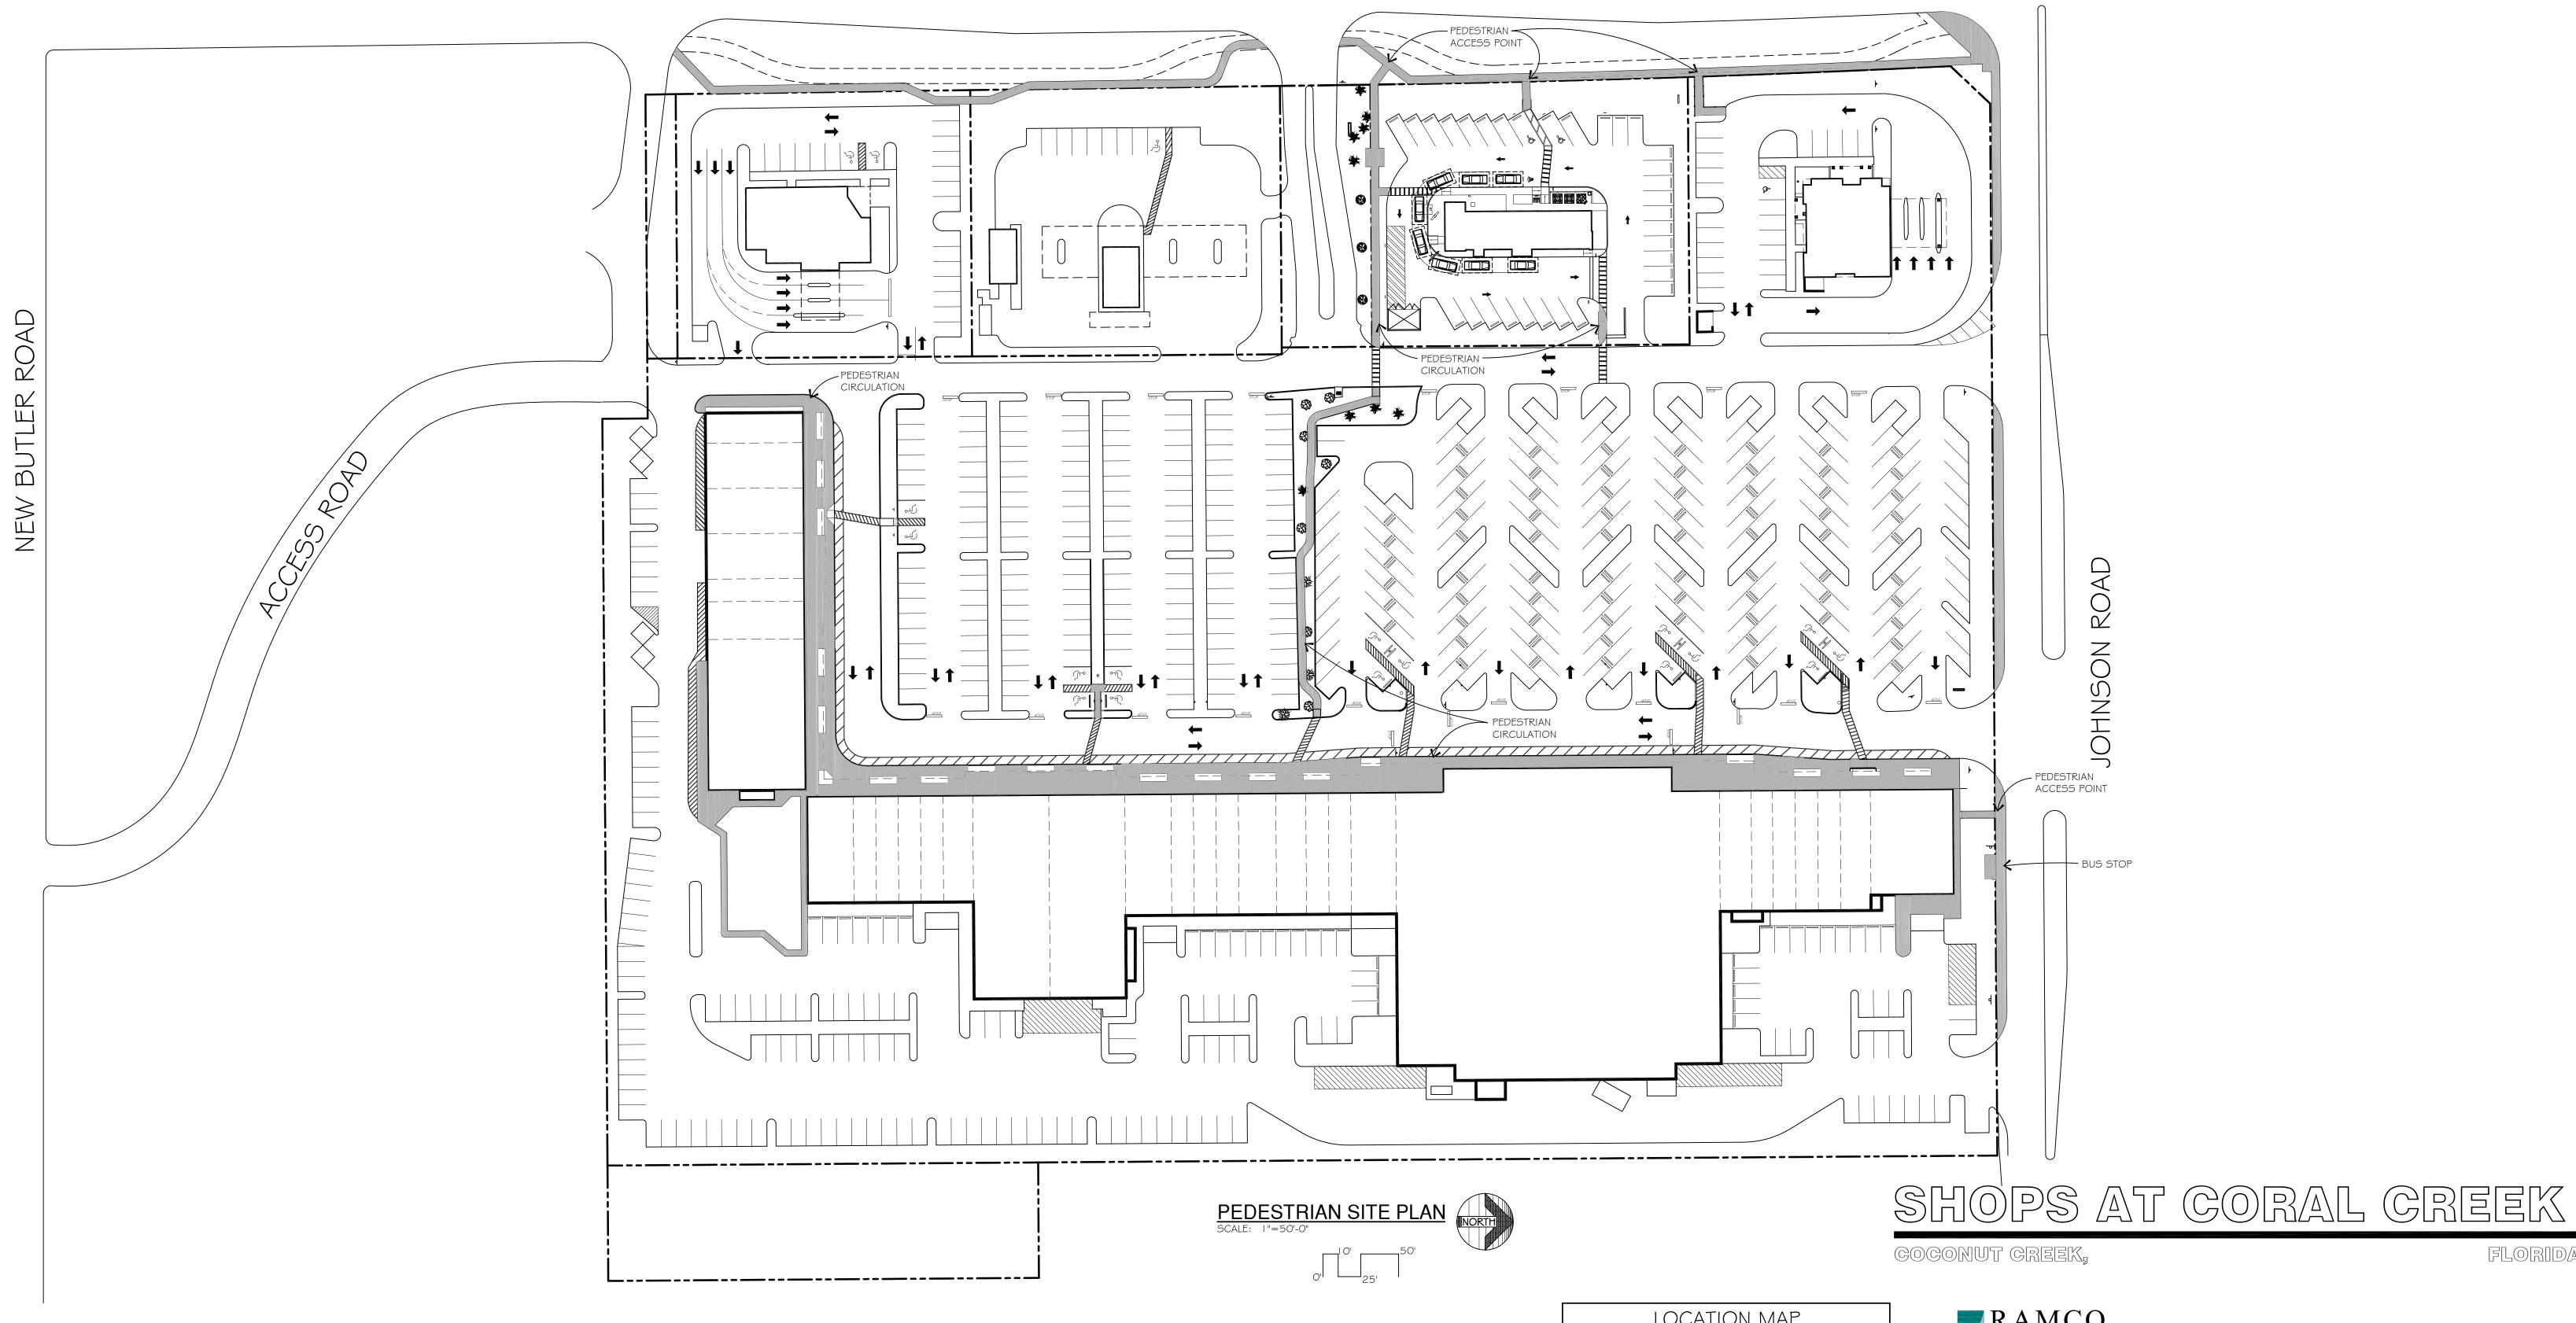

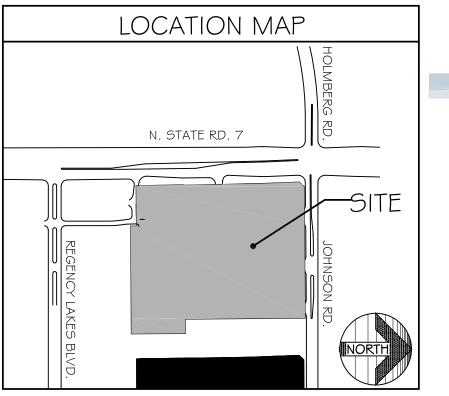





WAH YEE ASSOCIATES
ARCHITECTS & PLANNERS

42400 GRAND RIVER AVENUE, SUITE 200 NOVI, MICHIGAN 48375 PHONE 248.489.9160 PROJECT NO. 4889 All ideas, designs, arrangements, and plans indicated or represented by this drawing are owned by and the property of Wah Yee Associates and were created, evolved and developed for use on and in connection with the specified project. None of such ideas, arrangements, or plans shall be used by or disclosed to any person, firm or corporation for any purpose whatsoever without the written permission of Wah Yee Associates.

PRELIMINARY

NOT FOR CONSTRUCTION


SP-5



NOT TO SCALE


DESIGNS

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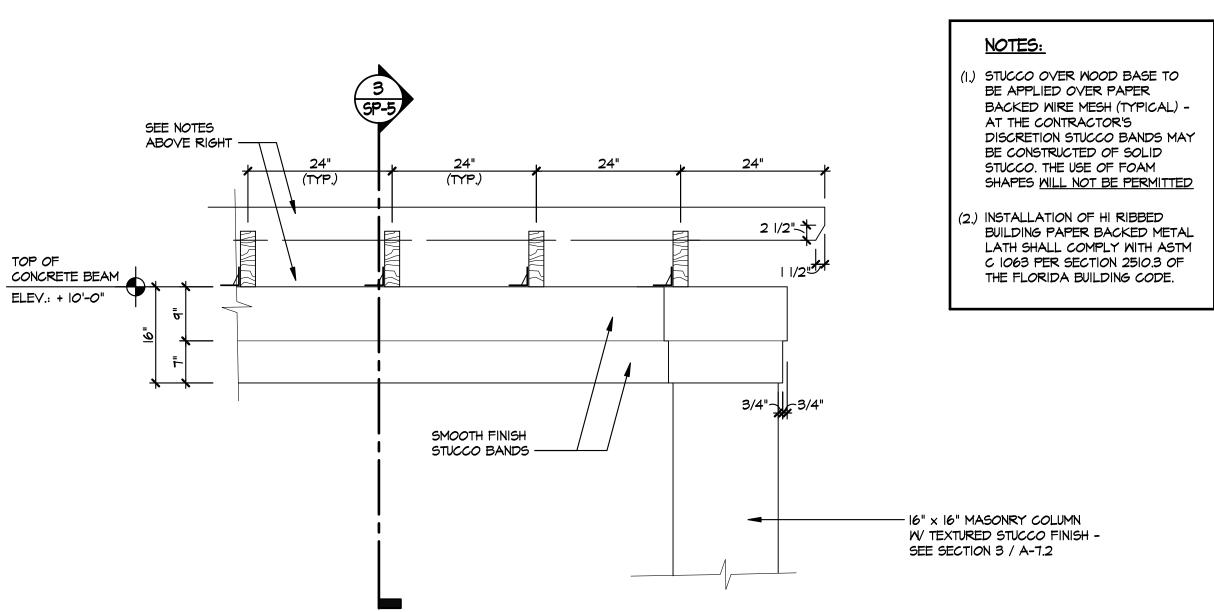


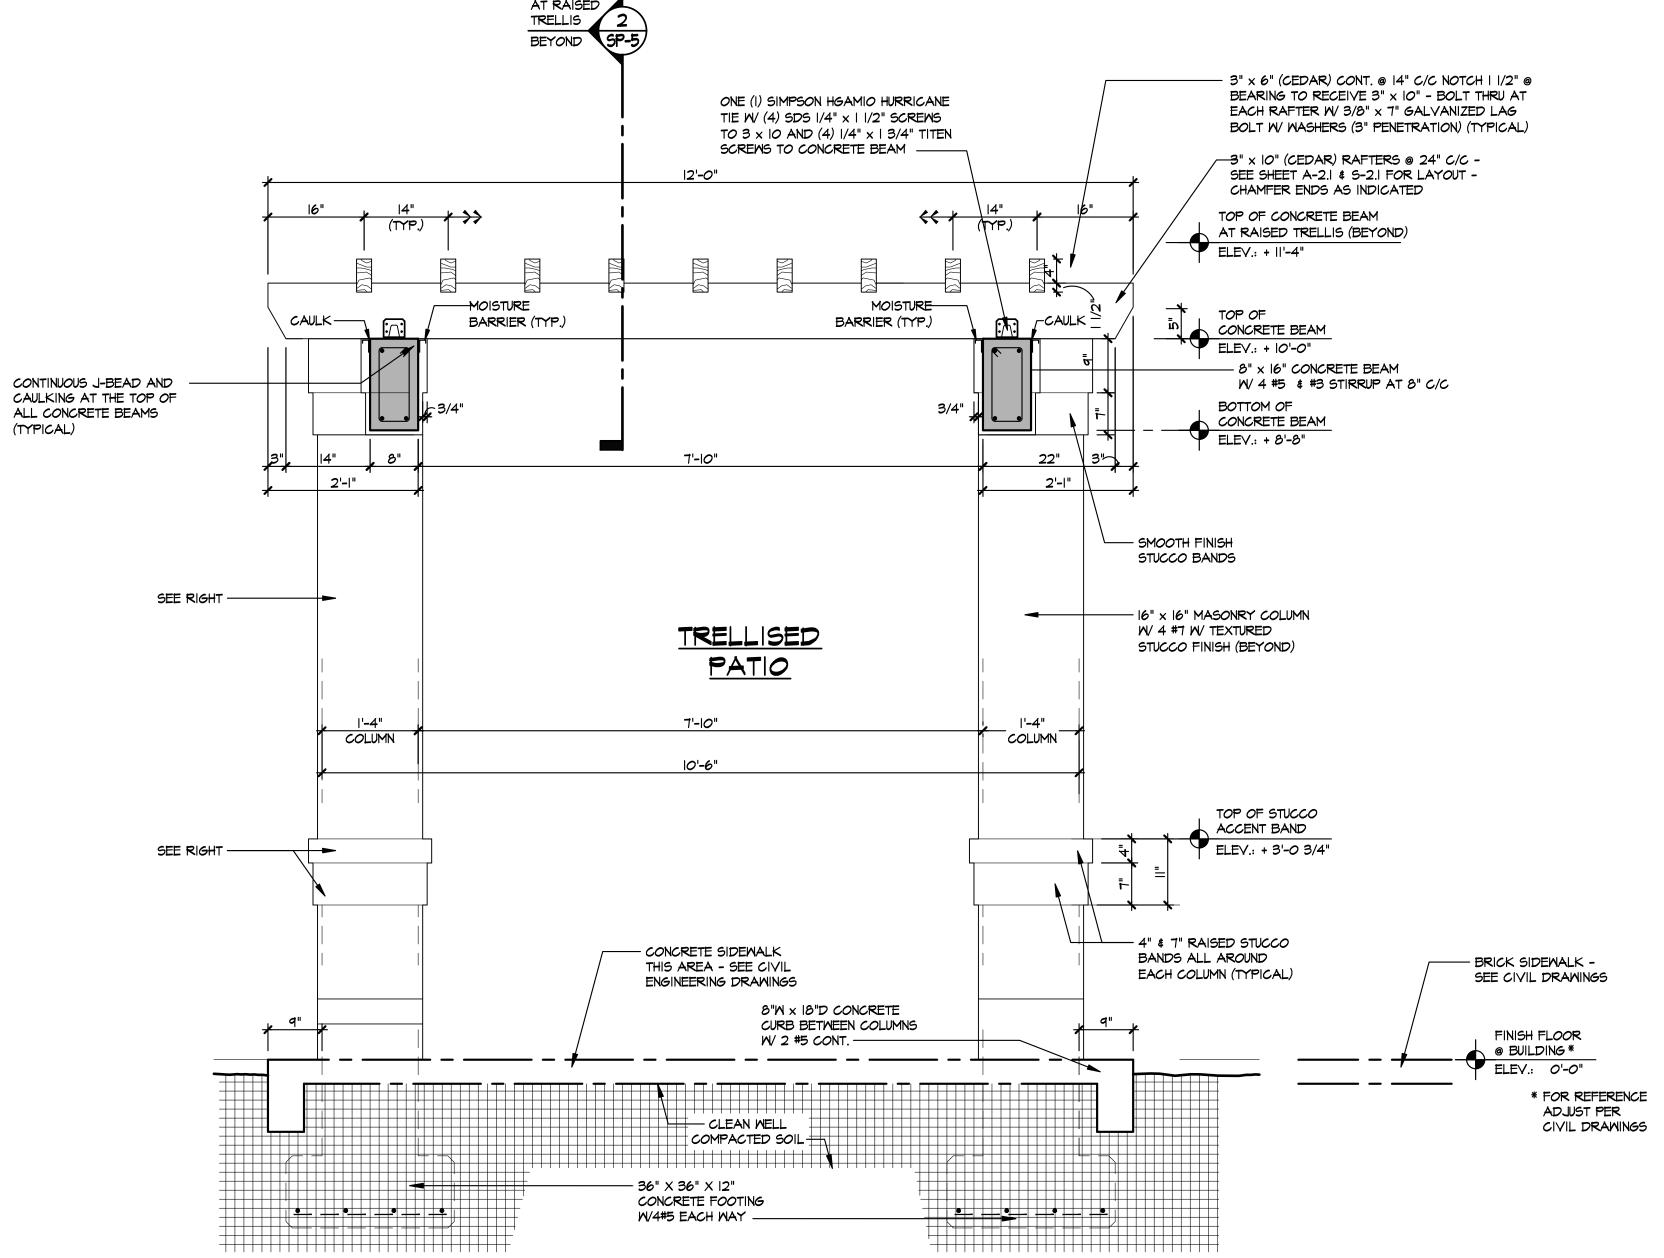SECTION AT FREE STANDING TRELLIS

SCALE: 3/4" = 1'-0"

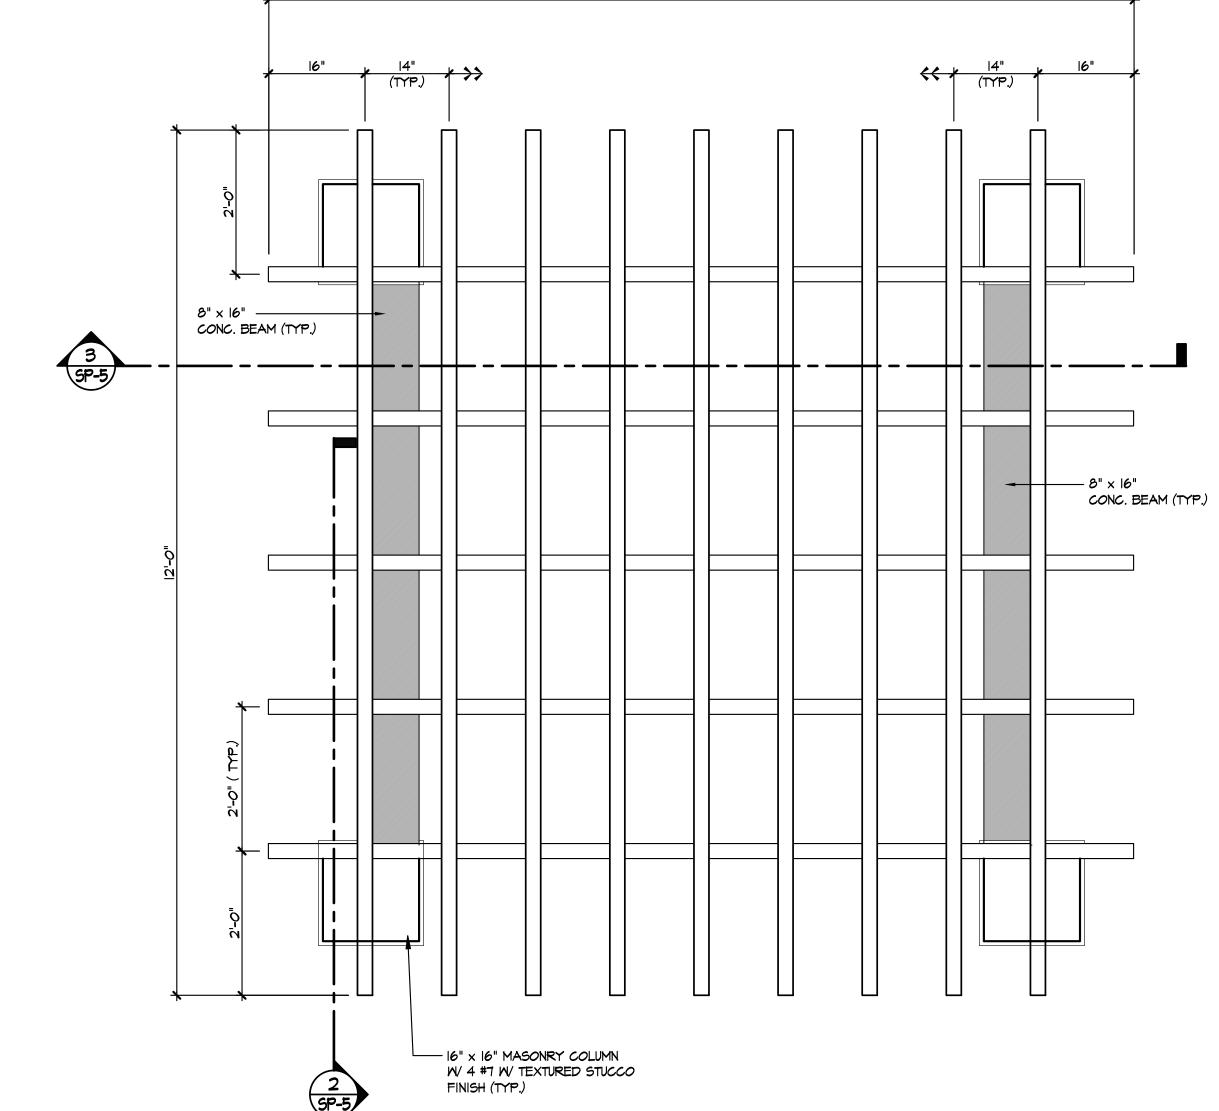


FREE STANDING TRELLIS FLOOR PLAN



SECTION AT TRELLIS SCALE: 3/4" = 1'-0" BASE MODEL: USB NRE 55 R3 ASSET TYPE: FRAN CLASSIFICATION: NEW OWNER: JAE REST. GROUP, LLC BASE VERSION: XXXXXXXX UPGRADE CLASSIFICATION: CORP. NEW BUILD PROJECT YEAR: 2017 FURNITURE PACKAGE: 2016 R3 DRAWING RELEASE 2016 R3

SITE NUMBER:

11670

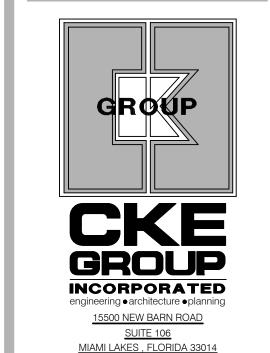

PROJECT TYPE: USB NRE 55 NEW

PHONE: (305) 558-4124 FAX: (305) 826-0619

REV. DATE 2 07-18-18 SEAL

EDUARDO L. CARCACHE, PE 31914 ANA A. GONZALEZ VALDES, AR 97769 LUIS VARGAS, LEED AP #701023753163800 CKE GROUP, INC. COA-4432 SHEET NAME

TRELLIS DETAILS

SHEET NUMBER



STATE ROAD No. 7 SECTION 6, TOWNSHIP 48 SOUTH, RANCE 42 EAST CITY OF COCONUT CREEK, BROWARD COUNTY, FLORIDA

# EGAL DESCRIPTION

A PORTICN OF TRACT "A", SANISASS PHRY OF COMMERCE CONNERGUA SECTION "B", ACCRONING ID THE PLAT THEREOF, AS RECORDED IN PAIR BOOK "144, PAIR 233, OF THE PIBLIC RECORDS OF SHOWING COUNTY, FLORIGA, BEING MORE PARTICULARY DESCRIBED AS FOLLOWS.

COMMODING THE SECTION VARIANCE CORRECT GOOD WITH, SECTION WERE CORRECT AND WITH SECTION WERE CONTRIBUTION. THE CORRECT WAS A CONTRIBUTION OF SECTION WERE CONTRIBUTION. THE SECTION WERE CONTRIBUTION WERE CONTRIBUTION OF WELL A SECTION WERE CONTRIBUTION. THE SECTION WERE CONTRIBUTION OF SECTION WERE CONTRIBUTION OF SECTION WERE CONTRIBUTION. THE SECTION WERE CONTRIBUTION OF SECTION WERE CONTRIBUTION OF SECTION SE

SAID LANDS STUARE, LINIG AND BEING IN THE CITY OF COCOMUT CREEK, BROWARD COUNTY, FLORIDA, CONTAINING 35,846 SQUARE FEET (0.8459 ACRES), MORE OR LESS.


### FLOOD ZONE

THE ABOVE DESCREED PROPERTY IS LOCATED IN TONE X (SHADED), IN ACCIDIANCE WITH THE FRM MAY OF THE CITY OF COCCOUNT CREEK, BROWARD COUNTY, COMMUNITY NAMEER 120031 (MAY NUMEER 12011C-0165-H), MAY DAVED AUGUST 18, 2014.

# CERTIFICATION

TO: WENDY'S PROPERTIES, ILC, AND FIDELITY NATIONAL TITLE INSURANCE COMPANY



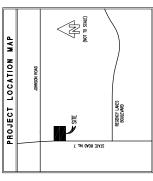

# NOTES CORRESPONDING TO SCHEDULE B, SECTION II

# DOLITY NATIONAL THE INSIRANCE COMPANY THE COMMINENT, COMMINENT GROER MANGER YZGOZGOTS TATED AFRI 6, 2016

S.) THE DRANAGE EASURNT, AS RECORDED IN O.R. BOOK 7804, PAGE 702, AS AFFECTED BY O.R. BOOK 18103, PAGE 554, DOES NOT AFFECT THE STE.

6.) THE EASEMENT, AS RECORDED IN O.R. BOOK 13272, PAGE 376, DOES NOT AFFECT THE SITE.

- .) The notice of adoption of develophent order, as recorded in or, book 1574, NAS 249, AS AFFECTED BY OR, BOOK 20006, PAGE 335 AND OR, BOOK 22105, PAGE 702, VFECTS THE STE (DOCS NOT CONTAIN ARY PLOTINGLE SURVEY MATTERS).
- I) THE DRAMME EASHENT, AS RECORDED IN OR, BOOK 16501, PAGE 99, AFFECTS THE STE, IS TO THE COMMANTS AND CONDITIONS CONTANED THEREIN. SAID EASHEDIT IS OFF—STE AND S NOT PLOTTED HEREON.

  - A) THE RECLARATION OF PROTECTING COMPANITS, CONDITIONS AND RESTRICTIONS FOR COURT
    CONTROLLE CENTRY AS RECORDS IN CONTROL AND ASSTAT CONTROL
    BOOK WOIT, PARE 751, LOS BOOK WORST, PARE 339, AND BOOK WOIT, PARE 751, LOS BOOK WORST, PARE 751 AND BOOK WOIT, PARE 751, LOS BOOK FOR THE TOTAL PARE 751 AND BOOK WOITH PROTEINS AND PROTEINS
    - 10.) The restrictive conemant, as recorded in O.R. Book 16571, page 799, does not 4fect the Ste.
- 11.) THE CROSS INGRESS/GORESS ACCESS AGREEMENT, AS RECORDED IN O.R. BOOK 16571, PAGE 7770, DOES NOT AFFECT THE SITE.
- 12) The vernorandum of Lease, as peconodo in Or. Book 16664, Page 606, Affects The Stie. The easements contained thesein are blanket in Nature and are not plotted Hericon.
- II.) THE CHOSS—PHRANG AND EASTHAIN ARRENDIN, AS RECORDED IN OR, BOOK 16785, PARE, 442, AFFECTS THE STIE. THE EASTHAINS CONTAMED THEREM AND EACHED IN NATURE, AND APE NOT PLOTED HEREON.
  - IA) THE WEWRANDIAN OF LEASE, AS RECORDED IN OR, BOOK 1718D, PAGE 258, AFFETS THE SITE. THE EASEMENTS CONTAINED THESEN AND BARWET IN ANTIDEE AND ARE NOT PLOTTED FERGIN.
- 15.) THE WAITE AND WASTERMITE AGREDIENT, AS RECORDED IN O.R. BOOK 17284, PAGE 928, MFECTS THE STIE (DOES NOT CONTAN ANY PLOTTABLE SURVEY MATTERS). 16.) THE PLAT OF SAWRANSS PARK OF COMMERCE COMMERCIAL SECTION "B", AS RECORDED IN MACHINE BY THE ACCESSION FROM THE PRODUCE WIRESS AND ERGESS LIKE, AS RECORDED IN O.P. BOOK 1834G, PAGE 439, AFFECTS THE STIFF ON-PETER AND THE SAME STIFF AND THE SAME STIFF AND THE SAME STIFF.
- 17.) THE DRAIME, EASIMENT, AS RECORDED IN O.R. BOOK 17981, PAGE 721, AFECTS THE STE AS TO THE TEXAS, COMEMANTS, CONDITIONS AND OBLIGATIONS CONTANED THEREN. SAID EASEMENT IS OFF-STE AND IS NOT PLOTTED HEREON.
  - IR.) THE EASINENT, AS RECORDED IN O.R. BOOK 18197, PAGE 974, DOES NOT AFFECT THE SITE.
    - THE WATER SERVICE UTLITY EASINENT, AS RECORDED IN O.R. BOOK 19227, PAGE 791, VFECTS THE STE. SAID EASINBHT IS BLANKET IN NATURE AND IS NOT PLOTTED HEREON.
- 20.) THE EASEMPTI RELOCATION AGREDIENT, AS RECORDED IN O.R. BOOK 23348, PAGE 89, AS MONIFIED BY O.R. BOOK 24425, PAGE 36, DOES NOT AFFECT THE SITE. 21.) THE EASTMENT, AS RECORDED IN O.R. BOOK 23822, PAGE 57, DOES NOT AFFECT THE SITE. (22) THE RESTRICTINE CONEMNT, AS RECORDED IN OR. BOOK 31581, PAGE 889, AS AFFECTED BY DR. BOOK 33NG, PAGE 743, AFFECTS THE STE (DICES NOT CONTAN ANY PLOTTABLE SURVEY MATTERS).
- 23.) THE FINNONG STARLIDH, AS RECORDED IN OR, BOOK 44689, PAGE 754, AS AFFECTED By Ore Book 49106, PAGE 880, AFFECTS THE STE (DACS NOT CONTAIN ANY PLOTTABLE SIRVEY MATTERS).
- THE NOTICES, AS RECORDED IN OR, BOOK 167%S, PAGE 440 AND O.R. BOOK 3419S, PAGE AFFECT THE SITE (DO NOT CONTAN ANY PLOTTABLE SURVEY MATTERS). 24.) THE GRANT OF EXCLUSIVE UTLITY EASINENT, AS RECORDED IN O.R. BOOK 45336, PAGE 806, AFFECTS THE SITE. SHO EASINENT IS BLANKET IN NATURE AND IS NOT PLOTTED HEREON.

# ZONING and SETBACK NOTES

- 1.) ZONED: B-3 (COMMUNTY SHOPPING DISTRICT) 2) BULDING SETBACKS:
- note. The above data was obtaned from the city of cocconut obere land development coe a found on manicode.com.

# **SURVEY ABBREMATIONS**



+ ABREVATORS MAY ALSO BE OXIXATBATED AS REQUEED.
 + OTHER COMMENT REDISABLED MIN/CR ACCEPTED ABREVATORS ME. ALSO UTILIZED BUT NOT SYCOPED HERED

### GENERAL NOTES

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() THIS STRIKEY SHALL BE VALUE FOR ONE (1) YEAR FROM THE DATE OF FIELD SURVEY SHOWN HERON.

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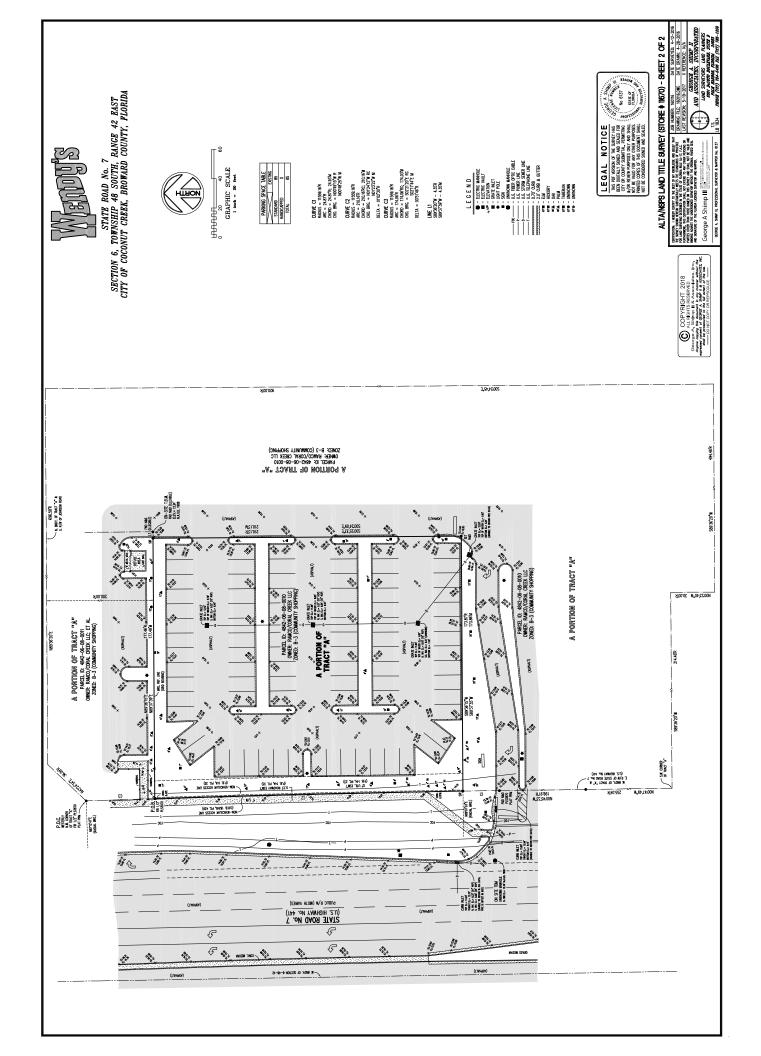
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JOHNSON SQUARE, INC GENERAL PARTNER OF

ASSOCIATES LTD.

ASSOCIATES, LTD.

INSURANCE COMPAN)

CITY OF COCONUT CREEK OFFICIAL CITY SEAL

CITY OF COCONUT CREEK TTY ENGINEER'S SEAL

SHEET I OF I

"EL RANCHO SEVEN PLAT" (P.B. 101, PG. 25) SEC. 6, TWP. 485., RGE. 42E. COMMERCE COMMERCIAL BLOCK SECTION "B" THE PALM BEACH FARMS CO. PLAT NO. 64 | 65 | 66 | 67 | 68

(N.G.V.D.) of 1929 in conformity with standards adopted by the National Ocean

Permanent Control Points (P.C.P.'s) will be set within one year of the date

this Plat is recorded or prior to the expiration of the bond or other surety

POST, BUCKLEY, SCHUH & JERNIGAN, INC.

Professional Land Surveyor No. 4408


insuring construction of the required subdivision improvements.

Survey for third order control standards.

Date: JULY 17th, 1989

# SAWGRASS PARK OF COMMERCE COMMERCIAL SECTION "B"

A REPLAT OF PORTIONS OF TRACTS 62 and 63, LYING IN BLOCK 85 OF "THE PALM BEACH FARMS CO. PLAT NO. 3" (P.B. 2, PG. 53 P.B. C. RECORDS) IN SECTION 6, TOWNSHIP 48 SOUTH, RANGE 42 EAST CITY OF COCONUT CREEK, BROWARD COUNTY, FLORIDA

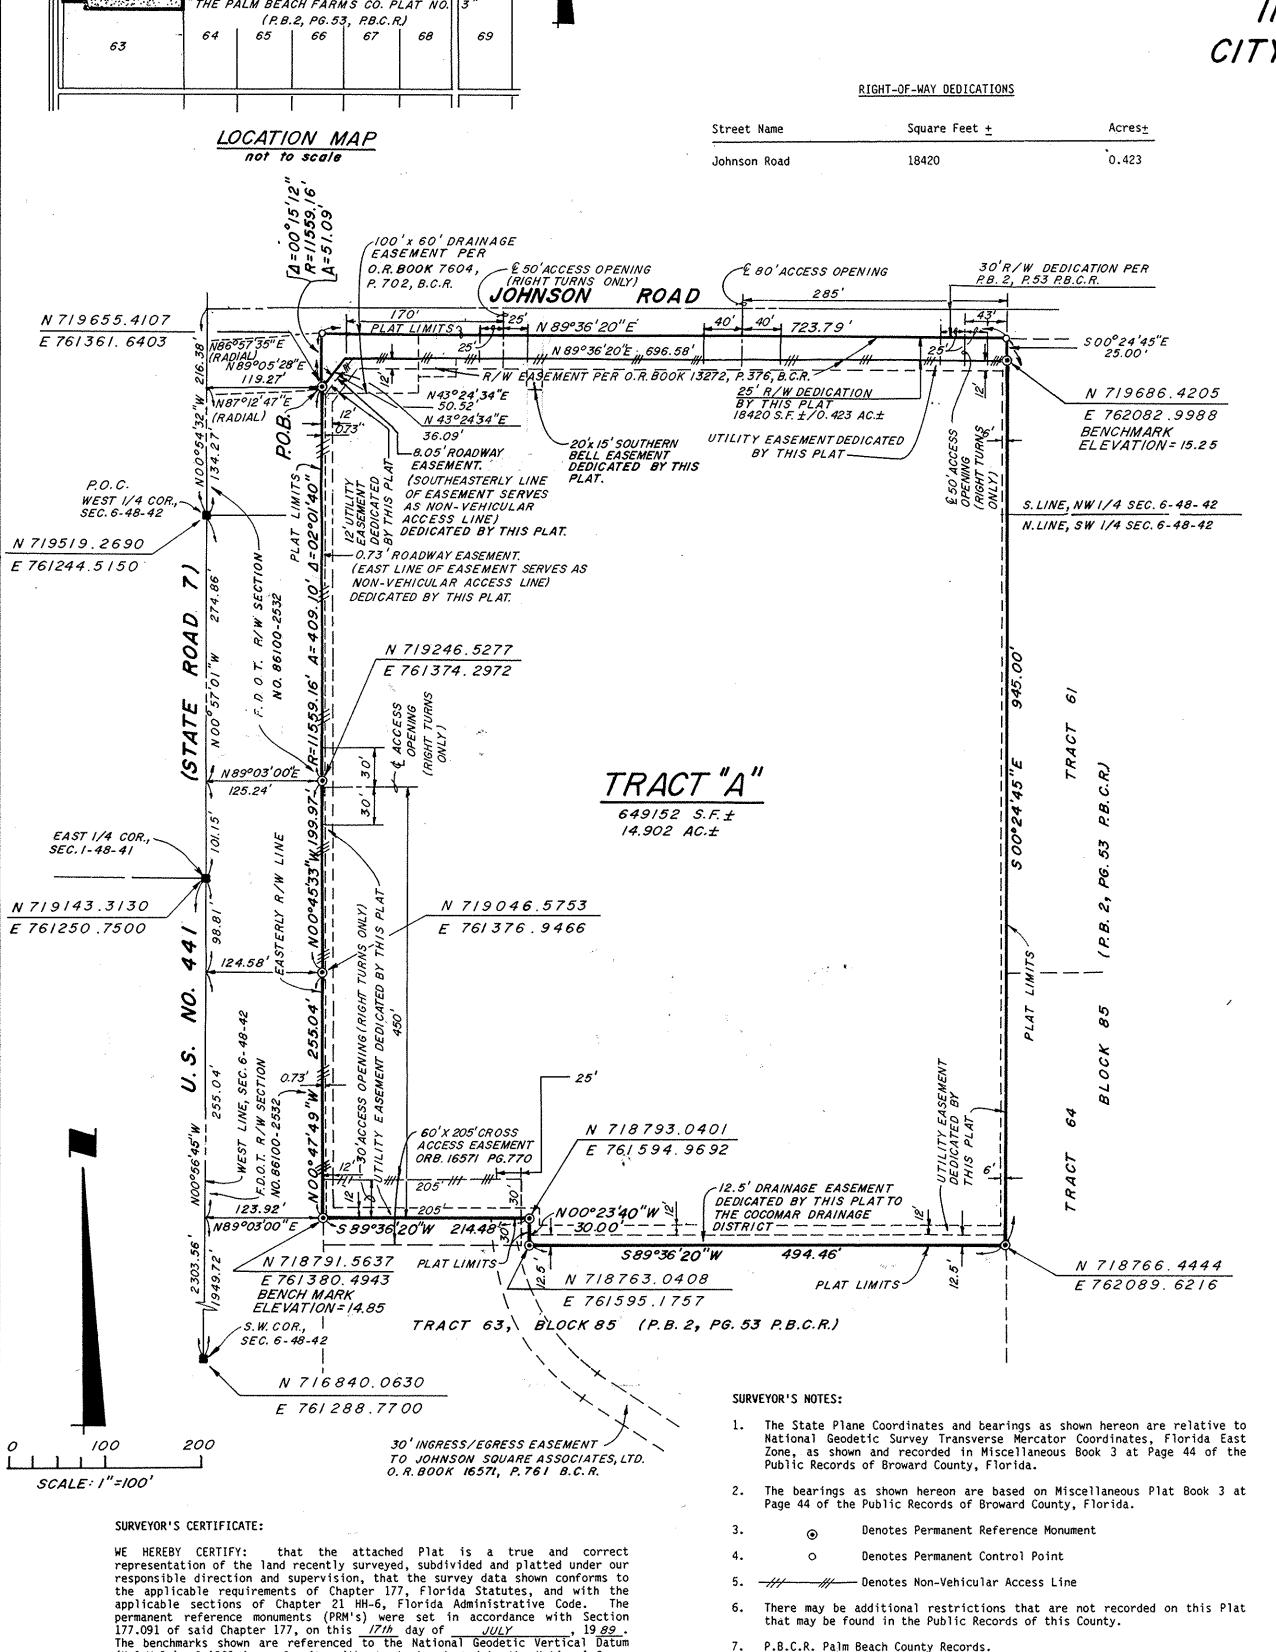

7. P.B.C.R. Palm Beach County Records.

9. Broward County Benchmark reference: Broward County Engineering

Division - Benchmark BC 1320, a 1/2 iron pipe in center line of N.W. 62nd

Terrace at the north edge of pavement of Holmberg Road. Elevation = 17.033.

8. B.C.R. Broward County Records.

#### POST, BUCKLEY, SCHUH & JERNIGAN, INC.

ENGINEERS, PLANNERS, LAND SURVEYORS 8600 N.W. 36th STREET MIAMI, FLORIDA 33166-6622 TEL. (305) 592-7275



#### CITY OF COCONUT CREEK

This is to certify that this plan has been approved by the Planning and Zoning Board of the City of Coconut Creek, Florida, this 11 day of January,

This is to certify that this plat has been approved for record by the City Council of the City of Coconut Creek by Ordinance No. 22-37 adopted this 22 day of January, A.D. 1927, pursuant to Ordinance No. 120-18.

#### BROWARD COUNTY FINANCE AND ADMINISTRATIVE SERVICES DEPARTMENT.

This is to certify that this Plat complies with the provisions of Chapter 177, Florida Statutes, and was accepted for record by the Board of County

Attest: L.A. Hester County Administator CREATED OCT. 1ST 1915

#### BROWARD COUNTY ENGINEERING DIVISION

This Plat is hereby approved and accepted for record

#### BROWARD COUNTY OFFICE OF PLANNING

This Plat is hereby approved and accepted for record.

#### BROWARD COUNTY PLANNING COUNCIL

This is to certify that the Broward County Planning Council approved this plat subject to its compliance with dedication of rights-of-way for trafficways by resolution adopted this 25th day of May

This plat complies with the resolution of the Broward County Planning Council of the above date and is approved and accepted for record this day of


#### BROWARD COUNTY FINANCE AND ADMINISTRATIVE SERVICES DEPARTMENT COUNTY RECORDS, DIVISION - RECORDING SECTION

This instrument was filled for record this day of A.D., 19 and recorded in Plat Book/44, page 3



BROWARD COUNTY PLAT RESTRICTIONS

This Plat is restricted to 120,000 square feet of commercial use. This note is required by Chapter 5, Article IX, Broward County Code of Ordinances and may be amended by agreement with Broward County. The notations and any amendments thereto are solely indicating the approved development level for property located within the plat and do not operate as a restriction in favor of any property owner including an owner or owners of property within this plat who took title with reference to this plat.

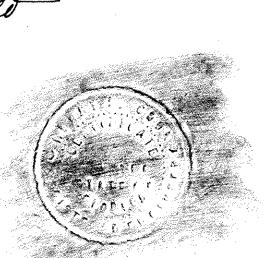

included in this Plat, has caused to be surveyed, subdivided and platted in a manner as shown, to be known as "SAWGRASS PARK OF COMMERCE COMMERCIAL SECTION

The easements and right-of-way as shown on this Plat are hereby dedicated to the perpetual use of the public for the purposes indicated. This plat shall

#### LEGAL DESCRIPTION

A portion of Tracts 62 and 63, Block 85, THE PALM BEACH FARMS CO. PLAT NO. 3, according to the Plat thereof, as recorded in Plat Book 2 at Page 53 of the Public Records of Palm Beach County, lying in the City of Coconut Creek, Broward County, Florida, being more particularly described as follows:

Commence at the West 1/4 corner of Section 6, Township 48 South, Range 42 East in Broward County, Florida; thence run N00<sup>0</sup>54'32"W along the West line of said to the POINT OF BEGINNING: said point being on the arc of a circular curve concave to the west and said point bearing N87012'47"E from the center of said curve; thence run northerly along the arc of said curve having a radius of 11559.16 feet and a central angle of  $00^{\circ}15"12"$  for 51.09 feet to a point of said curve; thence run N89036'20"E for 723.79 feet to a point; thence run S00°24'45"E for a distance of 945.00 feet to a point; thence run S89°36'20"W

thence run NOOO23'40"W for a distance of 30.00 feet to a point; thence the Easterly Right-of-Way line of U.S. No. 441 (State Road 7); thence run NOOO47'49"W, along said Right-of-Way line for a distance of 255.04 feet to a point; thence run NOOO45'33"W, along said Right-of-Way line, for a distance of 199.97 feet to a Point of Curvature of a circular curve to the left having for its elements a central angle of 02001'40" and a radius of 11559.16 feet; thence run northerly along said Right-of-Way line and along the arc of said curve, for a distance of 409.10 feet to the POINT OF BEGINNING.

#### Containing 15.325 Acres more or less.

In Witness Whereof: Said Johnson Square Associates, Ltd., a Florida Limited partnership, by and through its general partner, Johnson Square, Inc., a Florida corporation, has caused these presents to be executed in its name by its general partner, Johnson Square, Inc., a Florida corporation, to be signed in its corporate name by its prescipent. and its corporate seal to be herewith affixed and attested to by its secretary, this day of hugust. A.D. 1989.

#### Florida Limited Partnership, by and through its general partner, Johnson

Square, Inc., a florida corporation

Name: Ellen Rose Title: Secretary

#### **ACKNOWLEDGEMENT**

State of Florida County of Dade

HOTARY PUBLIC STATE OF FLORIDA

I hereby certify that on this day personally appeared before me an officer duly authorized to administer oaths and take acknowledgements, sien Rose and respectively, to me well known to be officers herein described and who executed the foregoing Plat and Instrument of Dedication and acknowledged the execution thereof to be their free act and deed as such officers for the purposes therein

Witness my signature and official seal at CORAL GABLES Dade · County, Florida this 2 day of August A.D. 1989 My Commission Expires:

# BONDED Date PREAL INS. UND.

KNOW ALL MEN BY THESE PRESENTS: That Northwestern Mutual Life Insurance Company, a Wisconsin corporation, owner and holder of that certain mortgage recorded on 70273,1989 in Official Records Book#6571 at Page 778 of the Public Records of Broward County, Florida, does hereby consent to this Plat and joins in the above dedication.

In Witness Whereof: Northwestern Mutual Life Insurance Company, a Wisconsin corporation, has caused these presents to be signed in its corporate name by its Vice President and its corporate seal to be herewith affixed and attested by its Ass't Secretary this 1th day of August ,

#### THE Northwestern Mutual Life Insurance Company

Name: 620 N. Hewitt Title: Asst Secretary

Title: Vice President

#### **ACKNOWLEDGEMENT**


I hereby certify that on this day personally appeared before me an officer duly authorized to administer oaths and take acknowledgements, Carson D. Keyes and Garu H Hewart, Vice President and Ass't Secretary respectively, to me well known to be officers herein described and who executed the foregoing instrument and acknowledged the execution thereof to be their free act and deed as such officers for the purposes therein described.

Witness: My hand and official seal at Howarkee County, Wisconsin, this 14th day of August A.D. 1989

My commission expires: January 76, 1992 CARLOS M. DEL VALLE, PLS PROFESSIONAL LAND SURVEYOR NO. 4408 SURVEYOR'S OFFICIAL SEAL

BROWARD COUNTY, FLORIDA

OFFICIAL SEAL

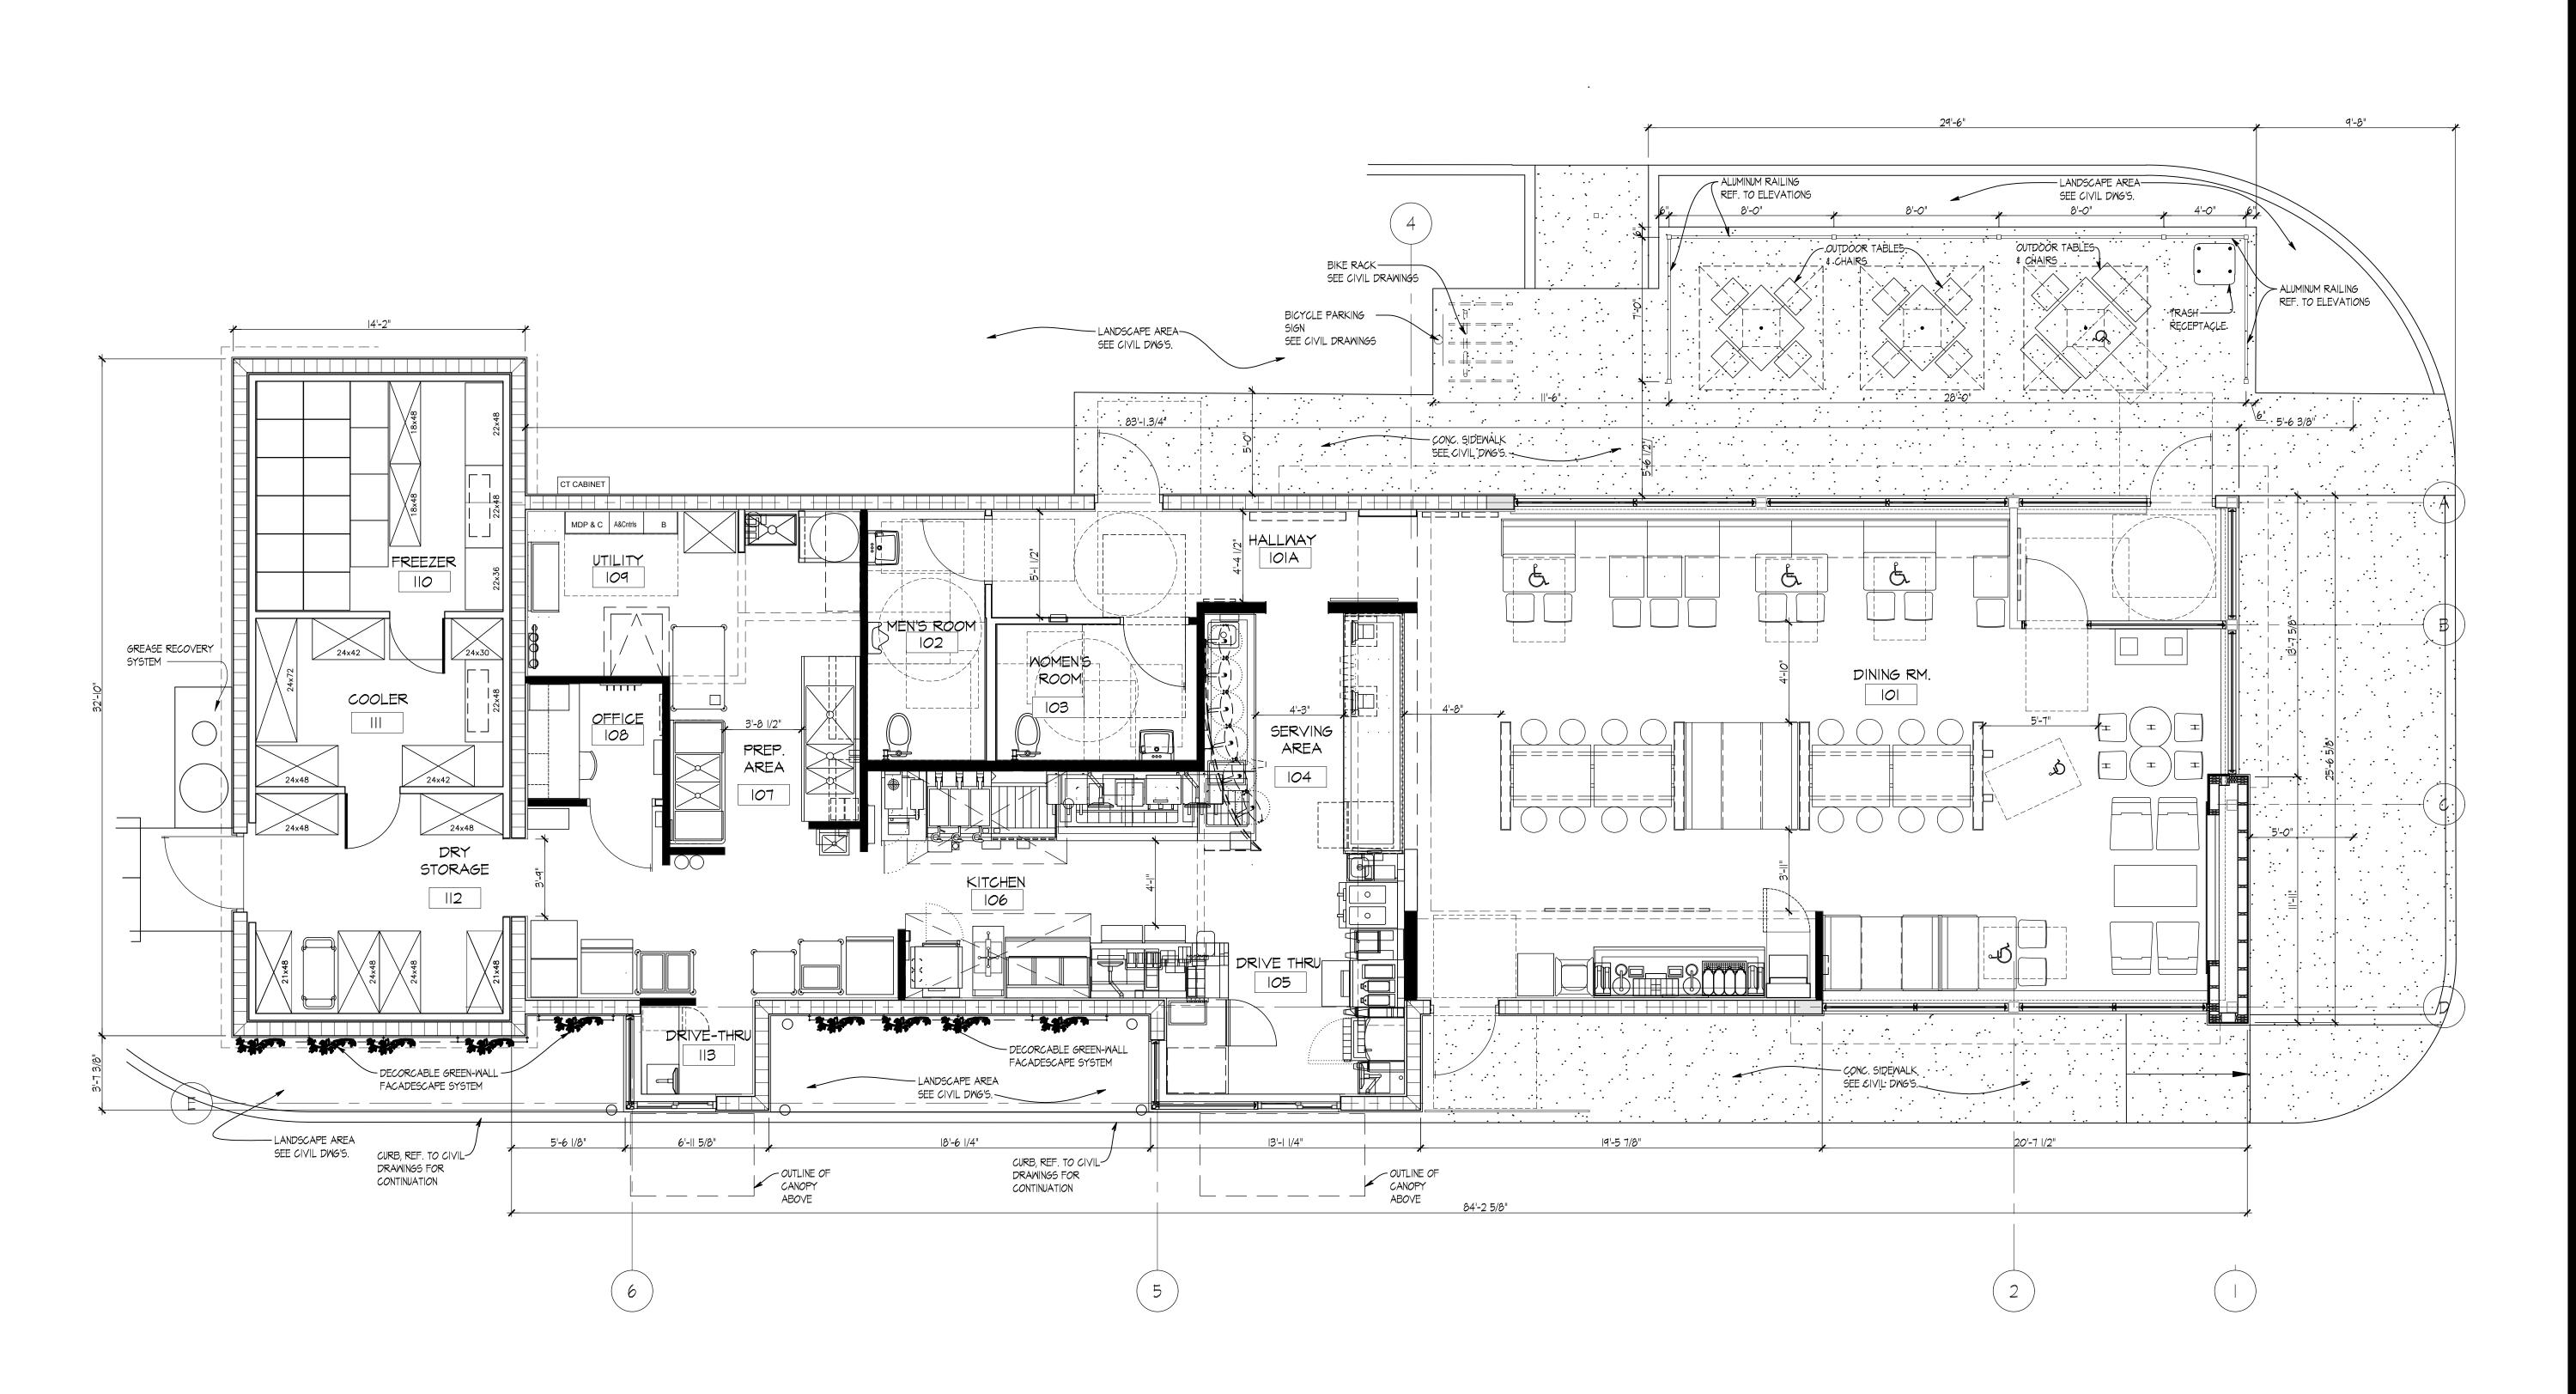






SITE NUMBER: BASE MODEL: USB NRE 55 R3 ASSET TYPE: CLASSIFICATION: OWNER: JAE RESTAURANT GROUP, LLC BASE VERSION: XXXXXXXX

UPGRADE CLASSIFICATION: CORP. NEW BUILD PROJECT YEAR: FURNITURE PACKAGE: 2016 R3 DRAWING RELEASE 2016 R3

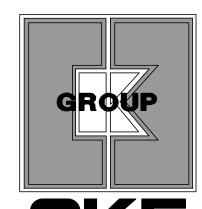

INCORPORATED engineering • architecture • planning 15500 NEW BARN ROAD

SUITE 106 MIAMI LAKES , FLORIDA 33014 PHONE: (305) 558-4124 FAX: (305) 826-0619


PROJECT TYPE: USB NRE 55


/1\ 5/1/2018

PROJECT NUMBER:

EDUARDO L. CARCACHE, PE 31914 ANA A. GONZALEZ VALDES, AR 97769 CKE GROUP, INC. COA-4432

FLOOR PLAN

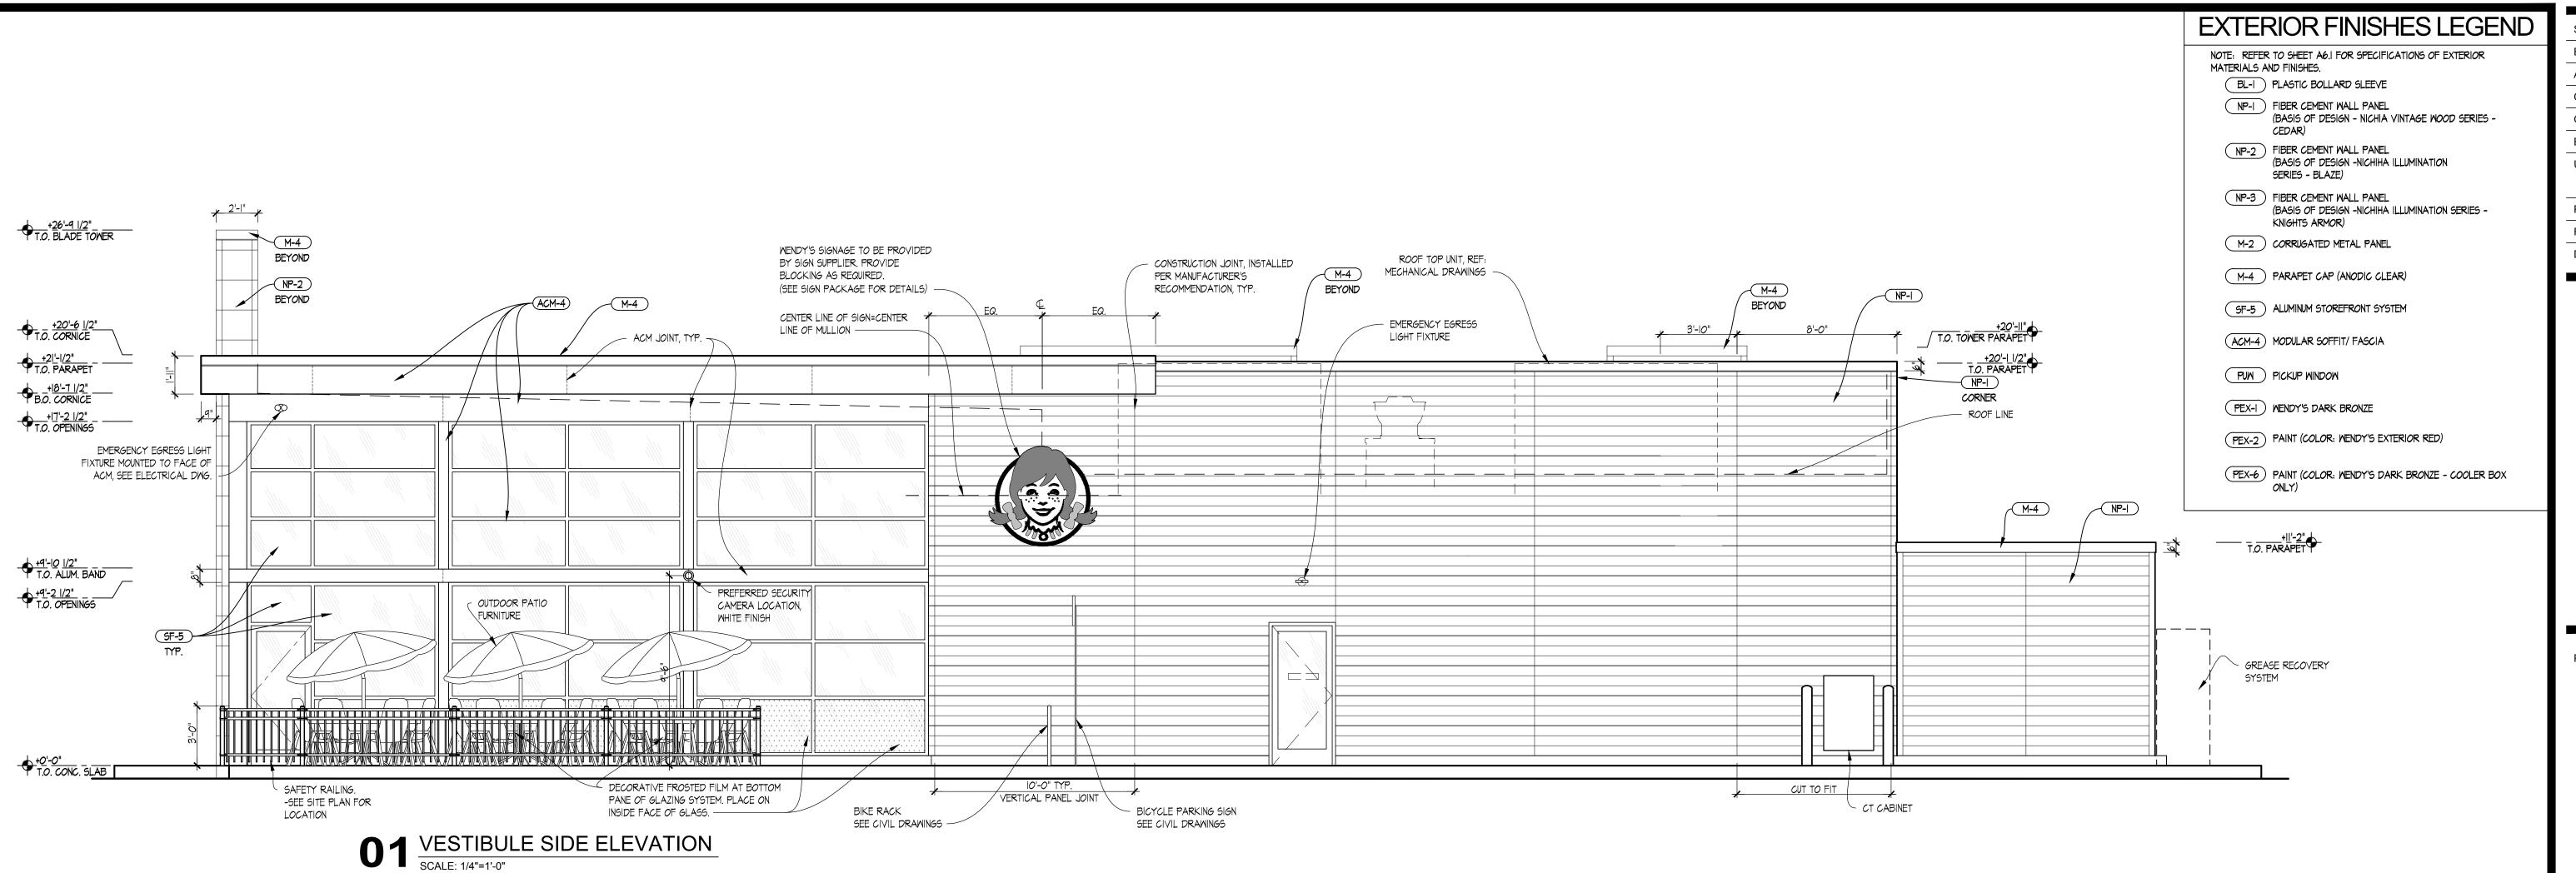

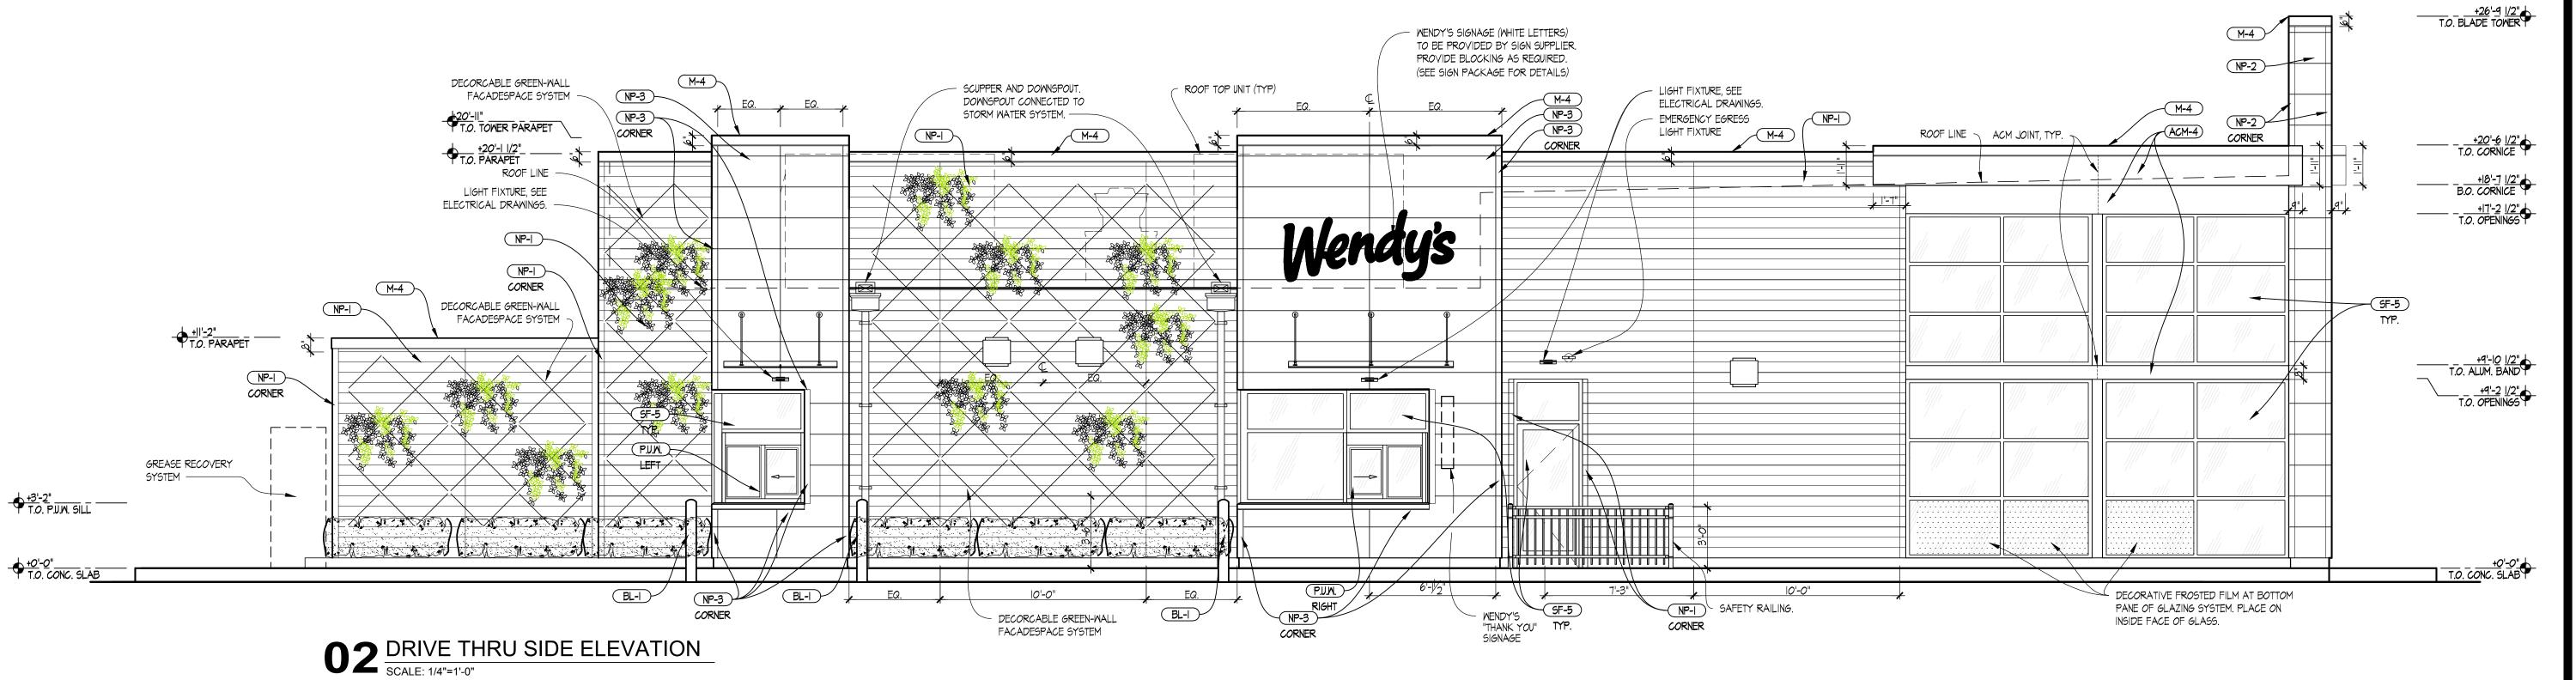

SITE NUMBER: BASE MODEL: USB NRE 55 R3 ASSET TYPE: FRAN CLASSIFICATION: NEW OWNER: JAE RESTAURANT GROUP, LLC BASE VERSION: XXXXXXXX UPGRADE CLASSIFICATION: CORP. NEW BUILD PROJECT YEAR: 2017 FURNITURE PACKAGE: 2016 R3 DRAWING RELEASE 2016 R3



GROUP
INCORPORATED
engineering • architecture • planning
15500 NEW BARN ROAD

SUITE 106

MIAMI LAKES , FLORIDA 33014

PHONE: (305) 558-4124

FAX: (305) 826-0619

NEW

PROJECT TYPE: USB NRE 55

# 11670 # 11670

REV. DATE DESCRIPTION

5/I/2018

ISSUE DATE: 05/12/2017

PROJECT NUMBER: 1493


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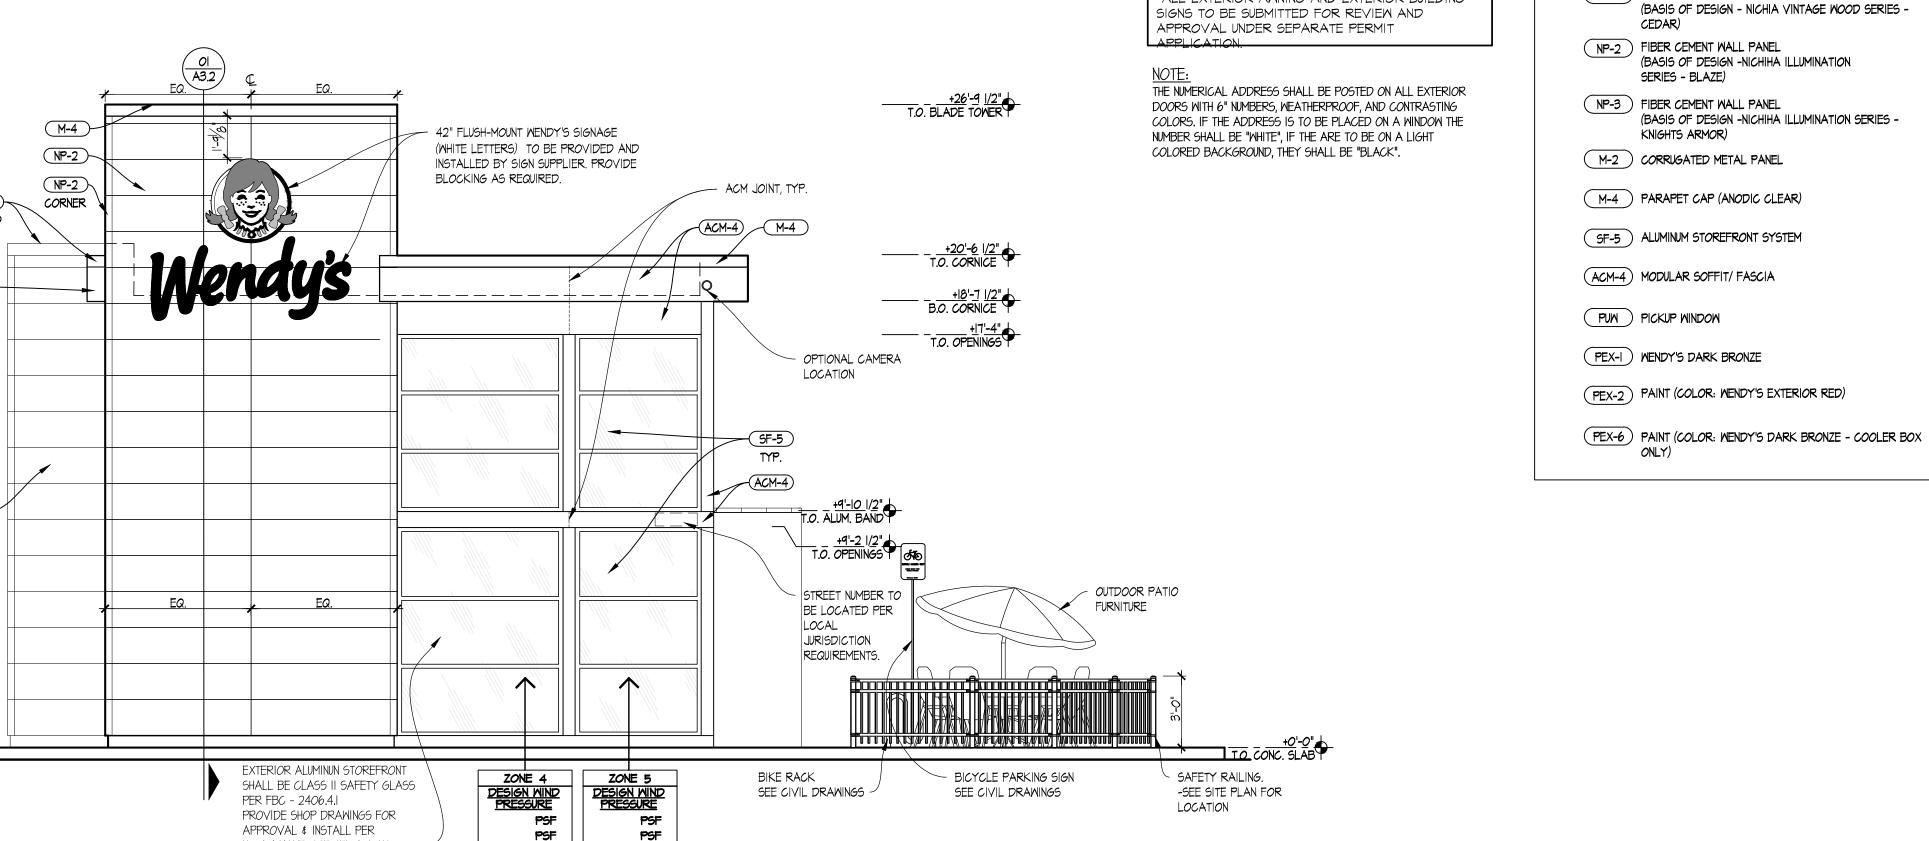
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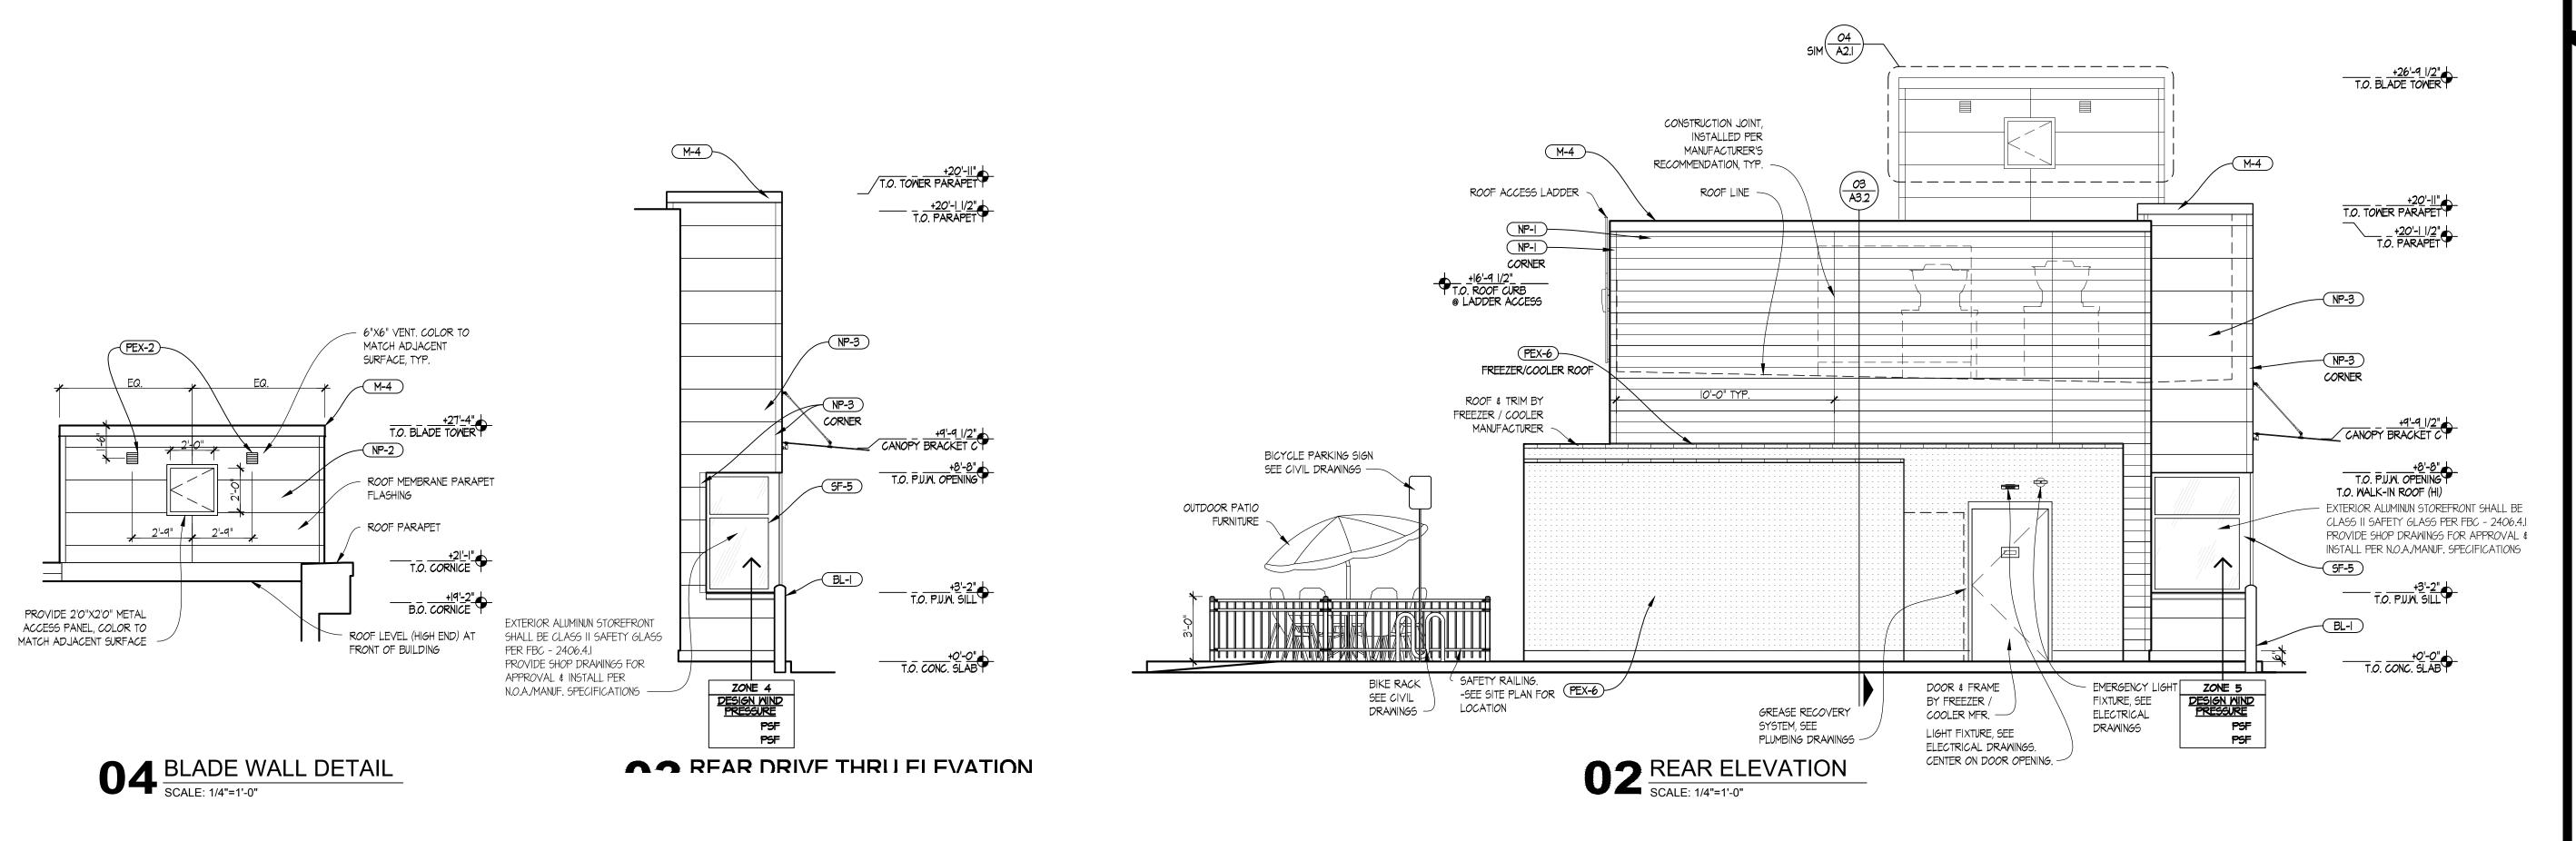
EXTERIOR ELEVATIONS

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A2.1





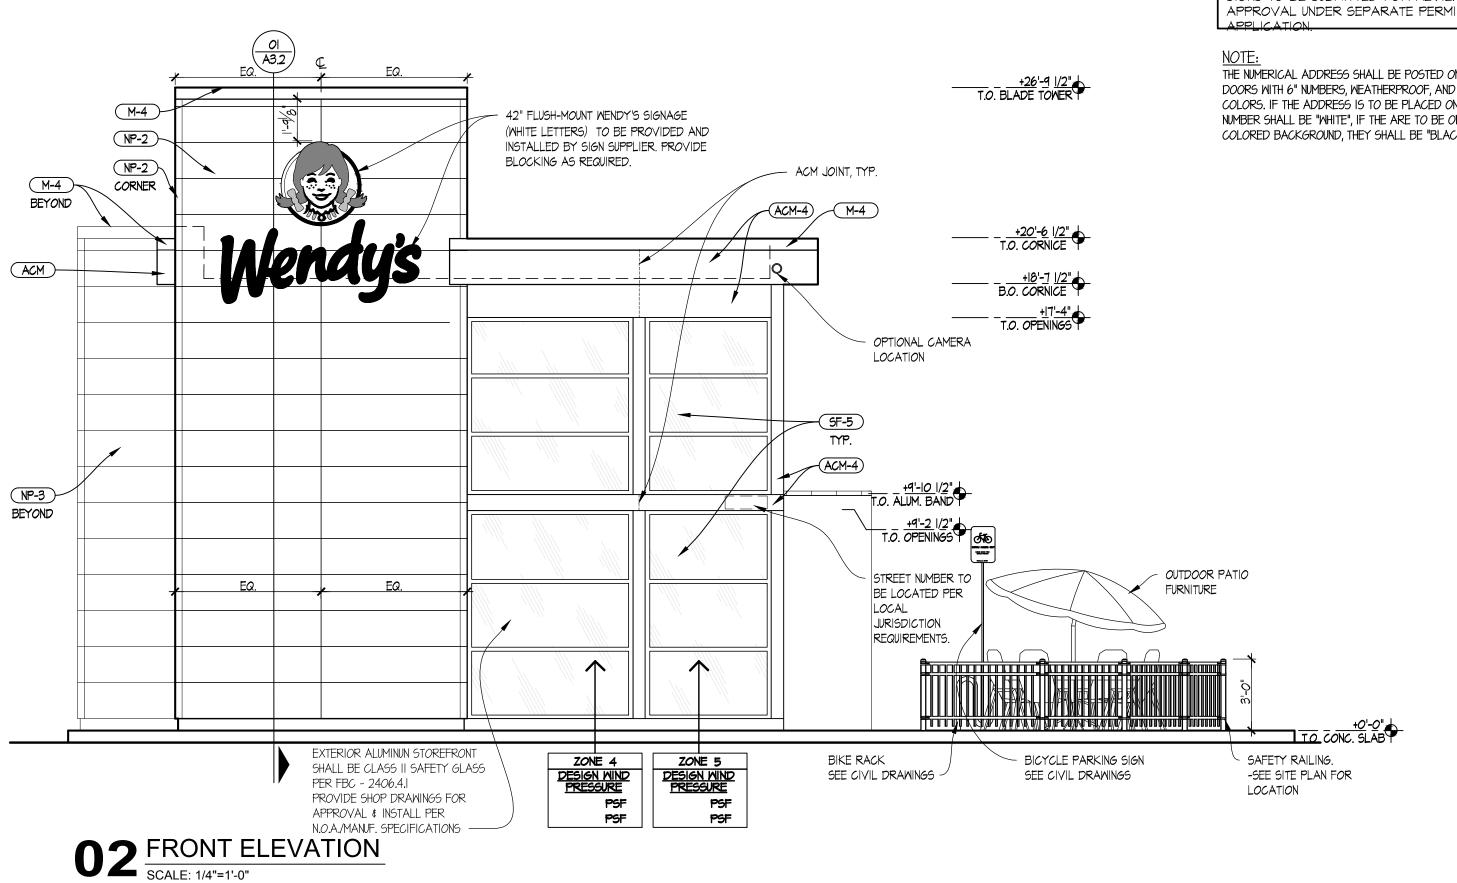

EXTERIOR FINISHES LEGEND SITE NUMBER: BASE MODEL: USB NRE 55 R3 ASSET TYPE: CLASSIFICATION: NEW OWNER: JAE RESTAURANT GROUP, LLC BASE VERSION: XXXXXXXX UPGRADE CLASSIFICATION: CORP. NEW BUILD PROJECT YEAR: 2017 FURNITURE PACKAGE: 2016 R3 DRAWING RELEASE 2016 R3

NOTE: REFER TO SHEET A6.1 FOR SPECIFICATIONS OF EXTERIOR

MATERIALS AND FINISHES.

ALL EXTERIOR AWNING AND EXTERIOR BUILDING

BL-I PLASTIC BOLLARD SLEEVE

NP-I FIBER CEMENT WALL PANEL



**INCORPORATED** 

15500 NEW BARN ROAD <u>SUITE 106</u> MIAMI LAKES , FLORIDA 33014 PHONE: (305) 558-4124 FAX: (305) 826-0619


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NEW

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EDUARDO L. CARCACHE, PE 31914 ANA A. GONZALEZ VALDES, AR 97769 CKE GROUP, INC. COA-4432


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SITE NUMBER: BASE MODEL: USB NRE 55 R3 ASSET TYPE: CLASSIFICATION: NEW OWNER: JAE RESTAURANT GROUP, LLC BASE VERSION: XXXXXXXX UPGRADE CLASSIFICATION: CORP. NEW BUILD PROJECT YEAR: 2017 FURNITURE PACKAGE: 2016 R3

DRAWING RELEASE

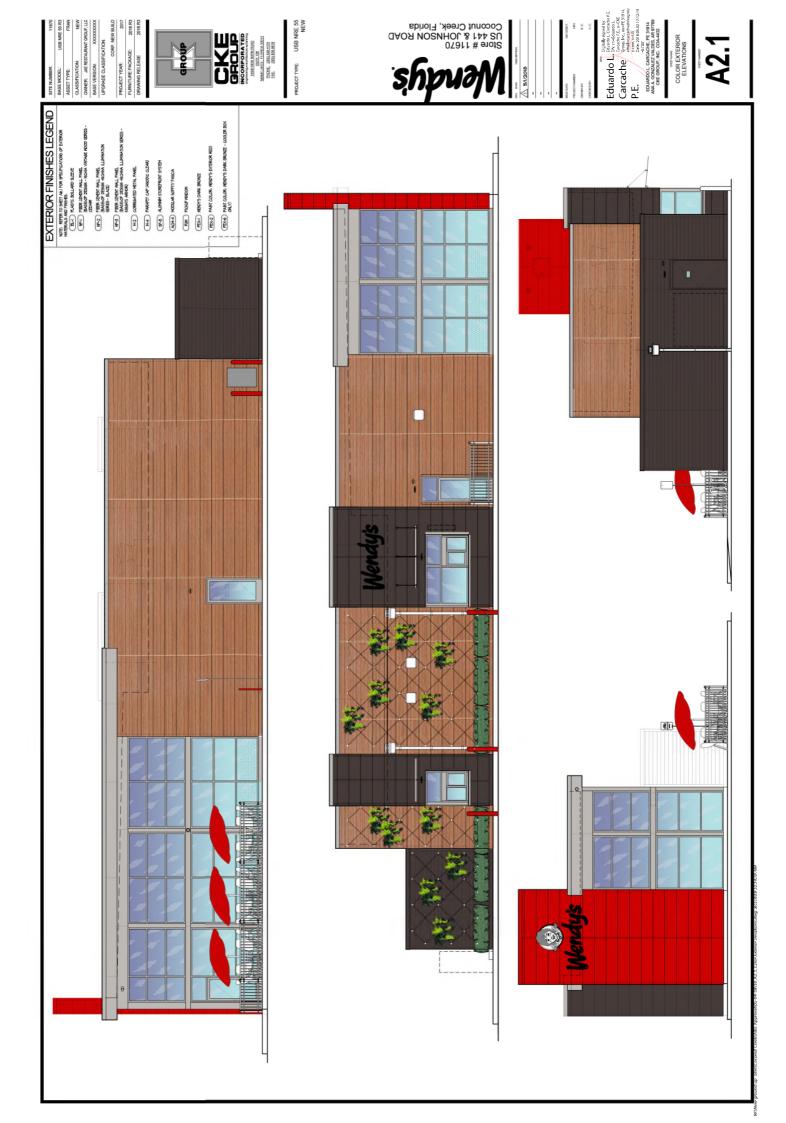

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15500 NEW BARN ROAD SUITE 106 MIAMI LAKES , FLORIDA 33014 PHONE: (305) 558-4124 FAX: (305) 826-0619


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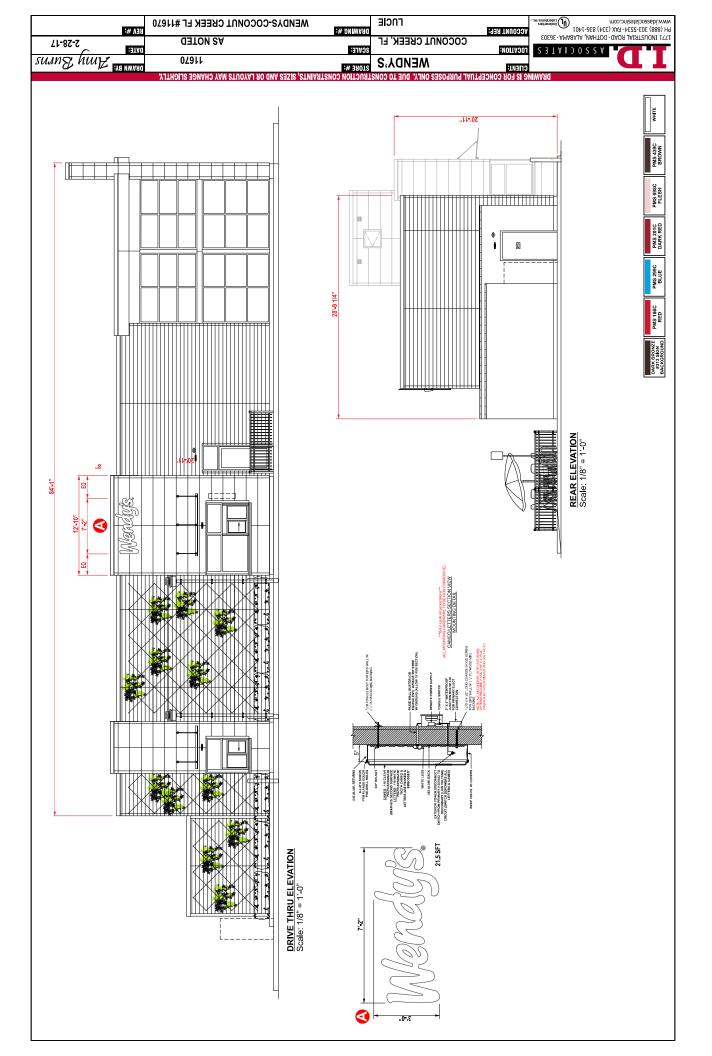
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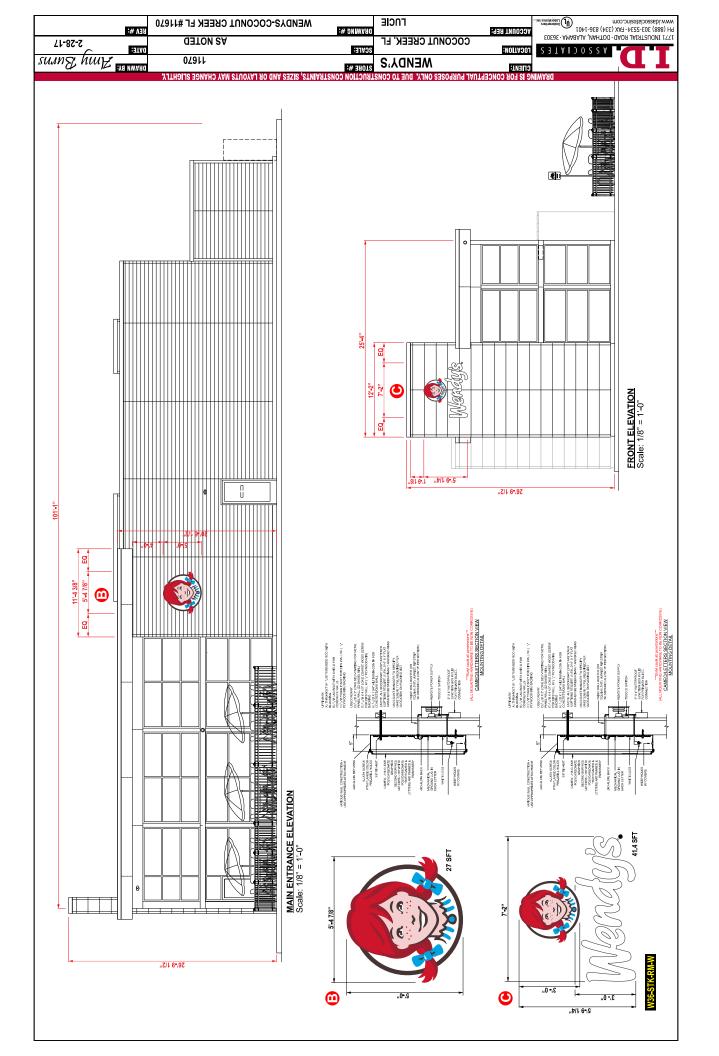
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ISSUE DATE:	05/12/2017
PROJECT NUMBER:	1493
DRAWN BY:	R. C.
CHECKED BY:	E. C.

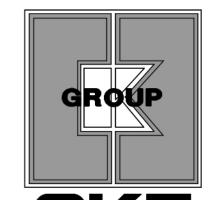
EDUARDO L. CARCACHE, PE 31914 ANA A. GONZALEZ VALDES, AR 97769 CKE GROUP, INC. COA-4432

COLOR EXTERIOR ELEVATIONS






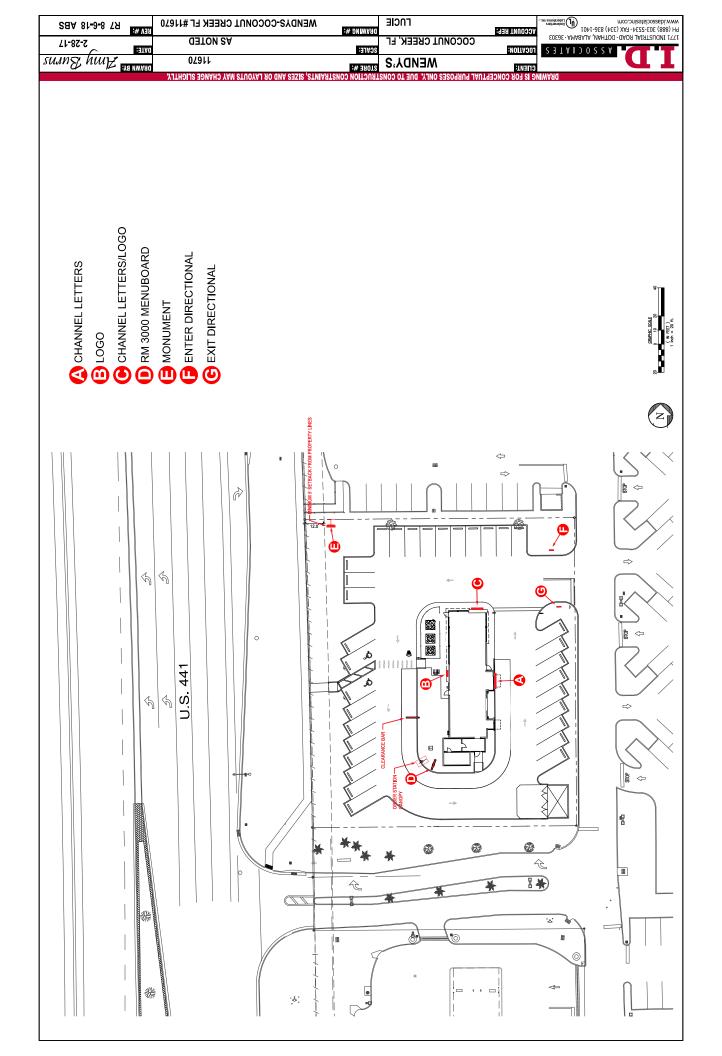


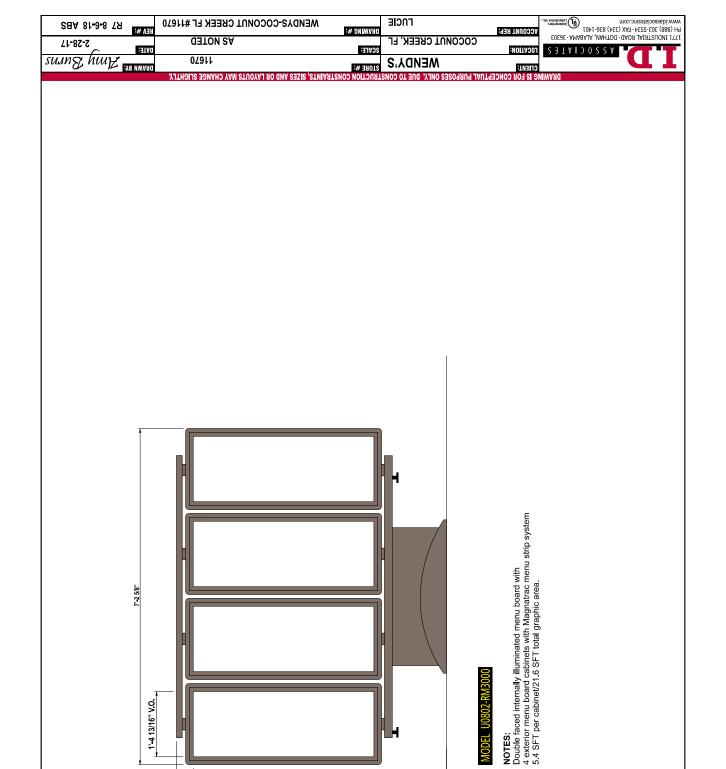



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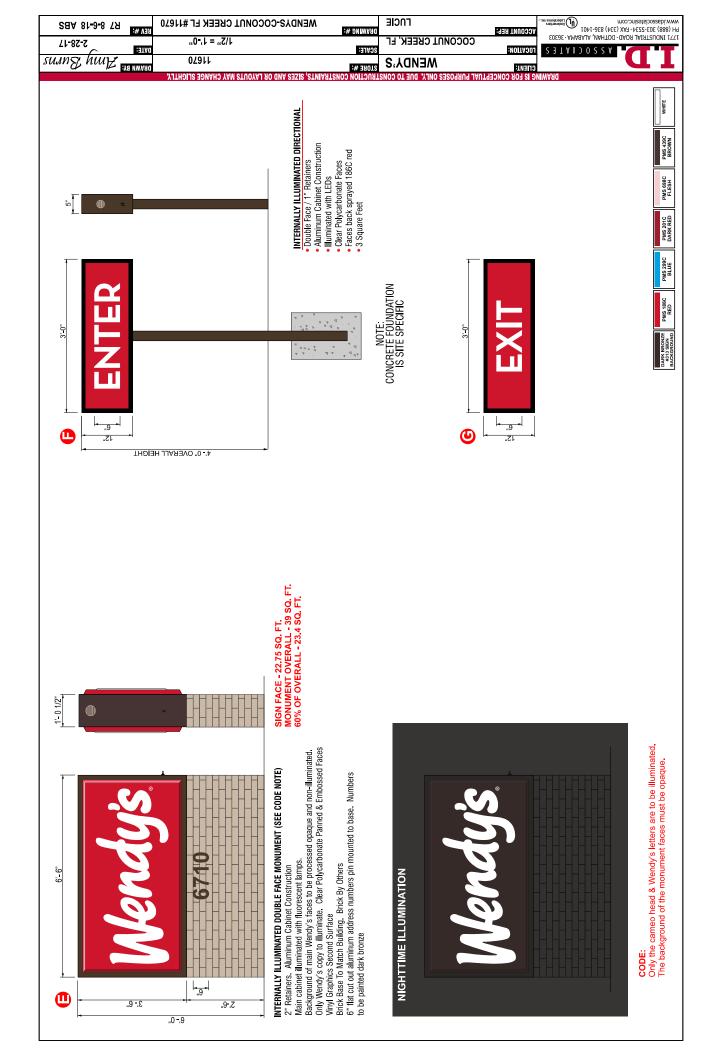





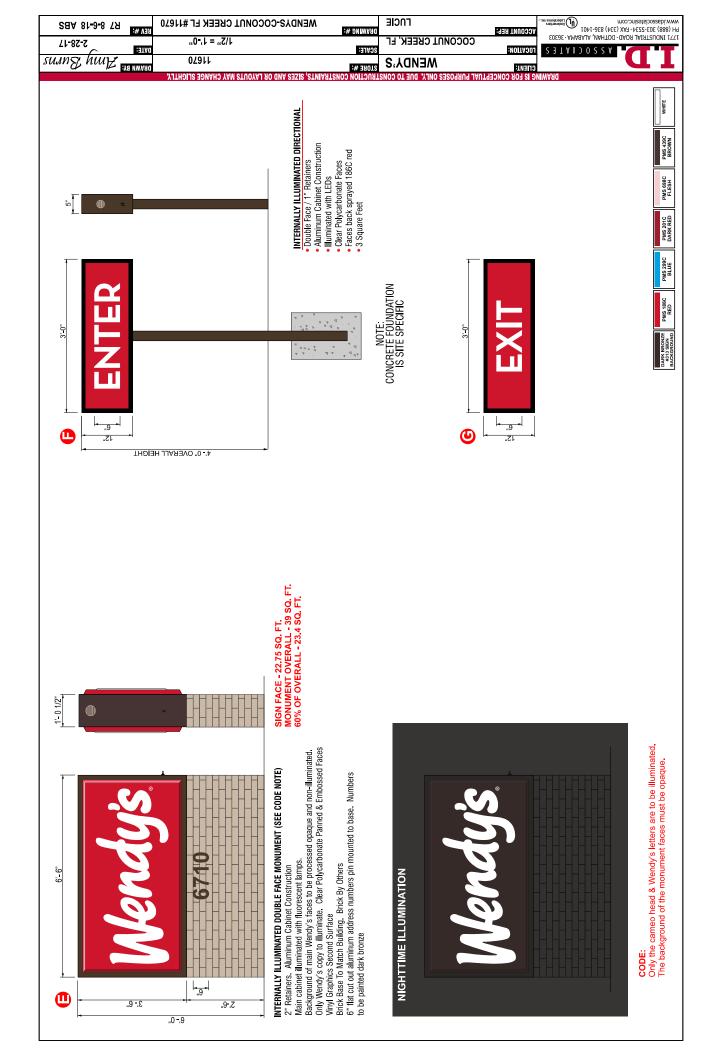

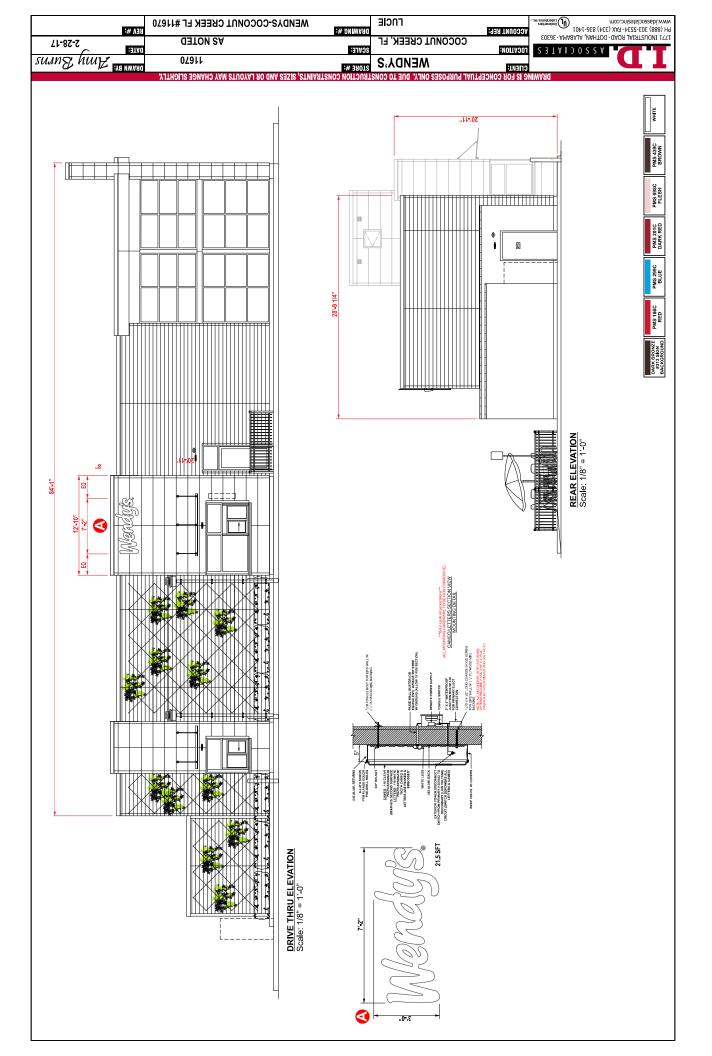
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SNOW FENCE (TYP.)

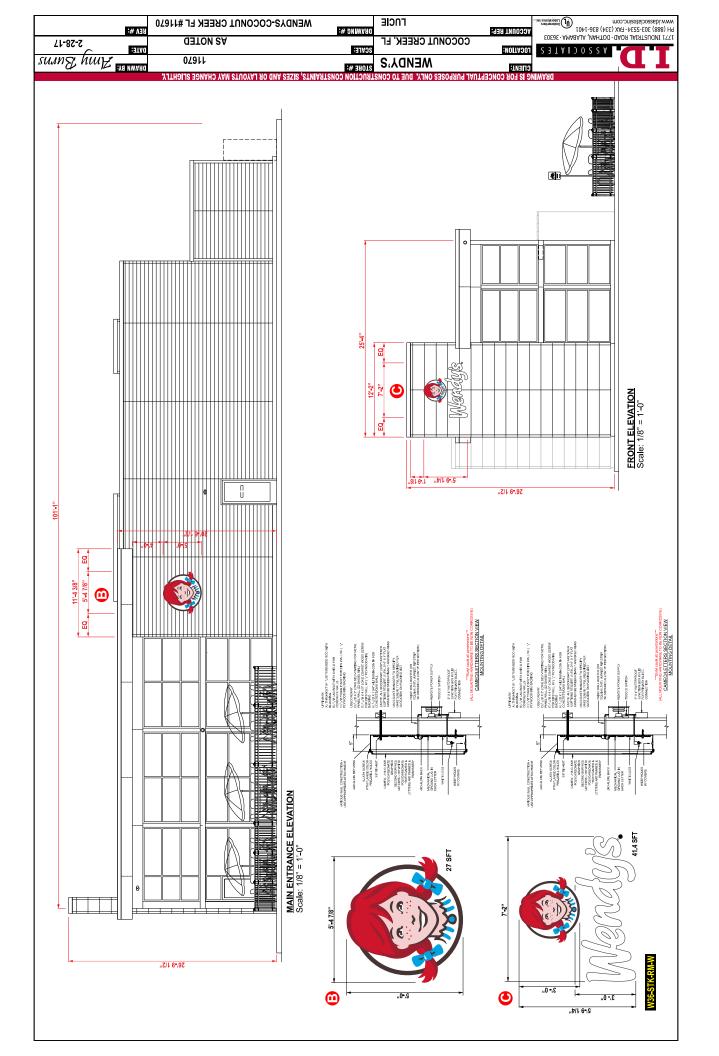C 4'-5' D 1"x2" POST

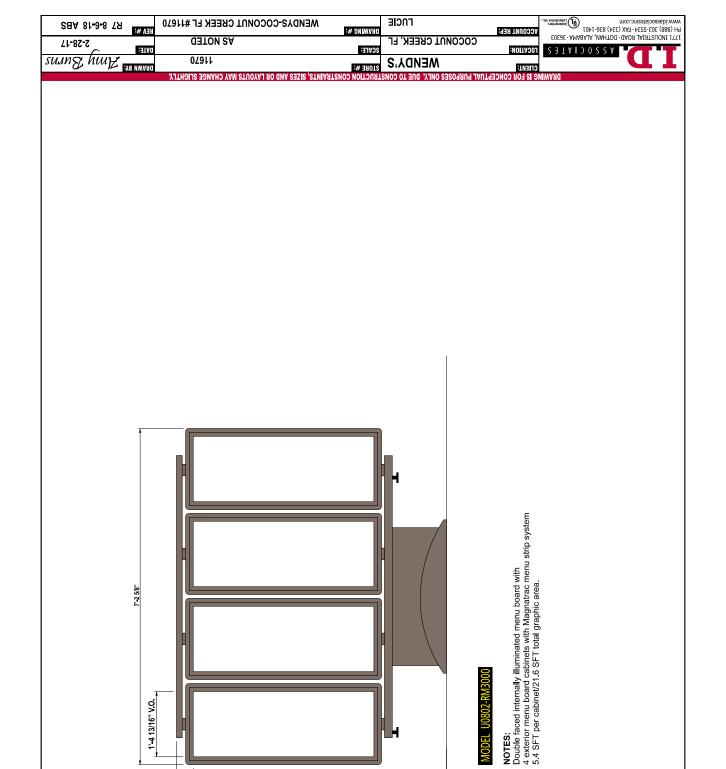CALL 48 HOURS BEFORE YOU DIG IN FLORID

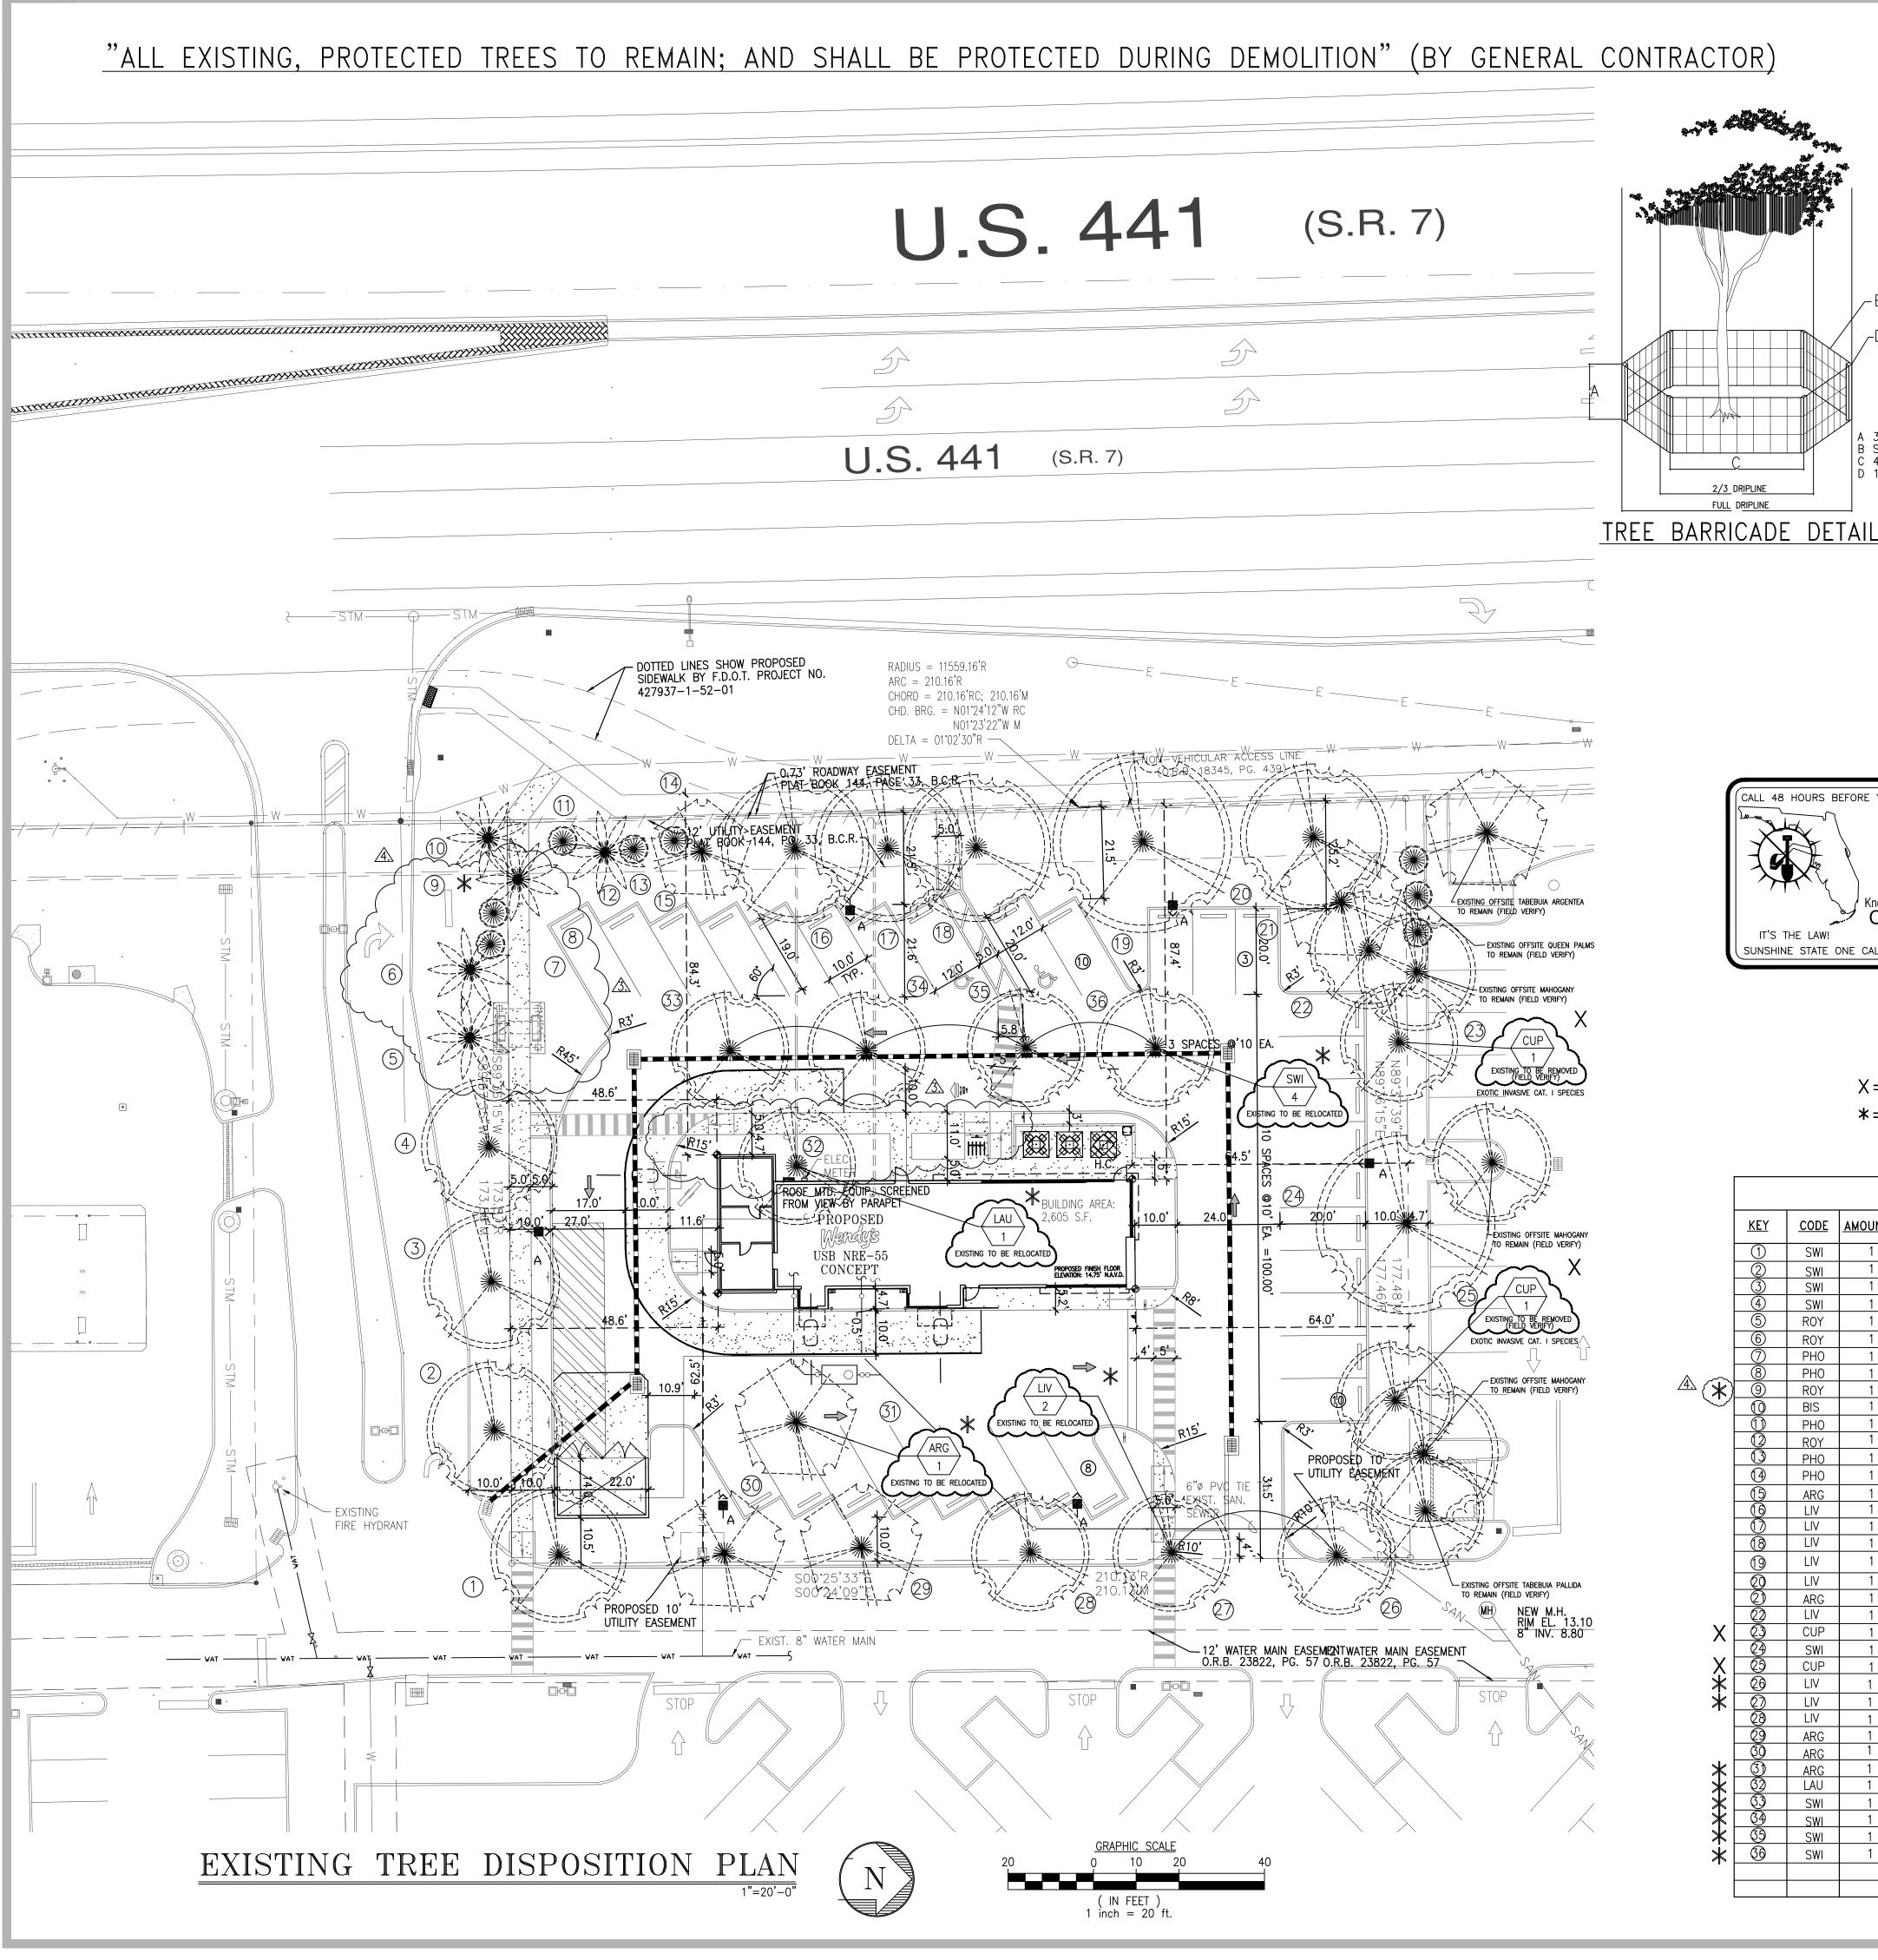SUNSHINE STATE ONE CALL OF FLORIDA, INC

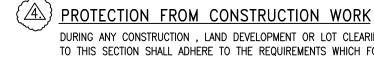Know what's **below**.

Call before you dig

2/3 DRIPLINE

FULL DRIPLINE

DURING ANY CONSTRUCTION, LAND DEVELOPMENT OR LOT CLEARING, THE CONTRACTOR AND THE OWNER OF THE PROPERTY SUBJECT TO THIS SECTION SHALL ADHERE TO THE REQUIREMENTS WHICH FOLLOW:

1. GENERAL CONTRACTOR TO PREPARE FINAL RELOCATION SITES FOR TREES THAT ARE PROPOSED TO BE RELOCATED. TREES ARE ONLY TO BE MOVED ONCE AND SHALL HAVE TREE BARRICADES IN PLACE THE ENTIRE DURATION ON CONSTRUCTION.

2. GENERAL CONTRACTOR SHALL GRADE AND FILL ALL TREE & PALM HOLES ONCE TREES & PALMS ARE REMOVED AND OR RELOCATED. 3. LANDSCAPE AND LAWN IRRIGATION, TREE REMOVAL & RELOCATION PERMITS SHALL BE REQUIRED.

4. A PREPLANTING MEETING SHALL BE HELD WITH THE CITY LANDSCAPE DEPARTMENT PRIOR TO ANY INSTALLATION.

5. ALL PROPOSED TREES TO BE RELOCATED SHALL BE ROOT PRUNED 8 WEEKS PRIOR TO CONSTRUCTION AND DONE ACCORDING TO GOOD NURSERY PRACTICE AS REQUIRED. TRENCH DEPTH SHALL BE 18"-36"; ROOT BALL SHALL BE A MINIMUM OF 60" WHEN ROOT PRUNED. FILL TRENCH WITH FIBROUS MATERIAL SUCH AS LEAVES, OR WOOD SHAVINGS. WATERING SHALL BE ONCE A WEEK DURING ROOT PRUNING. TORN ROOTS SHALL BE TRIMMED TO SOLID WOOD. RELOCATED TREES SHALL BE LIGHTLY PRUNED BY HAND. A ISA CERTIFIED ARBORIST SHALL ROOT PRUNE ANY AND ALL EXISTING TREES WITHIN PAVING/CURBING AREAS TO BE INSTALLED: VERIFY ON SITE WITH CITY LANDSCAPE DEPARTMENT PRIOR TO ANY INSTALLATION; FIELD VERIFY WITH GENERAL CONTRACTOR AS REQUIRED. LANDSCAPE CONTRACTOR SHALL WATER RELOCATED TREES W/ TEMPORARY IRRIGATION EVERYDAY FOR THE FIRST MONTH

THEN 2-3 TIMES A WEEK UNTIL SYSTEM IS FULLY AUTOMATIC; OWNER TO SUPPLY WATER ON SITE. TRANSPLANT TREES W/ 60" TREE SPADE, AND / OR TREE CRANE. TRANSPLANTING HOLE SHALL BE AT LEAST 1/3 BIGGER THAN THE AREA THAT WAS TRENCHED FOR TRANSPLANTING.

6. GENERAL CONTRACTOR SHALL REMOVE ALL ROAD ROCK, ASPHALT, DEBRIS, ETC. IN ALL LANDSCAPE AREAS

TO A MIN. DEPTH OF 30" AND PROVIDE PLANTING SOIL AS REQUIRED, (SEE SOIL SPECIFICATIONS). 7. ALL TREES, PALMS AND OTHER PLANTS SHALL BE PLANTED WITH THE TOP OF THEIR ROOTBALLS NO DEEPER THAN THE FINAL GRADE SURROUNDING THE PLANTING AREA; ( 1"+-)

FLAGGING OR RIBBONS) AND SHALL BE INSTALLED PRIOR TO AND DURING CONSTRUCTION/AND OR LAND DEVELOPMENT.

10. NOT DISCHARGE OR CONTAMINATE THE SOIL WITHIN THE DRIP LINE OF ANY TREE TO BE RETAINED ON SITE WITH ANY CONSTRUCTION ADVERSE IMPACTS.

11. CLEARING OF VEGETATION WITHIN THE DRIP LINE OF TREES DESIGNATED FOR PRESERVATION SHALL ONLY BE BY HAND OR LIGHT RUBBER WHEELED EQUIPMENT THAT WILL NOT DAMAGE THE TREE ROOTS; SAID EQUIPMENT SHALL BE A MAXIMUM OF FORTY-EIGHT (48) INCHES WIDE, TIRE TO TIRE, WITH A MAXIMUM WEIGHT OF THREE THOUSAND FIVE HUNDRED (3,500) POUNDS.

12. UTILIZE RETAINING WALLS AND DRYWELLS WHERE NEEDED TO PROTECT TREES TO BE PRESERVED FROM SEVERE GRADE CHANGES. 13. PRUNING OF TREES TO BE PRESERVED SHALL BE IN ACCORDANCE WITH THE STANDARDS FOR PRUNING ESTABLISHED BY ANSI A-300. 14. MAKE NO ATTACHMENTS, OTHER THAN THOSE OF A PROTECTIVE AND NON-DAMAGING NATURE, TO THE TREE TO BE RETAINED ON THE SITE.

15. NOT CHANGE THE NATURAL GRADE ABOVE THE ROOT SYSTEM WITHIN THE DRIP LINE OF ANY TREE TO BE RETAINED ON SITE UNLESS IT CAN BE DEMONSTRATED TO THE CITY THAT IT WILL NOT DAMAGE ANY TREE.

16. AVOID ANY ENCROACHMENTS, EXCAVATIONS OR SEVERE GRADE CHANGES WITHIN THE DRIP LINE OF PRESERVED TREES UNLESS IT CAN BE DEMONSTRATED TO THE CITY THAT IT WILL NOT IMPACT ANY TREE; NOTE: POSITION RELOCATION TREE NUMBERS 35 & 36 TO PROVIDE REQUIRED LOWER TRUNK BRANCHING CLEARANCE OF THESE TREES FOR THE TRELLIS AT SIDEWALK AREA AS SHOWN, SEE CIVIL TRELLIS PLAN; 17. NOT CAUSE SOIL COMPACTION WITHIN THE DRIP LINE OF ANY TREE TO BE RETAINED ON SITE; AND

18. ANY TREES DESIGNATED TO BE PRESERVED WHICH ARE DAMAGED DURING CONSTRUCTION SHALL BE REPAIRED.




A PORTION OF TRACT "A", SAWGRASS PARK OF COMMERCE COMMERCIAL SECTION "B", ACCORDING TO THE MAP OR PLAT THEREOF AS RECORDED IN PLAT BOOK 144, PAGE 33, OF THE PUBLIC RECORDS OF BROWARD COUNTY, FLORIDA, BEING MORE PARTICULARLY DESCRIBED AS FOLLOWS:

COMMENCING AT THE SOUTHWEST CORNER OF SAID TRACT "A"; THENCE ALONG THE WESTERLY BOUNDARY OF SAID TRACT "A", THE SAME BEING THE EAST RIGHT-OF-WAY OF STATE ROAD No. 7 (U.S. HIGHWAY No. 441), FOR THE FOLLOWING FOUR (4) COURSES AND DISTANCES: (1) NOO'47'49"W, A DISTANCE OF 255.04 FEET, (2) NOO'45'33"W, A DISTANCE OF 199.97 FEET, (3) NORTHERLY ALONG A CURVE TO THE LEFT HAVING A RADIUS OF 11,559.16 FEET, AN ARC OF 32.67 FEET, A CHORD OF 32.67 FEET AND A CHORD BEARING OF NO0°50'24"W TO THE POINT OF BEGINNING, (4) NORTHERLY ALONG A CURVE TO THE LEFT HAVING A RADIUS OF 11,559.16 FEET, AN ARC OF 202.37 FEET, A CHORD OF 202.36 FEET AND A CHORD BEARING OF NO1 25'22"W; THENCE N89°36'20"E, ALONG A LINE LYING 200.00 FEET SOUTH OF AND PARALLEL TO THE NORTH BOUNDARY OF SAID TRACT "A", A DISTANCE OF 177.16 FEET; THENCE S00'23'18"E, A DISTANCE OF 202.33 FEET; THENCE S89°36'20"W, A DISTANCE OF 173.51 FEET TO THE POINT OF BEGINNING. CONTAINING 35,416 SQUARE FEET OR 0.81 ACRES, MORE OR LESS.

X = TO BE REMOVED; EXOTIC CAT. I INVASIVE SPECIES

 $\star$  = TO BE RELOCATED; SEE LANDSCAPE PLAN L-1 FOR ADDITIONAL INFO

				EXISTING TREES &	PALMS (FIE	LD VERIFT)	
	<u>KEY</u>	CODE	AMOUNT	BOTANICAL NAME / COMMON NAME	<u>SIZE</u>	REMARKS	CONDITION
f	1	SWI	1	SWIETENIA MAHOGANI / MAHOGANY	28'-30' X 35'	EXISTING TO REMAIN (14".0 CALIPER)	GOOD
	<u>2</u>	SWI	1	SWIETENIA MAHOGANI / MAHOGANY	28'-30' X 35'	EXISTING TO REMAIN (14".O CALIPER)	GOOD
	3	SWI	1	SWIETENIA MAHOGANI / MAHOGANY	28'-30' X 35'	EXISTING TO REMAIN (18".O CALIPER)	GOOD
	4	SWI	1	SWIETENIA MAHOGANI / MAHOGANY	28'-30' X 35'	EXISTING TO REMAIN (20".0 CALIPER)	GOOD
	(5)	ROY	1	ROYSTONEA ELATA / FLORIDA ROYAL PALM	18'-20' X 18'	EXISTING TO REMAIN (14".O CALIPER)	GOOD
	6	ROY	1	ROYSTONEA ELATA / FLORIDA ROYAL PALM	24'-25' X 18'	EXISTING TO REMAIN (18".O CALIPER)	GOOD
	7	PHO	1	PHOENIX ROEBELLINI / PIGMY DATE PALM	10'-12' X 8'	EXISTING TO REMAIN(X3) (3".0 CALIPER)	GOOD
$_{\sim}\lceil$	8	PHO	1	PHOENIX ROEBELLINI / PIGMY DATE PALM	10'-12' X 8'	EXISTING TO REMAIN(X3) (3".O CALIPER)	GOOD
<b>*</b> }[	9	ROY	1	ROYSTONEA ELATA / FLORIDA ROYAL PALM	24'-25' X 18'	EXISTING TO BE RELOCATED (18".O CALIPER)	GOOD
] کرٹ	10	BIS	1	BISMARCKIA NOBILIS / BISMARK PALM	14'-15' X 15'	EXISTING TO REMAIN (18."O CALIPER)	GOOD
	1)	PHO	1	PHOENIX ROEBELLINI / PIGMY DATE PALM	10'-12' X 8'	EXISTING TO REMAIN(X3) (3".0 CALIPER)	GOOD
	12	ROY	1	ROYSTONEA ELATA / FLORIDA ROYAL PALM	24'-25' X 18'	EXISTING TO REMAIN (18".0 CALIPER)	GOOD
	(3	PHO	1	PHOENIX ROEBELLINI / PIGMY DATE PALM	11'-12' X 8'	EXISTING TO REMAIN(X3) (3".0 CALIPER)	GOOD
	14	PHO	1 1	PHOENIX ROEBELLINI / PIGMY DATE PALM	11'-12' X 8'	EXISTING TO REMAIN(X3) (3".0 CALIPER)	GOOD
	15	ARG	1	TABEBUIA ARGENTEA / YELLOW TRUMPET	20'-22' X 20'	EXISTING TO REMAIN (9".O CALIPER)	GOOD
	(16)	LIV	1	QUERCUS VIRGINIANA / LIVE OAK	20'-22' X 35'	EXISTING TO REMAIN (9".O CALIPER)	GOOD
	17	LIV	1	QUERCUS VIRGINIANA / LIVE OAK	22'-24' X 35'	EXISTING TO REMAIN (8".0 CALIPER)	GOOD
	18	LIV	1	QUERCUS VIRGINIANA / LIVE OAK	24'-26' X 32'	EXISTING TO REMAIN (12".0 CALIPER)	GOOD
	19	LIV	1	QUERCUS VIRGINIANA / LIVE OAK	32'-34' X 40'	EXISTING TO REMAIN (18".O CALIPER)	GOOD
	② ②	LIV	1	QUERCUS VIRGINIANA / LIVE OAK	22'-24' X 35'	EXISTING TO REMAIN (8".0 CALIPER)	GOOD
	2)	ARG	1	TABEBUIA ARGENTEA / YELLOW TRUMPET	20'-22' X 20'	EXISTING TO REMAIN (9".0 CALIPER)	GOOD
	22	LIV	1	QUERCUS VIRGINIANA / LIVE OAK	20'-22' X 30'	EXISTING TO REMAIN (9".0 CALIPER)	GOOD
<	23	CUP	1	CUPANIOPSIS ANACARDIOIDES / CARROTWOOD	20'-22' X 30'	(1) TO BE REMOVED (10".O CALIPER)	POOR/DAMAGES
,	2 <del>9</del> 25	SWI	1	SWIETENIA MAHOGANI / MAHOGANY	35'-36' X 42'	EXISTING TO REMAIN (22".O CALIPER)	GOOD
<b> </b>		CUP	1	CUPANIOPSIS ANACARDIOIDES / CARROTWOOD	20'-22' X 30'	(1) TO BE REMOVED (10".O CALIPER)	POOR
k L	26	LIV	1	QUERCUS VIRGINIANA / LIVE OAK	20'-22' X 35'	EXISTING TO BE RELOCATED (7".O CALIPER)	GOOD
k [	2	LIV	1	QUERCUS VIRGINIANA / LIVE OAK	20'-22' X 35'	EXISTING TO BE RELOCATED (7".0 CALIPER)	GOOD
	28	LIV	1	QUERCUS VIRGINIANA / LIVE OAK	20'-22' X 35'	EXISTING TO REMAIN (8".0 CALIPER)	GOOD
L	<u> </u>	ARG	1	TABEBUIA ARGENTEA / YELLOW TRUMPET	16'-18' X 22'	EXISTING TO REMAIN (8".0 CALIPER)	GOOD
.	<u>30</u>	ARG	1	TABEBUIA ARGENTEA / YELLOW TRUMPET	16'-18' X 20'	EXISTING TO REMAIN (6".0 CALIPER)	GOOD
K L	<u> </u>	ARG	1	TABEBUIA ARGENTEA / YELLOW TRUMPET	26'-28' X 28'	EXISTING TO BE RELOCATED (22".O CALIPER)	GOOD
K L	<u> </u>	LAU	1	QUERCUS LAURIFOLIA / LAUREL OAK	20'-22' X 28'	EXISTING TO BE RELOCATED (8".O CALIPER)	GOOD
	<u> </u>	SWI	1	SWIETENIA MAHOGANI / MAHOGANY	24'-25' X 30'	EXISTING TO BE RELOCATED (8".O CALIPER)	GOOD
<b>[</b>	<u>34</u> 35	SWI	1	SWIETENIA MAHOGANI / MAHOGANY	26'-28' X 35'	EXISTING TO BE RELOCATED (9".O CALIPER)	GOOD
<b>K</b>		SWI	1	SWIETENIA MAHOGANI / MAHOGANY	28'-30' X 35'	EXISTING TO BE RELOCATED (10".0 CALIPER)	GOOD
Ҝ╽	<u> </u>	SWI	1	SWIETENIA MAHOGANI / MAHOGANY	24'-26' X 32'	EXISTING TO BE RELOCATED (12".0 CALIPER)	GOOD

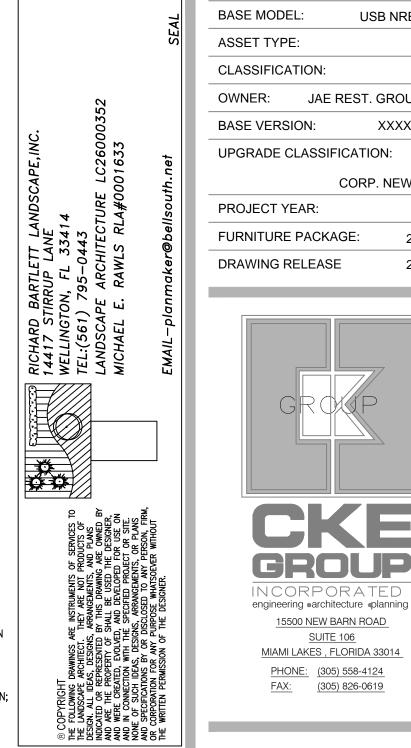

SITE NUMBER:

11670

USB NRE 55 R3

XXXXXXXX

2016 R3

2016 R3

CORP. NEW BUILD

JAE REST. GROUP, LLC

PROJECT TYPE: USB NRE 55

15500 NEW BARN ROAD

SUITE 106

MIAMI LAKES , FLORIDA 33014

PHONE: (305) 558-4124

FAX: (305) 826-0619

1.1-19-17 CITY COMMENTS


2.5-15-17 CITY COMMENTS

3.5-01-18 4.7-30-18 CITY COMMENTS


PROJECT NUMBER: RBL#16-04-2066 DRAWN BY: RICK BARTLET CHECKED BY: RGB/MER

EDUARDO L. CARCACHE, PE 31914 ANA A. GONZALEZ VALDES, AR 97769 LUIS VARGAS, LEED AP #701023753163800 CKE GROUP, INC. COA-4432

TREE DISPOSITION PLAN

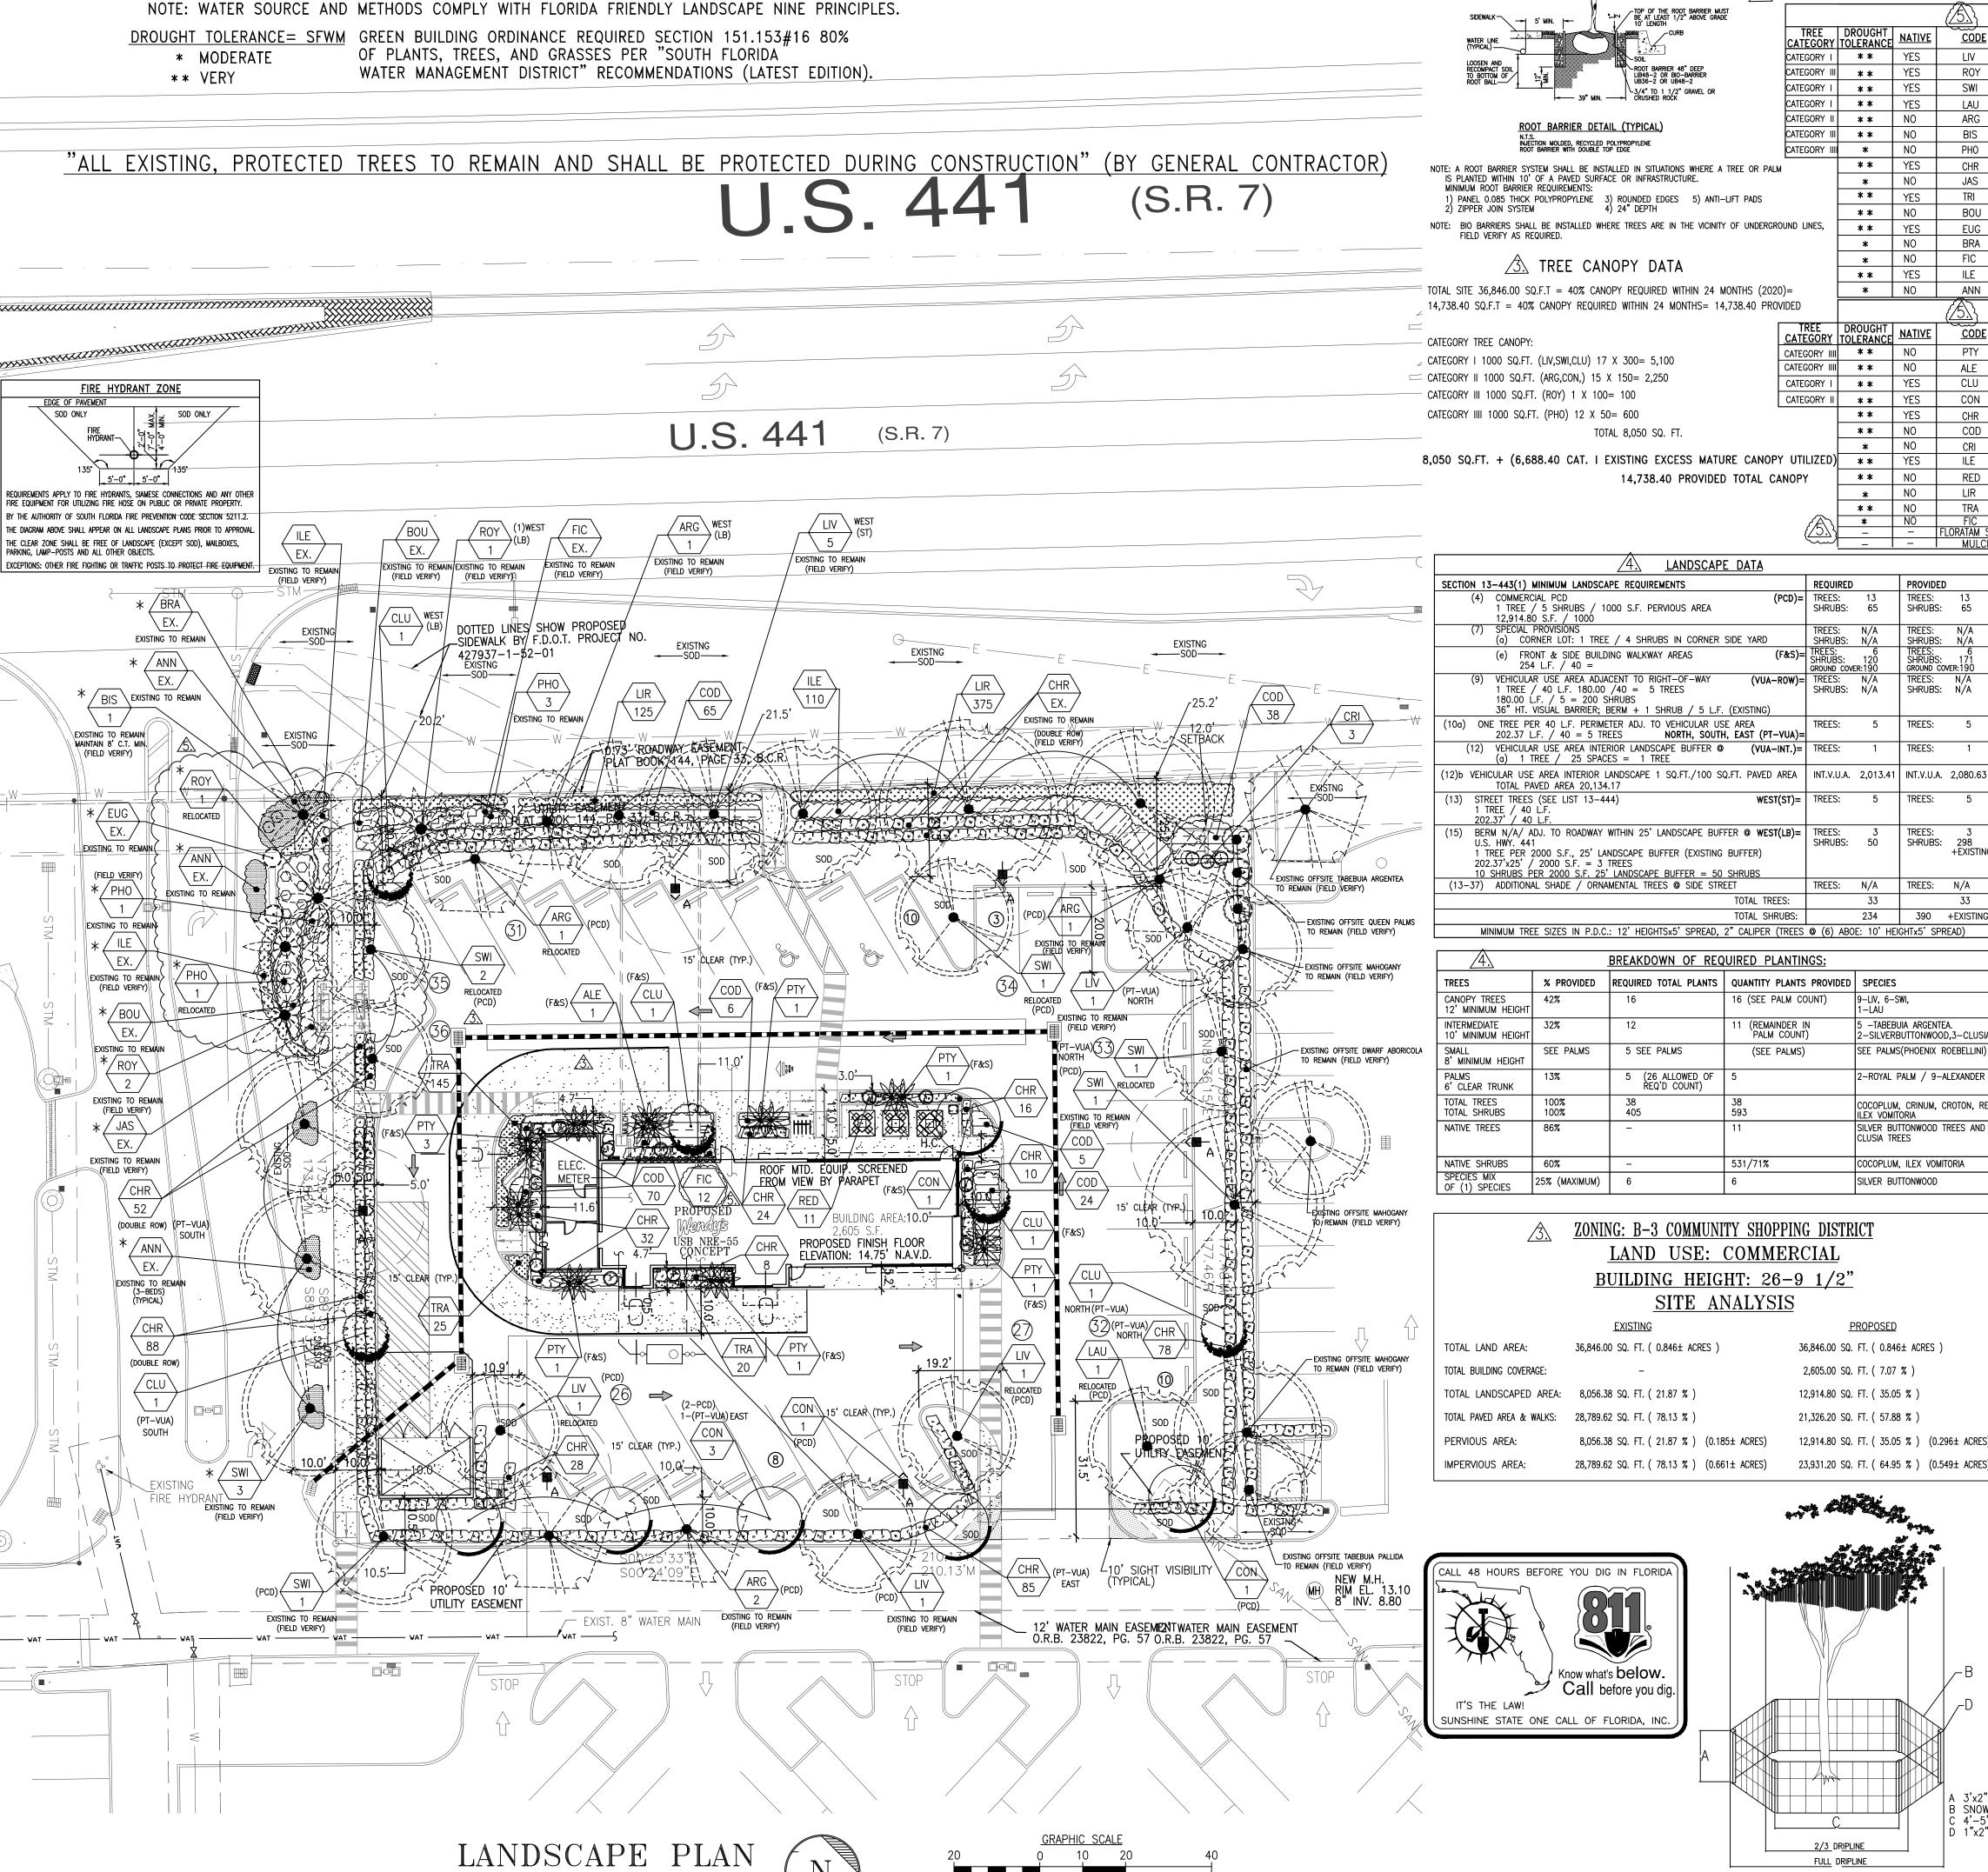

1 inch = 20 1

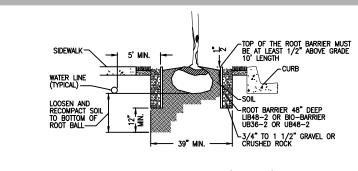

**ROOT BARRIER DETAIL (TYPICAL)** ECTION MOLDED, RECYCLED POLYPROPYLENE OT BARRIER WITH DOUBLE TOP EDGE

NOTE: A ROOT BARRIER SYSTEM SHALL BE INSTALLED IN SITUATIONS WHERE A TREE OR PALM IS PLANTED WITHIN 10' OF A PAVED SURFACE OR INFRASTRUCTURE. MINIMUM ROOT BARRIER REQUIREMENTS: 1) PANEL 0.085 THICK POLYPROPYLENE 3) ROUNDED EDGES 5) ANTI-LIFT PADS 2) ZIPPER JOIN SYSTEM 4) 24" DEPTH NOTE: BIO BARRIERS SHALL BE INSTALLED WHERE TREES ARE IN THE VICINITY OF UNDERGROUND LINES,

/3]. TREE CANOPY DATA

TOTAL SITE 36,846.00 SQ.F.T = 40% CANOPY REQUIRED WITHIN 24 MONTHS (2020)= 14,738.40 SQ.F.T = 40% CANOPY REQUIRED WITHIN 24 MONTHS= 14,738.40 PROVIDED

CATEGORY TREE CANOPY: CATEGORY I 1000 SQ.FT. (LIV,SWI,CLU) 17 X 300= 5,100 CATEGORY II 1000 SQ.FT. (ARG,CON,) 15 X 150= 2,250 CATEGORY III 1000 SQ.FT. (ROY) 1 X 100= 100 CATEGORY IIII 1000 SQ.FT. (PHO) 12 X 50= 600 TOTAL 8,050 SQ. FT.

8,050 SQ.FT. + (6,688.40 CAT. I EXISTING EXCESS MATURE CANOPY UTILIZED) 14,738.40 PROVIDED TOTAL CANOPY \*\* NO

CORNER LOT: 1 TREE / 4 SHRUBS IN CORNER SIDE YARD

1 TREE / 25 SPACES = 1 TREE

SEE PALMS

86%

25% (MAXIMUM)

/4\ LANDSCAPE DATA

NORTH, SOUTH, EAST (PT-VUA)=

**BREAKDOWN OF REQUIRED PLANTINGS:** 

% PROVIDED | REQUIRED TOTAL PLANTS | QUANTITY PLANTS PROVIDED | SPECIES

ZONING: B-3 COMMUNITY SHOPPING DISTRICT

LAND USE: COMMERCIAL

BUILDING HEIGHT: 26-9 1/2"

SITE ANALYSIS

5 (26 ALLOWED 0 REQ'D COUNT)

**EXISTING** 

Know what's **below**.

Call before you dig

36,846.00 SQ. FT. ( 0.846± ACRES )

208

NOTE: \* EXISTING MATERIAL OUTSIDE OF PARCEL LINES ARE NOT COUNTED TOWARDS CODE REQUIREMENTS FOR THIS PROJECT

CODE AMOUNT BOTANICAL NAME / COMMON NAME

9 QUERCUS VIRGINIANA/ LIVE OAK

\* 6 | SWIETENIA MAHOGANI / MAHOGANY

\* 2 | ROYSTONEA ELATA / FLORIDA ROYAL PALM

1 QUERCUS LAURIFOLIA / LAUREL OAK

\* 1 | BISMARCKIA NOBILIS / BISMARK PALM

CHRYSOBALANUS ICACO / "RED TIP"

JASMINUM VOLUBLE / WAX JASMINE

8 PTYCHOSPERMA ELEGANS/ALEXANDER PALM

1 PTYCHOSPERMA ELEGANS/ALEXANDER PALM

6 CONOCARPUS SERICEUS / SILVER BUTTONWOOD

CODAEUM VARIEGATUM / MAMMEY CROTON

FX. | BOUGAINVILLEA / BOUGAINVILLEA BUSH

EX. | EUGENIA FOETIDA / SPANISH STOPPER

EX. | FICUS MICROCARPA / GREEN ISLAND

EX. | ILEX VOMITORIA / YAUPON HOLLY

EX. | SEASONAL ANNUALS / L. A. SELECT

5 CLUSIA ROSEA / PITCH APPLE

421 | CHRYSOBALANUS ICACO / "RED TIP"

CRINUM ASIATICUM / TREE CRINUM

CORDYLINE FRUTICOSA/ "RED SISTER

ILEX VOMITORIA / YAUPON HOLLY

190 TRACHELOSPERUM ASIATICUM / "MINIMA"

500 LIRIOPE MUSCARI / BIG BLUE

CODE AMOUNT BOTANICAL NAME / COMMON NAME

EX. | BROMELIAD / AECHMEA

│ \* 5 │ PHOENIX ROEBELLINI / PIGMY DATE PALM│

TABEBUIA ARGENTEA / YELLOW TRUMPET

TRIPSACUM FLORIDANA/ FLORIDA GAMA GRASS

CATEGORY TOLERANCE NATIVE

\* \*

\* \*

\* NO

\* NO

CATEGORY IIII \*\*

CATEGORY IIII \*\*

REQUIRED

SHRUBS: N/A

SHRUBS: N/A

GROUND COVER:19

SHRUBS:

TREES: N/A

234

9-LIV, 6-SWI,

CLUSIA TREES

<u>PROPOSED</u>

36,846.00 SQ. FT. ( 0.846± ACRES )

2,605.00 SQ. FT. ( 7.07 % )

12,914.80 SQ. FT. ( 35.05 % )

21,326.20 SQ. FT. ( 57.88 % )

2/3 DRIPLINE

FULL DRIPLINE

TREE BARRICADE DETAIL

8,056.38 SQ. FT. ( 21.87 % ) (0.185± ACRES) 12,914.80 SQ. FT. ( 35.05 % ) (0.296± ACRES)

28,789.62 SQ. FT. ( 78.13 % ) (0.661± ACRES) 23,931.20 SQ. FT. ( 64.95 % ) (0.549± ACRES)

(PCD)= TREES:

(F&S)=| IREES: SHRUBS:

(VUA-ROW)= TREES:

WEST(ST)=

TOTAL SHRUBS:

16 (SEE PALM COUNT)

`PALM COUNT)

CATEGORY I

NATIVE |

NO

PROVIDED

SHRUBS:

SHRUBS:

TREES:

GROUND COVER:190

SHRUBS: N/A

TREES: 3 SHRUBS: 298

TREES: N/A

390 +EXISTING

-SILVERBUTTONWOOD,3-CLUSIA

SEE PALMS(PHOENIX ROEBELLINI)

-ROYAL PALM / 9-ALEXANDER

OCOPLUM, CRINUM, CROTON, RED

B SNOW FENCE (TYP.

SILVER BUTTONWOOD TREES AND

COCOPLUM, ILEX VOMITORIA

SILVER BUTTONWOOD

CATEGORY I

CATEGORY

CATEGORY II

CATEGORY

YES

YES

YES

YES

ROY

SWI

LAU

ARG

BOU

BRA

ANN

PTY

COD

RED

TRA

LANDSCAPE LEGEND (EXISTING)

LANDSCAPE LEGEND (NEW)

REMARKS

20'-34' X 35'-40' EXISTING TO REMAIN-RELOCATE

18'-25' X 17'-18' EXISTING TO REMAIN-RELOCATE

EXISTING TO REMAIN

F.G. DOUBLE "MATCHED"

G. TRIPLE "MATCHED"

24" O.C. (FULL TO BASE)

4"-6" HTS. | EXISTING TO REMAIN

REMARKS

l F.G. 4<del>ኔ</del> C.T

F.G. 4½ C.T.

AS SHOWN

AS SHOWN

28'-36' X 35'-42'

26'-28' X 28'

14'-15' X 15'

"TRIPLE" 10'-12' X 8'

24"x18" 3 GAL

24"x18" FULL 3 GAL.

30"x18" FULL 3 GAL.

18"x12" FULL 3 GAL.

<u>SIZE</u>

8' MIN. C.T.

16' MIN. C.T.

'STANDARD" 14'-16'x 7'

'STANDARD" 10'-12'x 6'

24"x18" 3 GAL

24"x18" 3 GAL

30" O.A. HGT.

30" O.A. MUITI-FULL

6" 1 GAL. FULL

14"X12"

4"-6" HTS. | 12" O.C.

14"X12"

14"X12"

EXISTING TO REMAIN-RELOCATE (

EXISTING TO REMAIN-RELOCATE

EXISTING TO REMAIN-RELOCATE

EXISTING TO REMAIN-RELOCATE

ALL LANDSCAPE AND SPECIFICATIONS SHALL MEET OR EXCEED THE MINIMUM REQUIREMENTS AS PROVIDED IN THE CITY OF COCONUT CREEK LAND DEVELOPMENT CODE.

ALL PLANTING MATERIAL SHALL MEET OR EXCEED FLORIDA GRADE #1 AS SPECIFIED IN GRADES AND STANDARDS FOR NURSERY PLANTS AND PART II, PALMS AND TREES, CURRENTS EDITION. LANDSCAPE SHALL BE PLACED TO EDGE OF ABUTTING STREETS, CANALS, LAKES, OR OTHER LANDS.

ALL MECHANICAL EQUIPMENT, AIR CONDITIONING, IRRIGATION PUMP STATIONS AND EQUIPMENT, FPL TRANSFORMERS, POOL PUMPS, ETC.. MUST BE SCREENED ON THREE (3) SIDES BY LANDSCAPE SHRUBS. NOTE: THE QUANTNITY OF SCREENING SHRUBS IS IN ADDITION TO THE REQUIRED NUMBER OF SHRUBS AS PROVIDED IN THE CODE CAL-

ULATION TABLE. ALL SCREENING SHRUBS SHALL BE PLANTED FOR PROPER OPERATION OF EQUIPMENT BEING SCREENED AND/OR PER THE REQUIREMENTS OF THE UTILITY AS NECESSARY. ALL HEDGE MATERIAL REQUIRED FOR SCREENING PURPOSES SHALL BE PLANTED WITH BRANCHES TOUCHING. ADJUST SPACING AS NECESSARY AND/OR PROVIDE ADDITIONAL PLANTS TO PROVIDE AN ADEQUATE SCREEN. SITE DISTANCE CONCERNS MUST BE MAINTAINED FOR CLEAR SITE VISIBILITY FROM THIRTY (30) INCHES TO SEVENTY TWO (72) INCHES, TREE TRUNKS EXCLUDED. MEASUREMENT SHALL BE MADE FROM TOP OF ROOT BALL PLANTED AT PROPER ELEVATION.

PLANT MATERIAL. TREES, PALMS, AND PLANT MATERIAL REJECTED DUE TO THIS PRACTICE SHALL BE REPLACED WITH THE INSPECTOR ON SITE. BURLAP MATERIAL, WIRE CAGES, PLASTIC/ CANVAS STRAPS ETC.. MUST BE CUT AND REMOVED FROM TOP ONE HALF (1/2) DEPTH OF ROOT BALL.

TREES AND SHRUBS GROWN IN BAGS OR GROW BAG TYPE MATERIAL MUST HAVE SUCH MATERIAL REMOVED ENTIRELY PRIOR TO PLANTING. ALL PLANT MATERIAL SHALL BE FREE OF PESTS, INSECTS, DISEASE, WEEDS, ETC. ALL PLANT MATERIAL SHALL BE PLANTED AT THE PROPER DEPTH, AS ORIGINALLY GROWN AND/OR SO THAT THE TOP OF THE ROOT BALL IS

FLUSH OR SLIGHTLY ABOVE FINISHED GRADE IMMEDIATELY AFTER PLANTING. ALL TREES SHOULD PROVIDE TRUNK TAPER WHEN PROPERLY PLANTED AT THE CORRECT PLANTING DEPTH.

ALL PLANT MATERIAL SHALL BE WATERED IN AT TIME OF PLANTING TO ELIMINATE AIR POCKETS IN THE ROOT ZONE AREA. UPON COMPLETION OF WORK THE SITE SHALL BE CLEARED OF ALL DEBRIS, SUPERFLUOUS MATERIALS, AND EQUIPMENT CAUSED BY THIS

PERMIT TO THE SATISFACTION OF THE INSPECTOR.

REFER TO COCONUT CREEK FIRE HYDRANT CLEAR DIAGRAM TO MAINTAIN A SAFE ZONE FRONTING FIRE HYDRANTS. DO NOT PLANT TREES, SHRUBS OR GROUND COVER PLANTS WITHIN ELECTRIC METER CLEAR ZONE. PROVIDE A SAFE ZONE AS DESCRIBED

BY THE ELECTRICAL INSPECTOR. SHALL PROVIDE 100% COVERAGE WITH A 50% OVERLAP (MIN.) USING RUST FREE WATER, EXCEPT PRESERVED AREAS REMAINING IN A NATURAL

STATE. A RAIN SENSOR DEVICE OR SWITCH SHALL BE INSTALLED THAT WILL OVERRIDE THE IRRIGATION SYSTEM WHEN ADEQUATE RAIN FALL HAS OCCURED. WATER SHALL NOT BE DIRECTED AND/OR PROVIDED ONTO IMPERVIOUS SURFACES OR BE DESIGNED OR INSTALLED TO THROW WATER OVER AN IMPERVIOUS SURFACE SUCH AS A SIDEWALK, ETC.. HOURS OF OPERATION FOR ALL IRRIGATION SYSTEMS SHALL BE LIMITED TO 5:00 PM O 8:00 AM ONLY OR AS MAY BE FURTHER RESTRICTED BY SOUTH FLORIDA WATER MANAGEMENT DISTRICT OR OTHER JURISDICTIONAL AGENCY. IRRIGATION PERMITS AND PLANS SHALL BE SUBMITTED FOR APPROVAL AT TIME OF BUILDING PERMITS.

ALL NON-SINGLE FAMILY OR DUPLEX IRRIGATION SYSTEMS OTHER THAN CITY WATER SYSTEMS SHALL REQUIRE A SOUTH FLORIDA WATER MANAGE-MENT DISTRICT WATER USE PERMIT PRIOR TO ISSUANCE OF AN IRRIGATION PERMIT AND INSTALLATION OF THE IRRIGATION SYSTEM AS REQUIRED. ALL SITE AMENITIES TO INCLUDE SITE STREET LIGHTS, LANDSCAPE COMMON OPEN SPACE, IRRIGATION COMMON OPEN SPACE, BUFFERS, BERMS,

LANDSCAPE ENTRY FEATURES, ETC. LEADING UP TO AND INCLUDING THE MODEL CENTER AND/OR FIRST CERTIFICATE OF OCCUPANCY MUST BE COMPLETED AND FUNCTIONAL PRIOR TO ISSUANCE OF THE FIRST REQUESTED CERTIFICATE OF OCCUPANCY. THE HEIGHT OF ALL REQUIRED, DESIGNED AND INSTALLED BERMS SHALL BE FROM THE HIGHEST ADJACENT POINT WHETHER IT IS THE SIDEWALK,

SEE SPECIFICATION SHEET FOR ADDITIONAL DETAILS.

NOTE 40' CLEAR SIGHT DISTANCE AT PUBLIC RIGHT-OF-WAY, AND 10' CLEAR SIGHT DISTANCE WHERE INDICATED ON LANDSCAPE PLAN L-1. SHRUBS WILL BE PLANTED WITH BRANCHES TOUCHING.

ALL LANDSCAPED AREAS WILL HAVE A 6" (SIX INCH) CURB.

PARKING AREA, VEHICULAR USE AREA OR SURROUNDING GROUND, ETC..

TREE CALIPER MEASURED AT 4.5 FEET ABOVE GRADE. CITY TREE REMOVAL AND CLEAR AND GRUB PERMITS SHALL BE REQUIRED FROM THE CITY OF COCONUT CREEK PRIOR TO START OF WORK.

IRRIGATION SYSTEM WATER SOURCE : PUMP & WELL. 5. ALL TREES/PALMS WILL BE INSTALLED A MINIMUM DISTANCE OF 15 FEET FROM LIGHT POLES.

ALL TREES/PALMS WILL BE INSTALLED A MINIMUM DISTANCE OF 20 FEET FROM OVER HEAD UTILITY LINES. FINAL LOCATIONS WILL BE DETERMINED

IN THE FIÉLD BY THE CITY OF COCONUT CREEK LANDSCAPE INSPECTOR, CITY OF COCONUT CREEK ENGINEER, AND BY THE LANDSCAPE ARCHITECT PRIOR TO START OF WORK AND WILL BE INSTALLED ONLY WITH IMMEDIATE SUPERVISION BY THE GENERAL CONTRACTOR. TREE ROOT BARRIERS WILL BE INSTALLED ON ALL TREES AND PALMS AS PER MANUFACTURER'S INSTRUCTIONS AND AS PER THE CITY OF COCONUT CREEK. ). General contractor to prepare final relocation sites for trees that are proposed to be relocated. Trees are only to be moved once and shall have tree barricades in place the entire duration on construction; see tree disposition plan for notes & additional information.

ALL PLANT MATERIAL SHALL BE FLORIDA NO. 1 OR BETTER & SHALL BE INSTALLED AS SPECIFIED IN "FLORIDA DEPT. OF AGRICULTURAL GRADES AND STANDARDS", CURRENT EDITION RESPECTIVELY.

CO-DOMINANT TREES AND TREES WITH BARK INCLUSION WILL NOT BE ACCEPTED. 2. ALL PLANTING MATERIAL SHALL BE GUARANTEED 365 DAYS ( 1 YEAR ) FROM TIME OF FINAL INSPECTION.

3. TOPSOIL SHALL BE CLEAN & REASONABLY FREE OF CONSTRUCTION DEBRIS, WEEDS, ROCKS, & NOXIOUS PESTS & DISEASE (PLANTING SOIL SHALL BE COMPOSED OF 50% SAND AND 50% DECOMPOSED ORGANIC MATTER).). 4. PROVIDE DISH TO RETAIN WATER, ELIMINATE AIR POCKETS WITH THE USE OF WATER HOSE, HOLE SHOULD BE FILLED WITH A MIXTURE

OF GOOD TOP SOIL (SEE NOTE # 3). 5. ALL TREES SHALL HAVE A MULCH RING WITH A MINIMUM DEPTH OF 2", MAXIMUM OF 3", AND A DIAMETER OF 3'-4' AROUND THEIR BASE. ALL MULCH SHOULD BE KEPT 2" FROM THE BASE OF ALL PLANT MATERIAL. MULCH BEDS SHALL BE A MINMUM OF 1'-0" WIDER THAN PLANTS

6. ALL TREES, PALMS AND OTHER PLANTS SHALL BE PLANTED WITH THE TOP OF THEIR ROOTBALLS NO DEEPER THAN THE FINAL

GRADE SURROUNDING THE PLANTING AREA; ( 1"+-)

7. \* LANDSCAPE AND LAWN IRRIGATION PERMITS SHALL BE REQUIRED.

(MEASURED FROM OUTSIDE EDGE OF FOLIAGE).

8. A PREPLANTING MEETING SHALL BE HELD WITH THE CITY LANDSCAPE DEPARTMENT PRIOR TO ANY INSTALLATION. 9. ALL SYNTHETIC BURLAP, SYNTHETIC STRING OR CORDS, OR WIRE BASKETS SHALL BE REMOVED BEFORE ANY TREES ARE

PLANTED. ALL SYNTHETIC TAPE (I.E. TAGGING TAPE, NURSERY TAPE) SHALL BE REMOVED FROM TRUNKS, BRANCHES, ETC. BEFORE INSPECTION. THE TOP ONE THIRD (1/3) OF ANY NATURAL BURLAP SHALL BE REMOVED OR TUCKED INTO THE PLANTING HOLE BEFORE TREES ARE BACK FILLED. 10. 3" - 4" OF MULCH IS RECOMMENDED FOR ALL PLANTING. (NON-CYPRESS)

11. SUBSTITUTION: PLANT SUBSTITUTION REQUESTS, FOR PLANT MATERIAL NOT OBTAINABLE IN THE TYPE AND SIZES SPECIFIED SHALL BE MADE PRIOR TO SUBMISSION OF BIDS. ALL SUBSTITUTION REQUESTS SHALL BE DIRECTED TO THE LANDSCAPE ARCHITECT FOR CONSIDERATION AND APPROVAL. IT IS THE LANDSCAPE CONTRACTOR'S OBLIGATION TO KNOW WHERE THEY CAN OBTAIN ALL MATERIAL AT THE

TIME OF BIDDING AND AT THE TIME A CONTRACT IS EXECUTED. 12. LANDSCAPE CONTRACTOR TO PROVIDE AN AUTOMATIC LAWN IRRIGATION SYSTEM GUARANTEEING 100% COVERAGE & MAINTAIN A 50% MIN. OVERLAP TO ALL LANDSCAPED AREAS. SYSTEM SHALL HAVE

A RAIN SENSOR DEVICE AS REQUIRED.

13. XERISCAPE PRINCIPLES SHALL BE APPLIED TO ALL SITES AS SPECIFIED IN "SOUTH FLORIDA WATER MANAGEMENT DISTRICT XERISCAPE PLANT GUIDE II." AS REQUIRED.

14. 6" TOPSOIL REQUIRED AROUND AND BENEATH ROOTBALL AND 3" MIN. SHREDDED APPROVED ORGANIC MULCH BEYOND TRUNK IN ALL DIRECTINS AND THROUGHOUT ALL HEDGES AND

15. ALL PROPOSED TREES TO BE RELOCATED SHALL BE ROOT PRUNED 8 WEEKS MINIMUM PRIOR TO CONSTRUCTION AND DONE ACCORDING TO GOOD NURSERY PRACTICE AS REQUIRED. TRENCH DEPTH SHALL BE 18"-36"; ROOT BALL SHALL BE A MINIMUM OF 60" WHEN ROOT PRUNED. FILL TRENCH WITH FIBROUS MATERIAL SUCH AS LEAVES, OR WOOD SHAVINGS. WATERING SHALL BE ONCE A WEEK DURING ROOT PRUNING. TORN ROOTS SHALL BE TRIMMED TO SOLID WOOD. RELOCATED TREES SHALL BE LIGHTLY PRUNED BY HAND. A ISA CERTIFIED ARBORIST SHALL ROOT PRUNE ANY AND ALL EXISTING TREES WITHIN PAVING/CURBING AREAS TO BE INSTALLED; VERIFY ON SITE WITH CITY LANDSCAPE DEPARTMENT PRIOR TO ANY INSTALLATION; FIELD VERIFY WITH GENERAL CONTRACTOR AS REQUIRED.

THEN 2-3 TIMES A WEEK UNTIL SYSTEM IS FULLY AUTOMATIC; OWNER TO SUPPLY WATER ON SITE. TRANSPLANT TREES W/ 60" TREE SPADE, AND / OR TREE CRANE. TRANSPLANTING HOLE SHALL BE AT LEAST 1/3 BIGGER THAN THE AREA THAT WAS TRENCHED FOR TRANSPLANTING.


LANDSCAPE CONTRACTOR SHALL WATER RELOCATED TREES W/ TEMPORARY IRRIGATION EVERYDAY FOR THE FIRST MONTH

16. GENERAL CONTRACTOR SHALL REMOVE ALL ROAD ROCK, ASPHALT, DEBRIS, ETC. IN ALL LANDSCAPE AREAS TO A MIN. DEPTH OF 30" AND PROVIDE PLANTING SOIL AS REQUIRED, (SEE SOIL SPECIFICATIONS).

17. GENERAL CONTRACTOR SHALL GRADE AND FILL ALL TREE & PALM HOLES ONCE TREES & PALMS ARE REMOVED AND OR RELOCATED.

SITE NUMBER: BASE MODEL: USB NRE 55 R3 ASSET TYPE: **CLASSIFICATION:** NEW OWNER: JAE REST. GROUP, LLC **BASE VERSION:** XXXXXXXX UPGRADE CLASSIFICATION:

> CORP. NEW BUILD PROJECT YEAR: 2017 **FURNITURE PACKAGE:** 2016 R3 DRAWING RELEASE 2016 R3

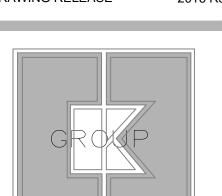

NCORPORATED engineering • architecture • planning 15500 NEW BARN ROAD

> SUITE 106 MIAMI LAKES, FLORIDA 33014 PHONE: (305) 558-4124 FAX: (305) 826-0619

HRANDANDER HE

PROJECT TYPE: USB NRE 55

1.1-19-17 CITY COMMENTS 2.5-15-17 CITY COMMENTS 3.5 - 01 - 184.5-24-17 CITY COMMENTS 5.7-30-18 CITY COMMENTS


PROJECT NUMBER: RBL#16-04-2066 DRAWN BY: RICK BARTLET CHECKED BY: RGB/MER

EDUARDO L. CARCACHE, PE 31914 ANA A. GONZALEZ VALDES, AR 97769 LUIS VARGAS, LEED AP

#701023753163800 CKE GROUP, INC. COA-4432

LANDSCAPE PLAN


SHEET NUMBER

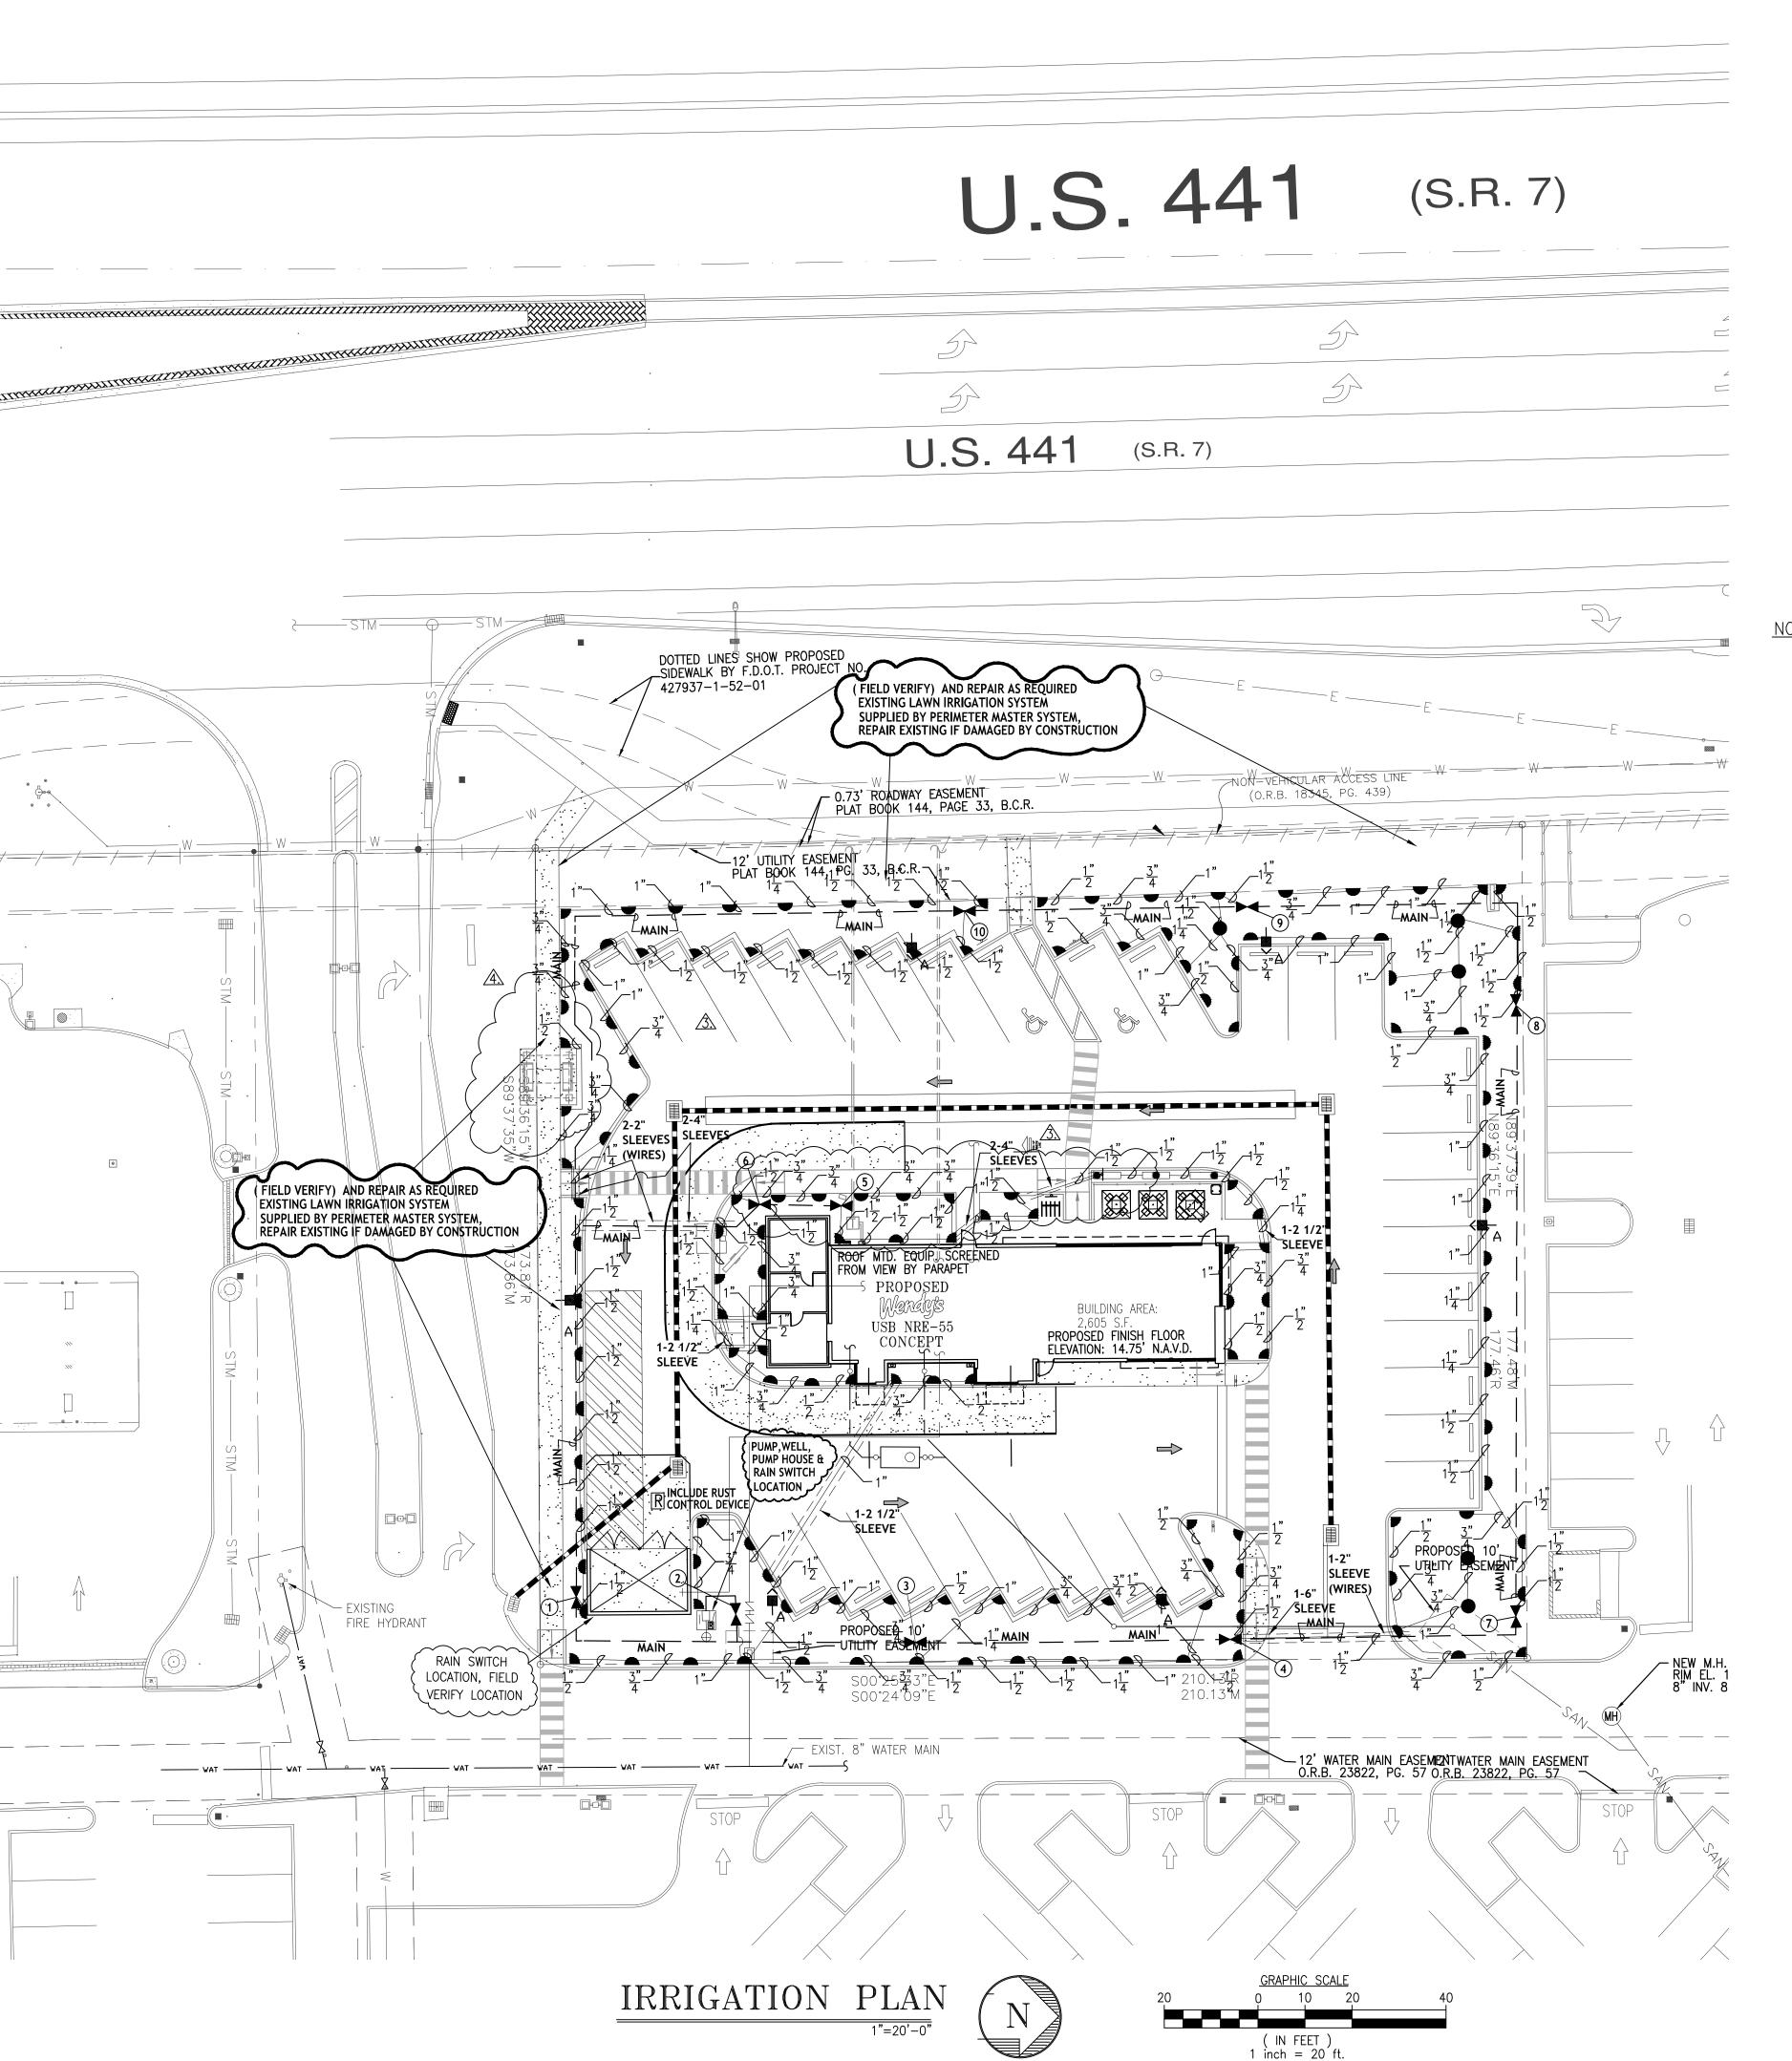

#### LEGAL DESCRIPTION

A PORTION OF TRACT "A", SAWGRASS PARK OF COMMERCE COMMERCIAL SECTION "B", ACCORDING TO THE MAP OR PLAT THEREOF AS RECORDED IN PLAT BOOK 144, PAGE 33, OF THE PUBLIC RECORDS OF BROWARD COUNTY, FLORIDA, BEING MORE PARTICULARLY DESCRIBED AS FOLLOWS:

COMMENCING AT THE SOUTHWEST CORNER OF SAID TRACT "A"; THENCE ALONG THE WESTERLY BOUNDARY OF SAID TRACT "A", THE SAME BEING THE EAST RIGHT-OF-WAY OF STATE ROAD No. 7 (U.S. HIGHWAY No. 441), FOR THE FOLLOWING FOUR (4) COURSES AND DISTANCES: (1) NOO'47'49"W, A DISTANCE OF 255.04 FEET, (2) NOO'45'33"W, A DISTANCE OF 199.97 FEET, (3) NORTHERLY ALONG A CURVE TO THE LEFT HAVING A RADIUS OF 11,559.16 FEET, AN ARC OF 32.67 FEET, A CHORD OF 32.67 FEET AND A CHORD BEARING OF NO0'50'24"W TO THE POINT OF BEGINNING, (4) NORTHERLY ALONG A CURVE TO THE LEFT HAVING A RADIUS OF 11,559.16 FEET, AN ARC OF 202.37 FEET, A CHORD OF 202.36 FEET AND A CHORD BEARING OF N01°25'22"W; THENCE N89°36'20"E, ALONG A LINE LYING 200.00 FEET SOUTH OF AND PARALLEL TO THE NORTH BOUNDARY OF SAID TRACT "A", A DISTANCE OF 177.16 FEET; THENCE S00'23'18"E, A DISTANCE OF 202.33 FEET; THENCE S89'36'20"W, A DISTANCE OF 173.51 FEET TO THE POINT OF BEGINNING. CONTAINING 35,416 SQUARE FEET OR 0.81 ACRES, MORE OR LESS.

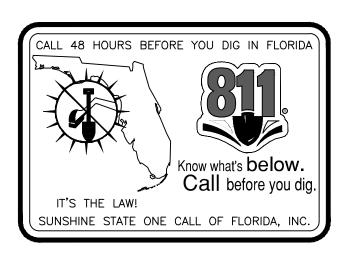

NOTE: ZONE RUN TIME ACTIVITY SHALL BE 25 MINUTES FOR THE FIRST 30 DAYS (EXCEPT FRIDAYS) FOR THE ESTABLISHMENT OF THE PLANT MATERIALS, AFTER THE ESTABLISHMENT OF PLANT MATERIAL THE ZONÈS SHALL RUN Á MAXIMUM OF 20 MINUTES EACH ZONE TWICE WEEKLY OR AS DIRECTED BY THE "SOUTH FLORIDA WATER MANAGEMENT DISTRICT" RESTRICTION REQUIREMENTS.

TORO S	SPRY NOZZLES 570 W/ 6" & 12" (BED AREAS) SPRINKLER BOD	Υ					
SYMBOL	MODEL NUMBER	AREA	<u>GPM</u>	PRECIPITATION			
	CENTER STRIP - 4' CST	4'x30'	1.20	.68 IN/H			
	HALF - 15' H	15' RAD	2.00	1.29 IN/H			
4	QUARTER – 15' Q	15' RAD	1.00	1.17 IN/H			
	END STRIP - 4' EST	4'x15'	0.60	.34 IN/H			
	TORO SERIES S700 GEAR DRIVEN ROTARY SPRINKLER	42' RAD	3.50	1.93 IN/H			
	SIDE STRIP - 4' SST	4'x30'	1.45	.75 IN/H			
	FULL - 15' F	15' RAD	4.00	1.95 IN/H			
	2 HP STARITE SELF PRIMING PUMP, MODEL #DHJ, DELIVERING @ 35 PSI OR EQUIVALENT 220 VOLT (OR EQUAL) W/ PUMP S	55 GPM START					
M	TORO SERIES LOW VOLTAGE CONTROL VALVES 1" & 1 1/2" W/ DIRECT BURIAL #14 WIRE AS REQUIRED						
	1 1/2" SCH. 40 PVC MAIN LINE AS SHOWN						
	RAIN BIRD ESP-SMTe WATER SENSE CERTIIFIED 12 ZONE TIME CONTROLLER RAIN SWITCH READY 220/24 VOLT						
_	TORO RAIN SWITCH MODEL # 850-74						
<del> </del>	2" WELL SUPPLY (WATER PERMIT BY OTHERS)						
R	RUST CONTROLL DEVICE-SEE SPECIFICATIONS SHEET=DETAIL #1						

SEE DETAIL #1 ON SPECIFICATION SHEET											
<u>ZONE</u>	1	2	3	4	5	6	7	8	9	10	11
# HEADS	14	17	15	10	20	14	11	15	12	21	_
<u>G. P. M.</u>	24.00	23.00	24.00	24.00	25.40	23.00	22.00	31.00	21.00	33.00	_

#### **NOTES**


- 1. ALL LANDSCAPED AREAS SHALL BE PROVIDED WITH AN UNDERGROUND FULLY AUTOMATIC LAWN IRRIGATION SYSTEM USING POP UP HEADS; SYSTEM SHALL GUARANTEE 100% COVERAGE & A 50% MIN. OVERLAP; SYSTEM SHALL HAVE A RAIN SENSOR DEVICE THAT WILL OVERRIDE SYSTEM WHEN ADEQUATE RAINFALL HAS OCCURRED. HOURS OF OPERATION SHALL BE LIMITED TO 5:00 PM TO 8:00 AM ONLY; OR ANY RESTRICTIONS BY SOUTH FLORIDA WATER MANAGEMENT DISTRICT OR OTHER JURISDICTIONAL AGENCY.
- 2. WATER SOURCE SHALL BE FROM A PUMP & WELL SYSTEM SUPPLIED BY OWNER.
- 3. WATER SHALL NOT BE DIRECTED AND/OR PROVIDED ONTO IMPERVIOUS SURFACES AND/ OR BE DESIGNED OR INSTALLED TO THROW WATER OVER AN IMPERVIOUS SURFACE SUCH AS A SIDEWALK, DRIVE, ETC..
- 4. GENERAL CONTRACTOR TO SUPPLY AND INSTALL SLEEVES AS SHOWN AND PROVIDE ELECTRICAL HOOK-UP AS REQUIRED.
- 5. HEADS TO BE INSTALLED IN PLANTERS AND BED AREAS SHALL BE 12" POP UP OR MUST BE APPROVED BY LANDSCAPE ARCHITECT TO BE LOCATED ON RISERS PRIOR TO INSTALLATION.
- 6. PIPE INSTALLATION IN VEHICLE TRAFFIC AREAS SHALL BE AS FOLLOWS: PBC V-A-1.: PIPE SIZE (INCHES) DEPTH OF COVER (INCHES)
- 1/2-2 1/2 18<sup>"</sup>-24" 3-5 24"-30"

- 7. HEADS TO BE INSTALLED IN PLANTERS AND BED AREAS SHALL BE 12" POP UP OR MUST BE APPROVED BY LANDSCAPE ARCHITECT TO BE LOCATED ON RISERS PRIOR TO INSTALLATION. ALL RISERS SHALL BE PAINTED FLAT BLACK IF APPROVED.
- 8. IRRIGATION CONTRACTOR TO SELECT NOZZLE SIZE BASED ON INTENDED THROW WITHIN 25% OF MAXIMUM DESIGN THROW.

BASE MODEL: USB NRE 55 R3 ASSET TYPE: FRAN CLASSIFICATION: NEW JAE REST. GROUP, LLC BASE VERSION: XXXXXXXX UPGRADE CLASSIFICATION:

SITE NUMBER:

CORP. NEW BUILD PROJECT YEAR: 2017 **FURNITURE PACKAGE:** 2016 R3 DRAWING RELEASE 2016 R3

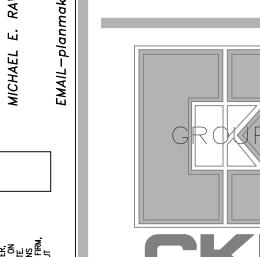

© COPYRIGHT
THE FOLLOWING DRAWINGS
THE LANDSCAPE ARCHITEC
DESIGN. ALL DEAS, DESIGN
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AND ARE CREATED, EVO
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NONE OF SUCH DIEAS, D
AND SPECIFICATIONS BY
OR CORPORATION FOR AN
THE WRITTEN PERMISSION

INCORPORATED engineering \*architecture \*planning 15500 NEW BARN ROAD SUITE 106

PROJECT TYPE: USB NRE 55

MIAMI LAKES , FLORIDA 33014

PHONE: (305) 558-4124

FAX: (305) 826-0619

NEW

REV. DATE 1-19-17 CITY COMMENTS 2.5-15-17 CITY COMMENTS <u>3. 05-01-18</u>


4.7-30-18 CITY COMMENTS


PROJECT NUMBER: RBL#16-04-2066 DRAWN BY: RICK BARTLETT CHECKED BY: RGB/MER


EDUARDO L. CARCACHE, PE 31914 ANA A. GONZALEZ VALDES, AR 97769 LUIS VARGAS, LEED AP #701023753163800 CKE GROUP, INC. COA-4432


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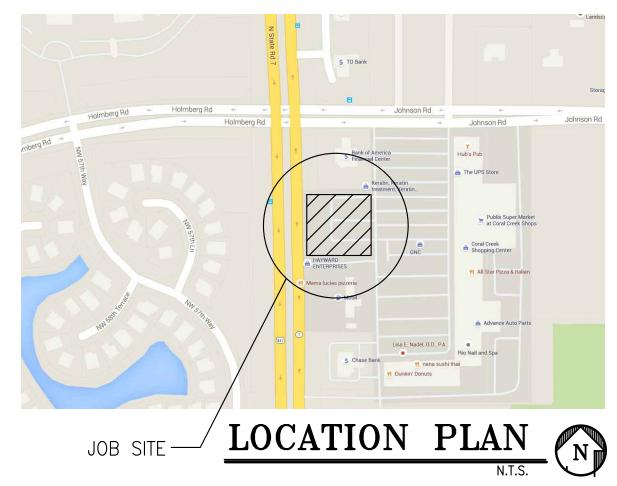
IRRIGATION PLAN




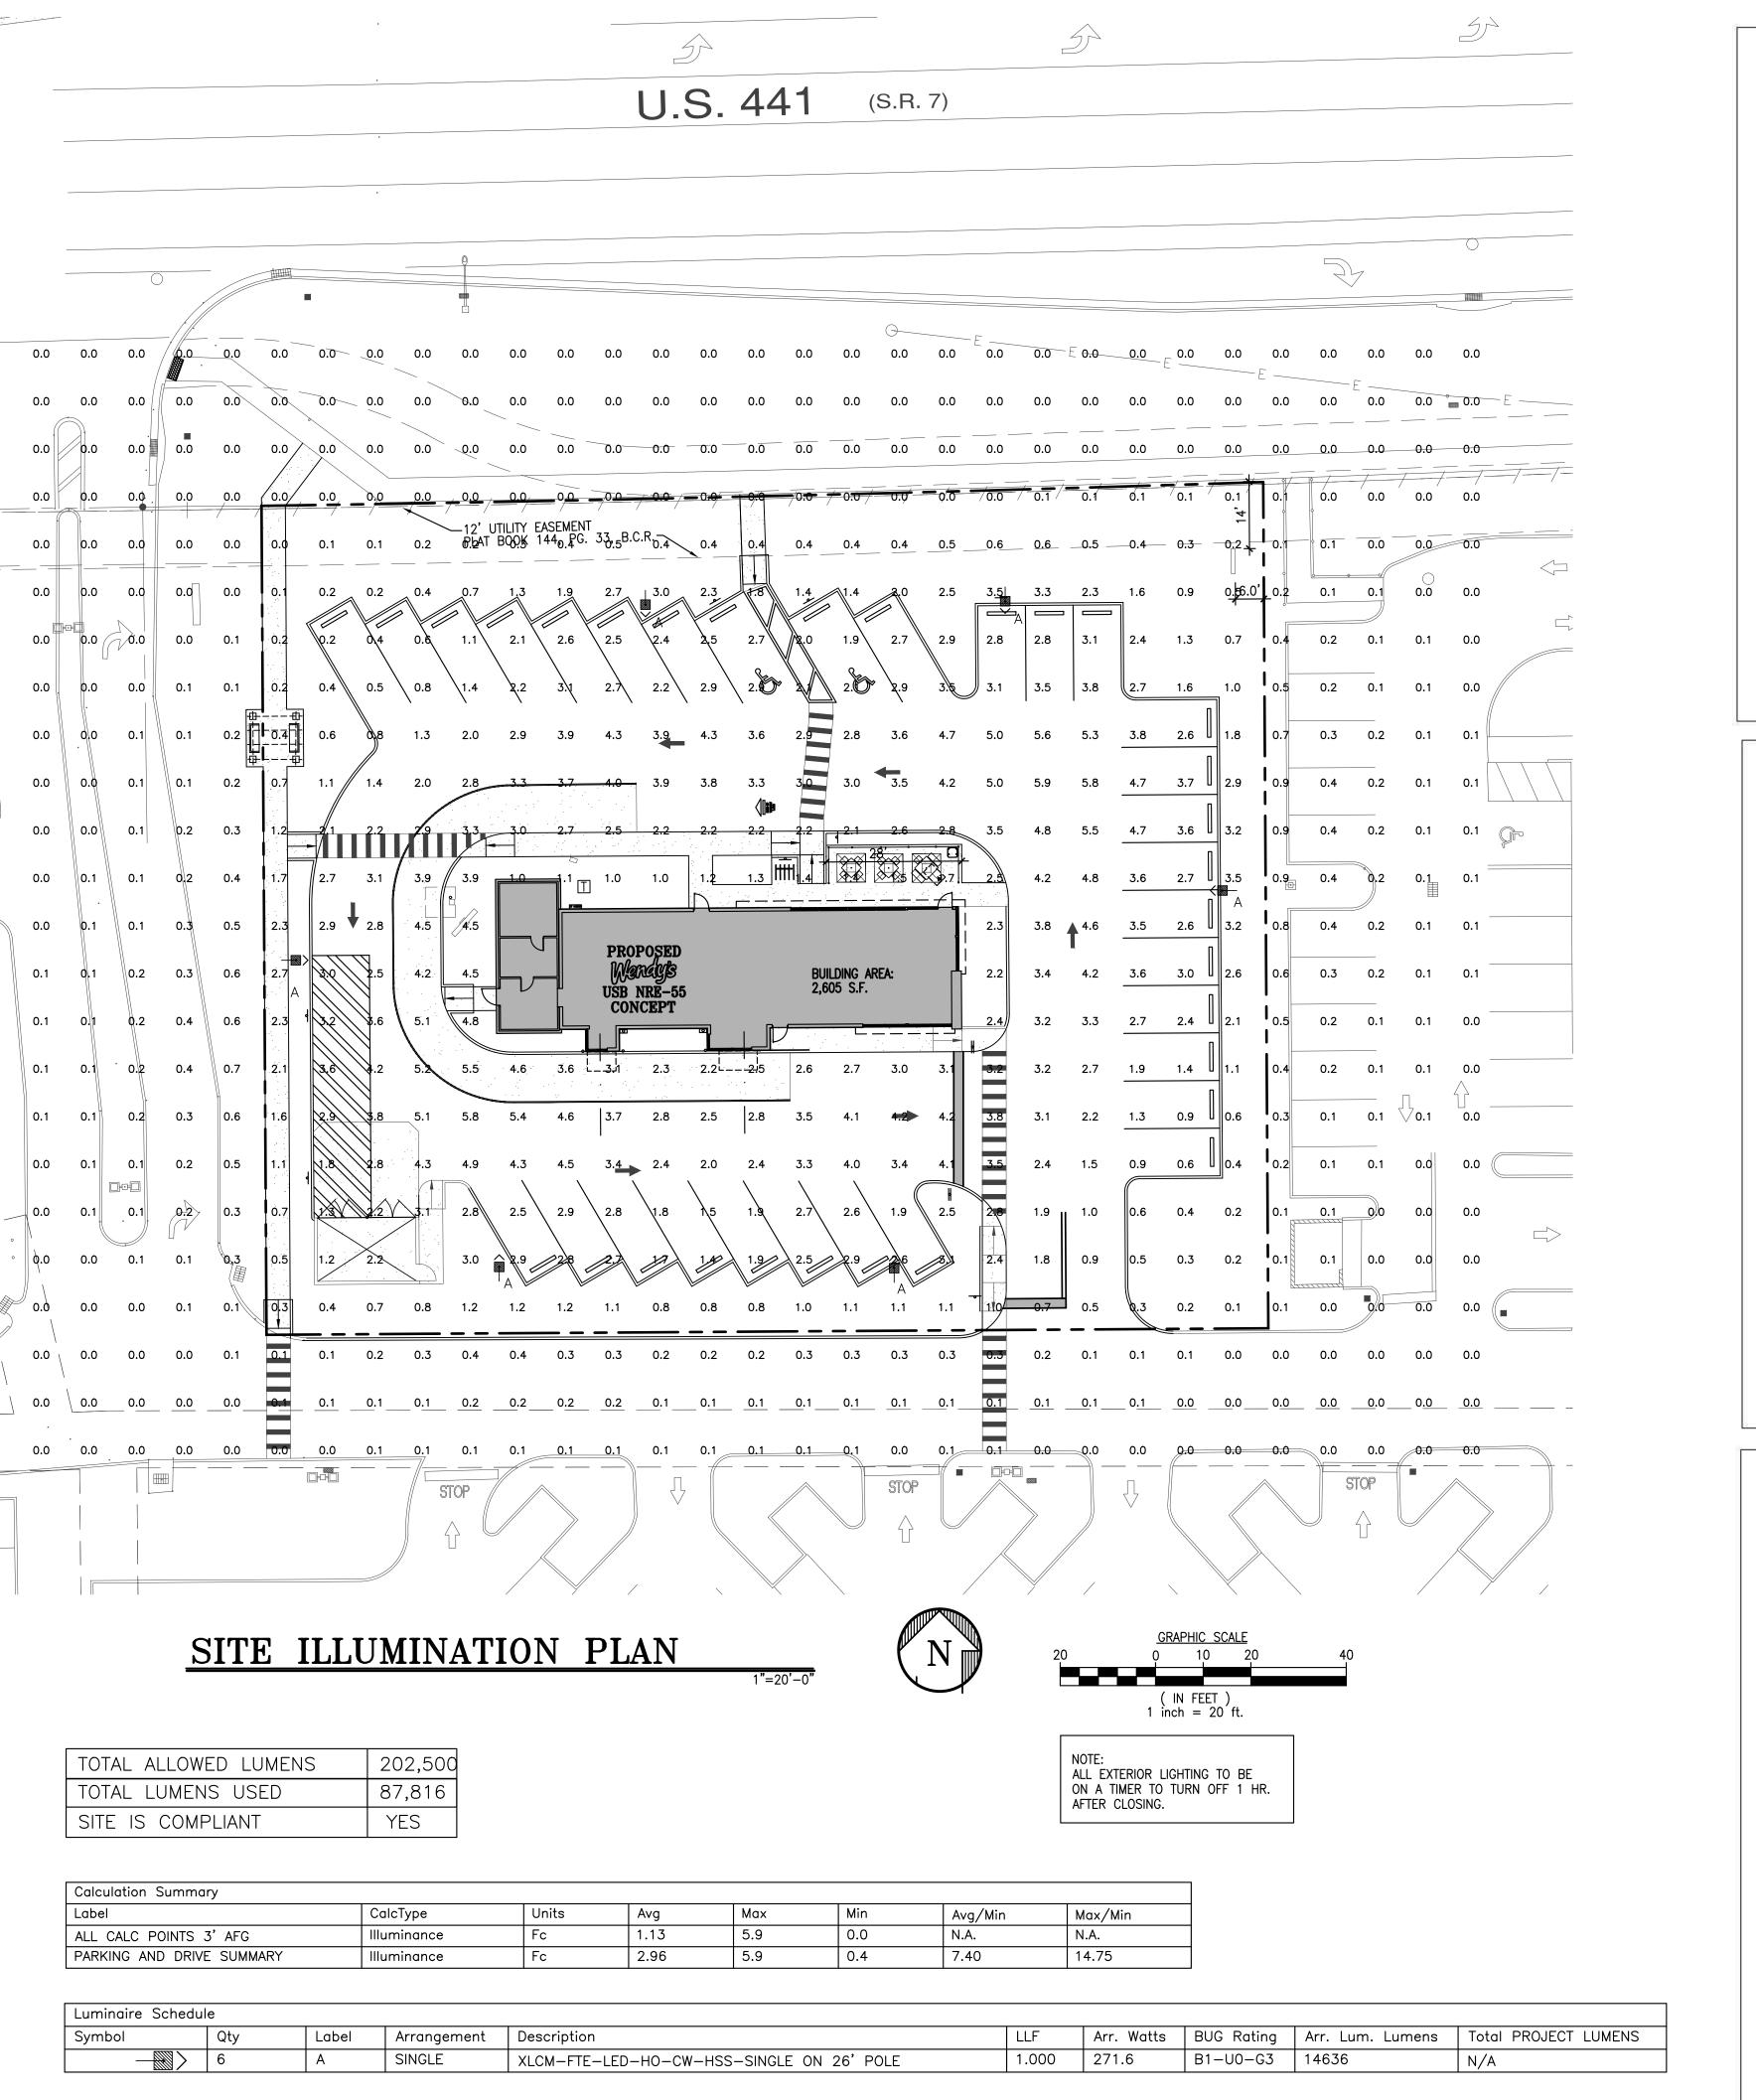

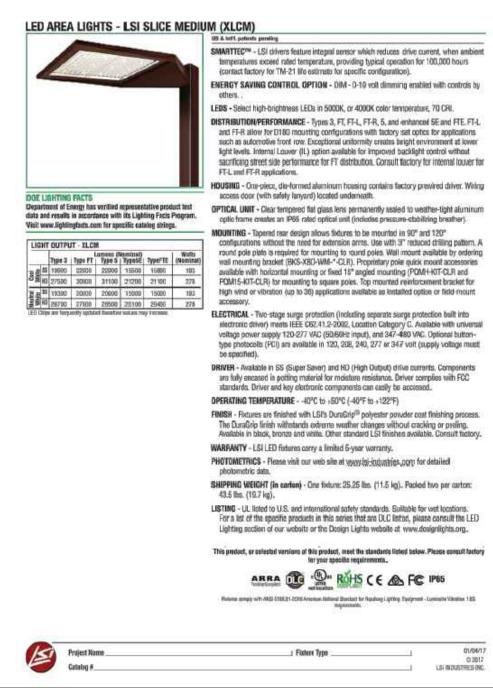

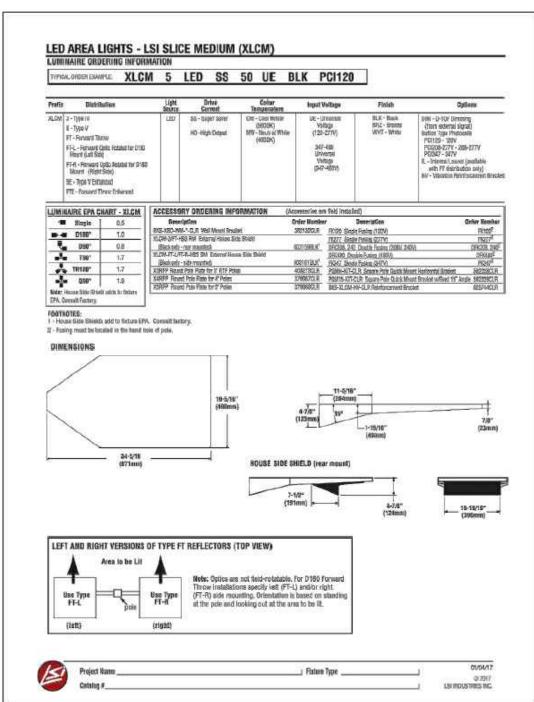

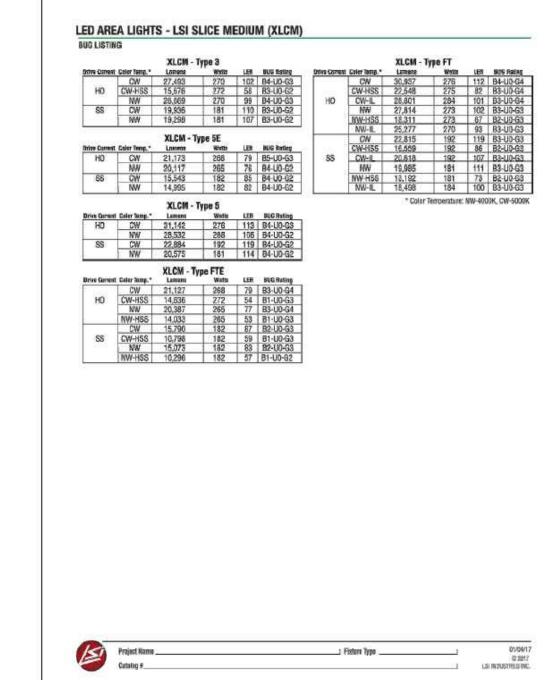

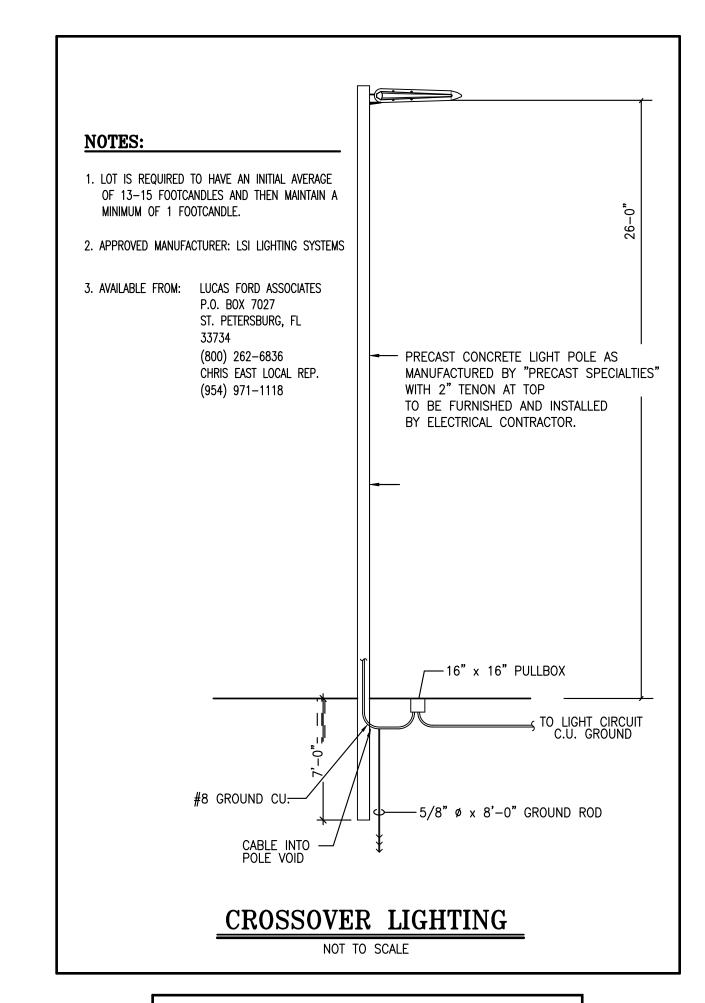


#### NOTES:

This lighting pattern represents illumination levels calculated from laboratory data taken under controlled conditions utilizing current industry standard lamp ratings in accordance with Illuminating Engineering Society approved methods. Actual performance of any manufacturer's luminaire may vary due to variation in electrical voltage, tolerance in lamps and other variable field conditions. Calculations do not include obstructions such as buildings, curbs, landscaping, or any other architectural elements unless noted.

PROJECT YEAR: 2017

FURNITURE PACKAGE: 2016 R3

DRAWING RELEASE 2016 R3

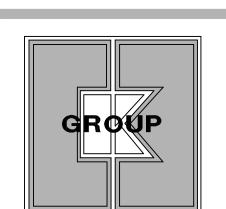

CKE
GROUP
INCORPORATED
engineering • architecture • planning
15500 NEW BARN ROAD

MIAMI LAKES , FLORIDA 33014

PHONE: (305) 558-4124

FAX: (305) 826-0619

...

PROJECT TYPE: USB NRE 55 NEW

Lore # 11670 S 441 & JOHNSON ROAD

REV. DATE DESCRIPTION

1 05-01-18

ISSUE DATE: 02/10/2016
PROJECT NUMBER: 1493

E. C. SEAL

CHECKED BY:


EDUARDO L. CARCACHE, PE 31914 ANA A. GONZALEZ VALDES, AR 97769 LUIS VARGAS, LEED AP #701023753163800 CKE GROUP, INC. COA-4432

PHOTOMETRICS PLAN

SHEET NAME

PH-1

SHEET NUMBER

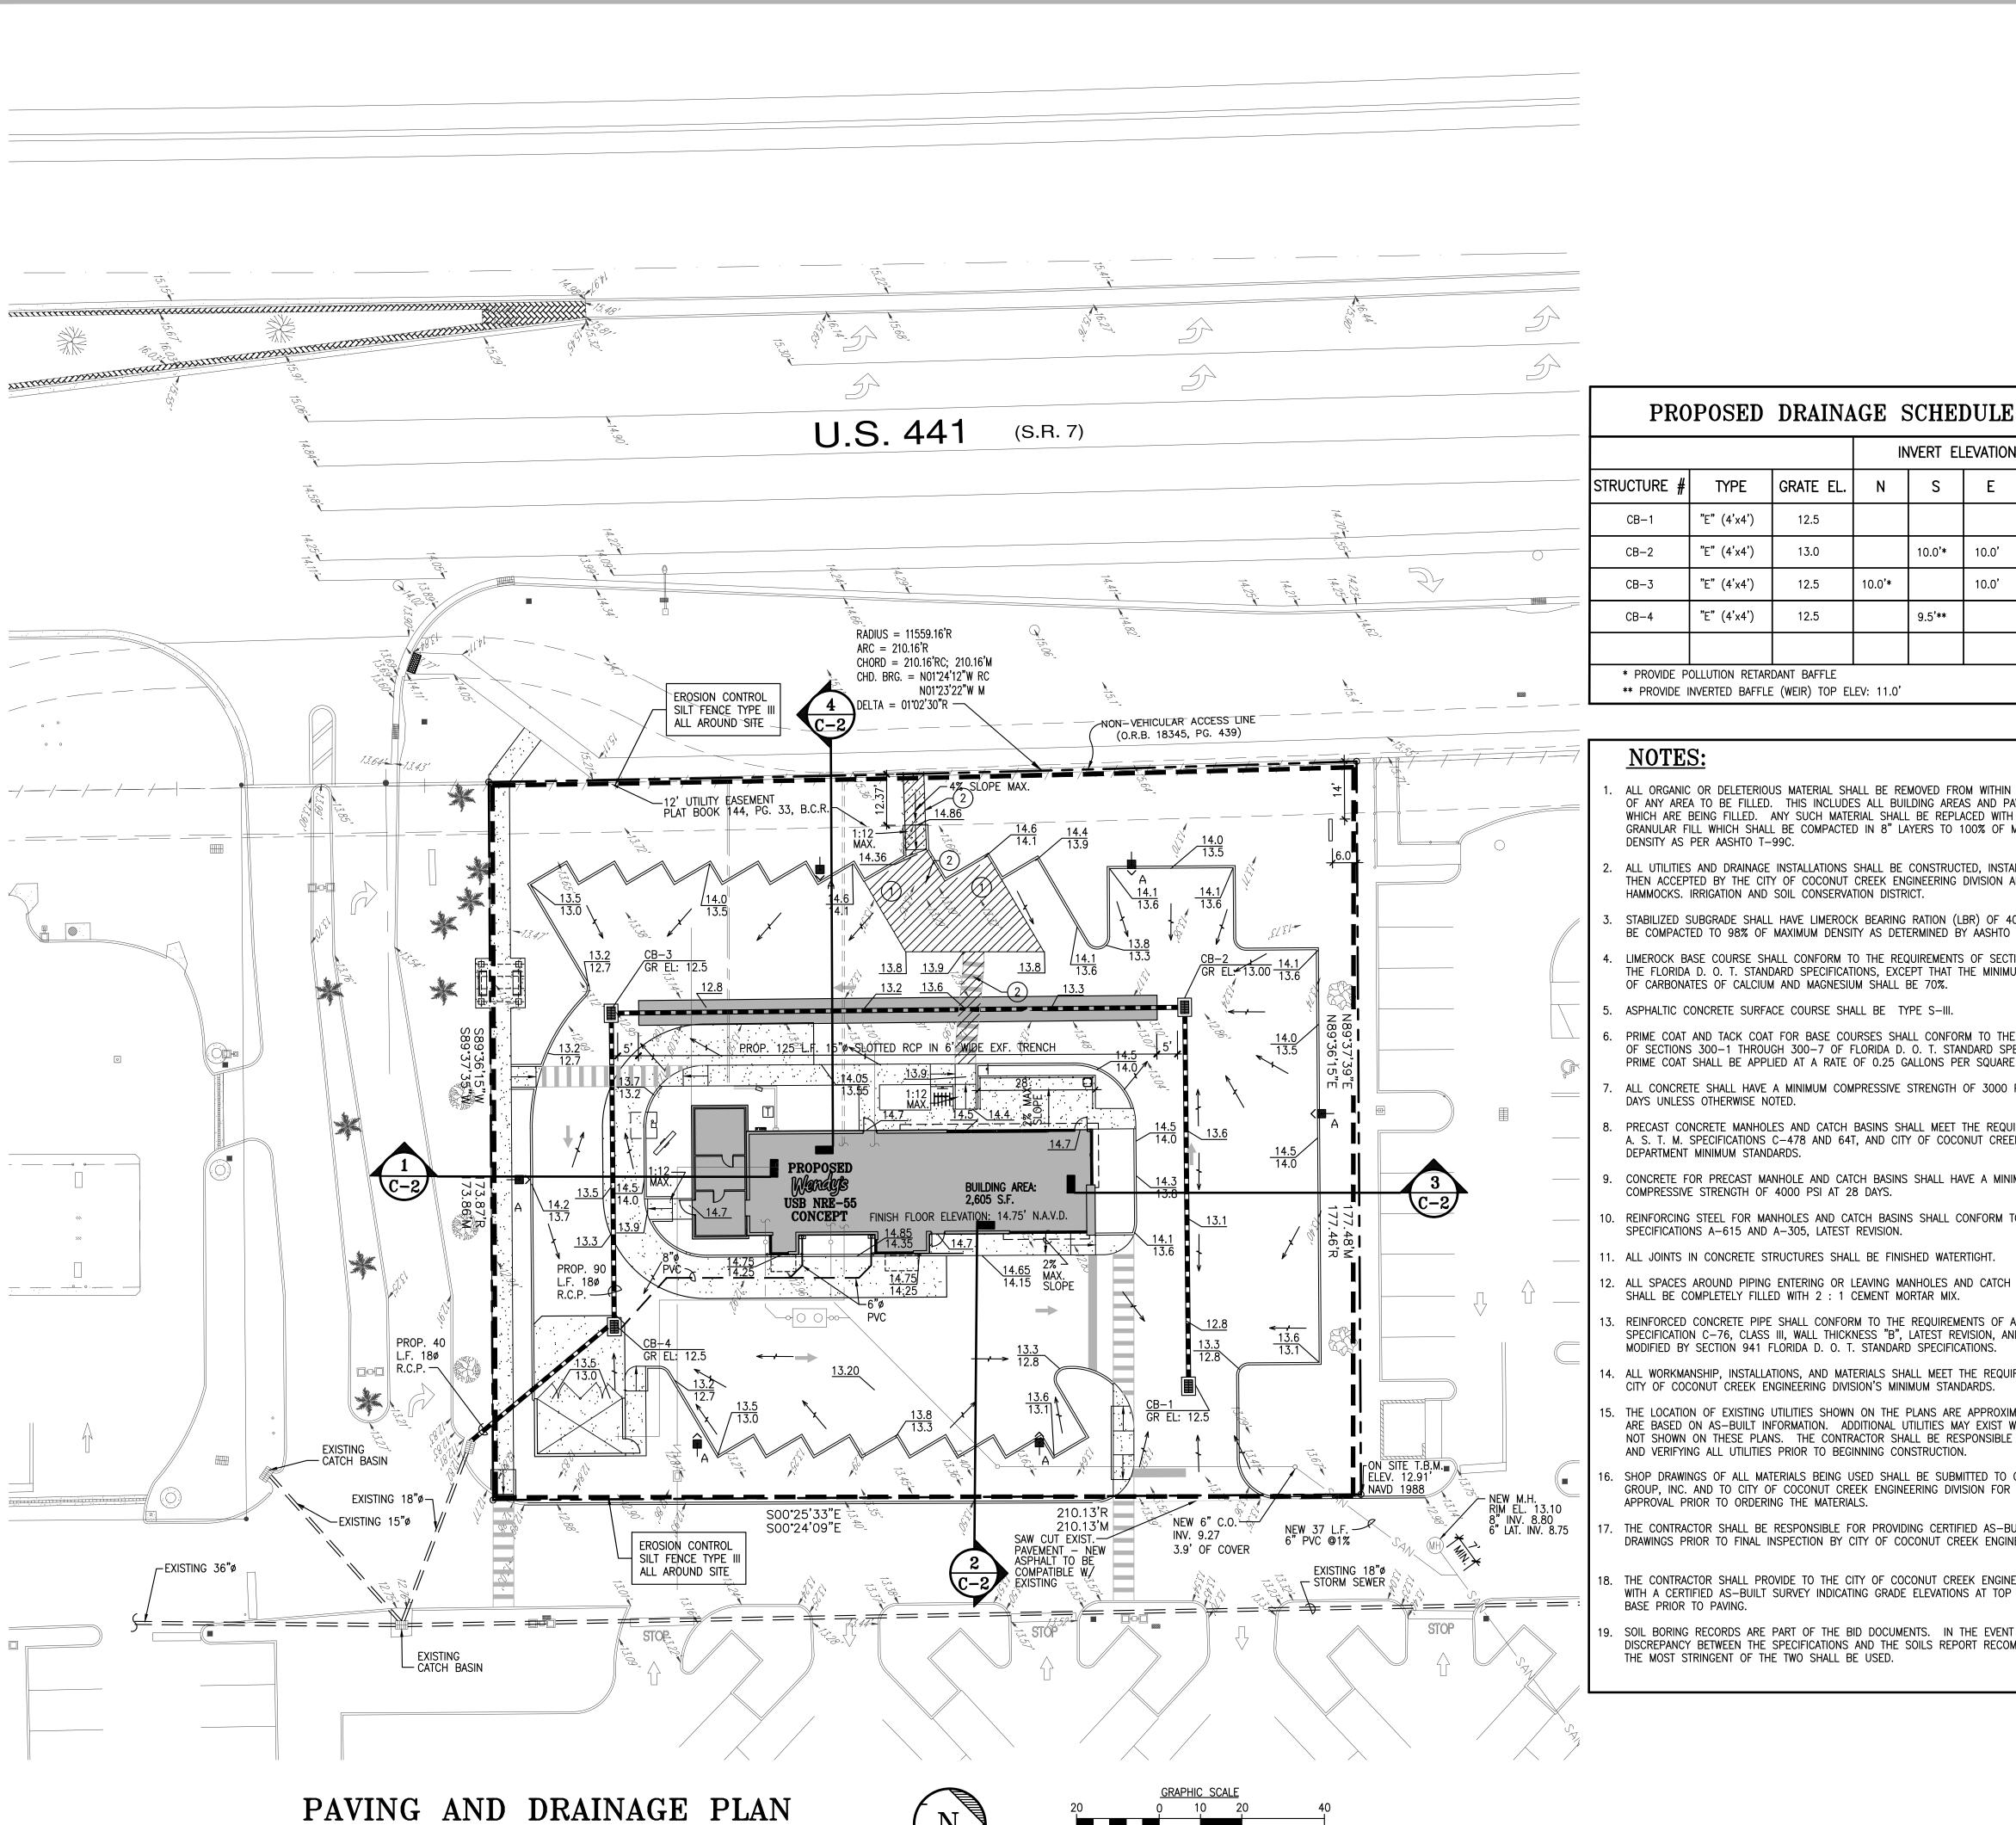

( IN FEET



A PORTION OF TRACT "A", SAWGRASS PARK OF COMMERCE COMMERCIAL SECTION "B", ACCORDING TO THE PLAT THEREOF, AS RECORDED IN PLAT BOOK 144, PAGE 33, OF THE PUBLIC RECORDS OF BROWARD COUNTY, FLORIDA, BEING MORE PARTICULARLY DESCRIBED AS FOLLOWS.

COMMENCING AT THE WESTERLY NORTHWEST CORNER OF SAID TRACT "A", SAID POINT BEING ON THE EASTERLY RIGHT-OF-WAY LINE OF U.S. HIGHWAY NO. 441 (STATE ROAD NO. 7) AS SHOWN ON SAID PLAT AND ON THE ARC OF A CURVE CONCAVE WESTERLY, TO WHICH A RADIAL LINE BEARS NORTH 87"2'47" EAST; THENCE SOUTHERLY ON SAID EASTERLY RIGHT-OF-WAY LINE, ON THE WESTERLY LINE OF SAID TRACT "A" AND ON THE ARC OF A CURVE TO THE RIGHT, HAVING A RADIUS OF 11,559.16 FEET, A CENTRAL ANGLE OF 0°51'46", FOR AN ARC DISTANCE OF 174.06 FEET TO THE POINT OF BEGINNING; THENCE NORTH 89°36'15" EAST ON A NON-RADIAL LINE 177.46 FEET; THENCE SOUTH 00°25'33" EAST 210.13 FEET; THENCE SOUTH 89°36'15" WEST ON A LINE NON-RADIAL TO THE FOLLOWING DESCRIBED CURVE 173.87 FEET TO THE INTERSECTION WITH THE AFOREMENTIONED EASTERLY RIGHT-OF-WAY LINE OF U.S. HIGHWAY NO. 441 (STATE ROAD NO. 7), SAID WESTERLY LINE OF TRACT "A" AND A POINT ON SAID CURVE CONCAVE WESTERLY, TO WHICH A RADIAL LINE BEARS NORTH 89°07'03" EAST; THENCE NORTHERLY ON THE ARC OF SAID CURVE TO THE LEFT, HAVING A RADIUS OF 11,559.16 FEET, A CENTRAL ANGLE OF 1'02'30", FOR AN ARC DISTANCE OF 210.16 FEET TO THE POINT OF BEGINNING.

SAID LANDS SITUATE, LYING AND BEING IN THE CITY OF COCONUT CREEK, BROWARD COUNTY, FLORIDA, CONTAINING 36,846 SQUARE FEET (0.8459 ACRES), MORE OR LESS.

#### **NOTES:**

LEGAL DESCRIPTION

- SITE CONTRACTOR SHALL GRADE ALL LANDSCAPED AREAS TO AN ELEVATION 3" BELOW TOP OF CURB OR SIDEWALK.
- 2. SITE CONTRACTOR IS RESPONSIBLE FOR GRADING ALL SITE, INCLUDING BERMS AND SWALES, IF ANY. COORDINATE WITH LANDSCAPE DRAWINGS AND LANDSCAPE
- 3. SITE CONTRACTOR IS RESPONSIBLE FOR POSITIVE DRAINAGE OVER ENTIRE SITE.
- 4. GENERAL CONTRACTOR SHALL PROVIDE SLEEVES FOR LANDSCAPE IRRIGATION LINES PRIOR TO PAVING. COORDINATE WITH IRRIGATION DRAWINGS AND IRRIGATION CONTRACTOR.
- 5. ELEVATION SHOWN HEREON ARE BASED ON THE NORTH AMERICAN VERTICAL DATUM OF 1988 (N.A.V.D. 1988) AS ESTABLISHED FROM N.G.S. CONTINUOUSLY OPERATING REFERENCE STATIONS (C.O.R.S.)"MIAMI WAAS 1 CORS ARP", MIAMI TNT CORS ARP" AND "WEST PALM CORS ARP" USING THE ONLINE USER SERVICE (O.P.U.S.) ON APRIL 26, 2016. TO CONVERT ELEVATIONS TO THE NATIONAL GEODETIC VERTICAL DATUM OF 1929 (N.G.V.D. 1929) ADD
- 6. TRANSVERSE SLOPES OF PAVEMENT SHALL BE 2% MIN. FOR ROADWAYS & 1% MIN. FOR PARKING.
- 7. LONGITUDINAL SLOPE OF PAVEMENT SHALL BE

#### **LEGEND**

PROP. DIRECTION OF DRAINAGE FLOW ARROW EXISTING ELEVATION

9.0

PROP. TOP OF CURB & FINISHED GRADE ELEV. PROPOSED ELEVATIONS

G.C. TO VERIFY MAX. 2% SLOPE AT HANDICAP SPACE AND ACCESSIBILITY ROUTE

SLOPE ALONG ACCESS PATH NOT TO EXCEED 5% SLOPE ALONG PATH AND MAX. 2% CROSS

#### ZONING: B-3 COMMUNITY SHOPPING DISTRICT LAND USE: COMMERCIAL BUILDING HEIGHT: 26-9 1/2"

	SITE ANALYSIS	
	<u>EXISTING</u>	PROPOSED
TOTAL LAND AREA:	36,846.00 SQ. FT. ( 0.846± ACRES )	36,846.00 SQ. FT. ( 0.846± ACRES )
TOTAL BUILDING COVERAGE:	-	2,605.00 SQ. FT. ( 7.07 % )
TOTAL LANDSCAPED AREA:	8,056.38 SQ. FT. ( 21.87 % )	12,914.80 SQ. FT. ( 35.05 % )
TOTAL PAVED AREA & WALKS:	28,789.62 SQ. FT. ( 78.13 % )	21,326.20 SQ. FT. ( 57.88 % )
PERVIOUS AREA:	8,056.38 SQ. FT. ( 21.87 % ) (0.185± ACRES)	12,914.80 SQ. FT. ( 35.05 % ) (0.296± ACRES)
IMPERVIOUS AREA:	28,789.62 SQ. FT.	23,931.20 SQ. FT.

( 78.13 % ) (0.661± ACRES)

( 64.95 % ) (0.549± ACRES)

INCORPORATED 15500 NEW BARN ROAD

GROUP

SITE NUMBER:

BASE MODEL:

ASSET TYPE:

CLASSIFICATION:

BASE VERSION:

PROJECT YEAR:

FURNITURE PACKAGE:

DRAWING RELEASE

OWNER: JAE REST. GROUP, LLC

UPGRADE CLASSIFICATION:

USB NRE 55 R3

XXXXXXXX

2016 R3

CORP. NEW BUILD

SUITE 106 MIAMI LAKES , FLORIDA 33014

PROJECT TYPE: USB NRE 55

1 05-01-18 2 07-18-18


EDUARDO L. CARCACHE, PE 31914 ANA A. GONZALEZ VALDES, AR 97769 LUIS VARGAS, LEED AP #701023753163800

SHEET NAME


CKE GROUP, INC. COA-4432

PAVING & DRAINAGE

SHEET NUMBER

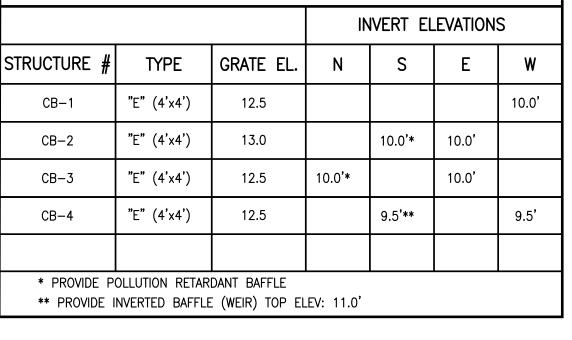



- ALL ORGANIC OR DELETERIOUS MATERIAL SHALL BE REMOVED FROM WITHIN 10 FEET OF ANY AREA TO BE FILLED. THIS INCLUDES ALL BUILDING AREAS AND PAVING AREAS WHICH ARE BEING FILLED. ANY SUCH MATERIAL SHALL BE REPLACED WITH APPROVED GRANULAR FILL WHICH SHALL BE COMPACTED IN 8" LAYERS TO 100% OF MAXIMUM DENSITY AS PER AASHTO T-99C.
- 2. ALL UTILITIES AND DRAINAGE INSTALLATIONS SHALL BE CONSTRUCTED, INSTALLED, AND THEN ACCEPTED BY THE CITY OF COCONUT CREEK ENGINEERING DIVISION AND TINDALL HAMMOCKS. IRRIGATION AND SOIL CONSERVATION DISTRICT.
- STABILIZED SUBGRADE SHALL HAVE LIMEROCK BEARING RATION (LBR) OF 40 AND SHALL BE COMPACTED TO 98% OF MAXIMUM DENSITY AS DETERMINED BY AASHTO T-99C.
- LIMEROCK BASE COURSE SHALL CONFORM TO THE REQUIREMENTS OF SECTION 911 OF THE FLORIDA D. O. T. STANDARD SPECIFICATIONS, EXCEPT THAT THE MINIMUM PERCENTAGE
- 5. ASPHALTIC CONCRETE SURFACE COURSE SHALL BE TYPE S-III.
- 6. PRIME COAT AND TACK COAT FOR BASE COURSES SHALL CONFORM TO THE REQUIREMENTS OF SECTIONS 300-1 THROUGH 300-7 OF FLORIDA D. O. T. STANDARD SPECIFICATIONS. PRIME COAT SHALL BE APPLIED AT A RATE OF 0.25 GALLONS PER SQUARE YARD.
- 7. ALL CONCRETE SHALL HAVE A MINIMUM COMPRESSIVE STRENGTH OF 3000 PSI AT 28 DAYS UNLESS OTHERWISE NOTED.
- PRECAST CONCRETE MANHOLES AND CATCH BASINS SHALL MEET THE REQUIREMENTS OF A. S. T. M. SPECIFICATIONS C-478 AND 64T, AND CITY OF COCONUT CREEK ENGINEERING DEPARTMENT MINIMUM STANDARDS.
- 9. CONCRETE FOR PRECAST MANHOLE AND CATCH BASINS SHALL HAVE A MINIMUM COMPRESSIVE STRENGTH OF 4000 PSI AT 28 DAYS.
- 10. REINFORCING STEEL FOR MANHOLES AND CATCH BASINS SHALL CONFORM TO A. S. T. M. SPECIFICATIONS A-615 AND A-305, LATEST REVISION.
- 11. ALL JOINTS IN CONCRETE STRUCTURES SHALL BE FINISHED WATERTIGHT.
- 12. ALL SPACES AROUND PIPING ENTERING OR LEAVING MANHOLES AND CATCH BASINS SHALL BE COMPLETELY FILLED WITH 2 : 1 CEMENT MORTAR MIX.
- 13. REINFORCED CONCRETE PIPE SHALL CONFORM TO THE REQUIREMENTS OF A. S. T. M. SPECIFICATION C-76, CLASS III, WALL THICKNESS "B", LATEST REVISION, AND AS MODIFIED BY SECTION 941 FLORIDA D. O. T. STANDARD SPECIFICATIONS.
- ALL WORKMANSHIP, INSTALLATIONS, AND MATERIALS SHALL MEET THE REQUIREMENTS OF CITY OF COCONUT CREEK ENGINEERING DIVISION'S MINIMUM STANDARDS.
- 15. THE LOCATION OF EXISTING UTILITIES SHOWN ON THE PLANS ARE APPROXIMATE AND ARE BASED ON AS-BUILT INFORMATION. ADDITIONAL UTILITIES MAY EXIST WHICH ARE NOT SHOWN ON THESE PLANS. THE CONTRACTOR SHALL BE RESPONSIBLE FOR LOCATING AND VERIFYING ALL UTILITIES PRIOR TO BEGINNING CONSTRUCTION.
- SHOP DRAWINGS OF ALL MATERIALS BEING USED SHALL BE SUBMITTED TO C. K. E. GROUP, INC. AND TO CITY OF COCONUT CREEK ENGINEERING DIVISION FOR APPROVAL PRIOR TO ORDERING THE MATERIALS.
- THE CONTRACTOR SHALL BE RESPONSIBLE FOR PROVIDING CERTIFIED AS-BUILT DRAWINGS PRIOR TO FINAL INSPECTION BY CITY OF COCONUT CREEK ENGINEERING DIVISION.
- THE CONTRACTOR SHALL PROVIDE TO THE CITY OF COCONUT CREEK ENGINEERING DIVISION WITH A CERTIFIED AS-BUILT SURVEY INDICATING GRADE ELEVATIONS AT TOP OF LIMEROCK BASE PRIOR TO PAVING.
- SOIL BORING RECORDS ARE PART OF THE BID DOCUMENTS. IN THE EVENT OF DISCREPANCY BETWEEN THE SPECIFICATIONS AND THE SOILS REPORT RECOMMENDATIONS, THE MOST STRINGENT OF THE TWO SHALL BE USED.

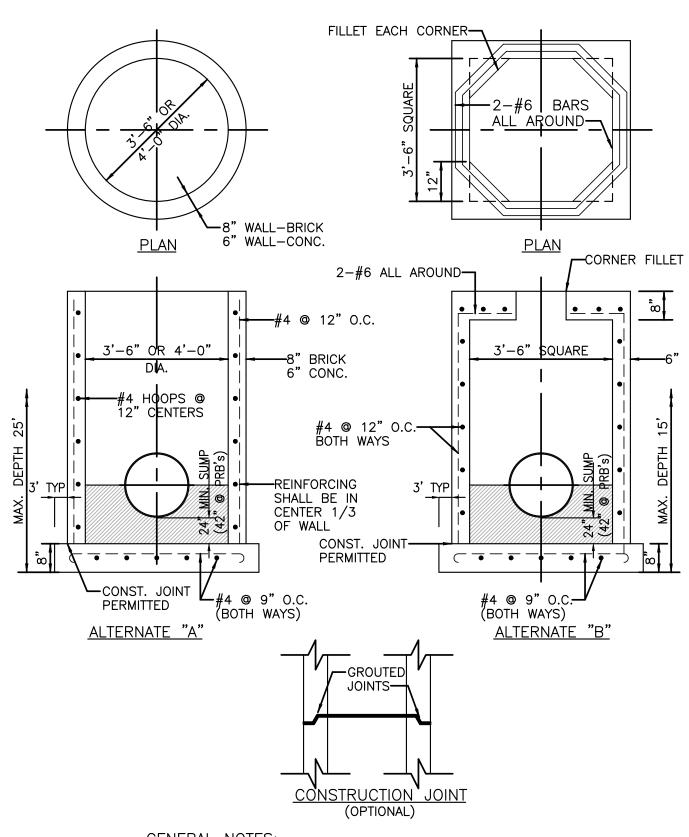


#### **GENERAL NOTES:**

- CIRCULAR STRUCTURES (ALTERNATES 'A') MAY BE CONSTRUCTED OF CONCRETE OR BRICK, BUT RECTANGULAR STRUCTURES (ALTERNATES 'B' & 'C') SHALL BE CONSTRUCTED OF CONCRETE ONLY. THE CONCRETE MAY BE CAST—IN—PLACE OR PRECAST.
- 2. WALL REINFORCEMENT AND THICKNESS ARE FOR EITHER CAST—IN—PLACE OR PRECAST CONCRETE EXCEPT THAT FOR PRECAST CIRCULAR UNITS A.S.T.M. SPECIFICATIONS C—76, TABLE III, FOR B WALL REINFORCED CONCRETE PIPE OR PRECAST CIRCULAR UNITS IN ACCORDANCE WITH ASTM SPECIFICATION C—478 WILL BE ACCEPTABLE. TOP AND FLOOR SLAB THICKNESS AND REINFORCEMENT ARE FOR ALL TYPES OF CONSTRUCTION.
- 3. PRECAST TOP AND/OR FLOOR SLABS MAY BE OF THE SAME CONCRETE AS SPECIFIED IN ASTM SPECIFICATIONS C-478 FOR PRECAST CIRCULAR
- 4. SMOOTH FLOW CHANNELS COMPOSED OF CONCRETE, OR BRICK AND MORTAR, SHALL BE CONSTRUCTED IN THE BOTTOMS OF ALL STRUCTURES TO A DEPTH EQUAL TO HALF THE DIAMETER OF THE LARGEST PIPE.
- 5. CORNER FILLETS SHOWN FOR RECTANGULAR STRUCTURES ARE NECESSARY ONLY WHEN STRUCTURES ARE USED IN CONJUNCTION WITH CIRCULAR TOPS.
- 6. STRUCTURES SHALL BE SECURED TO INLET THROATS, RISERS OR MANHOLE TOPS WITH A MINIMUM OF 6-No. 4 BARS 12" LONG.
- 7. ANY INLET, MANHOLE, OR JUNCTION BOX MAY BE USED IN CONJUNCTION WITH ANY INLET THROAT OR MANHOLE TOP.
- 8. MORTAR USED TO SEAL THE PIPE IN THE WALLS OF THE PRECAST UNITS SHALL BE OF SUCH A MIX THAT SHRINKAGE WILL NOT CAUSE LEAKAGE INTO OR OUT OF THE UNITS. MAXIMUM OPENING FOR PIPE SHALL BE MAXIMUM REQUIRED O.D. + 6".
- 9. THE OUTSIDE OF BRICK WALLS SHALL BE PLASTERED WITH 1:2 CEMENT

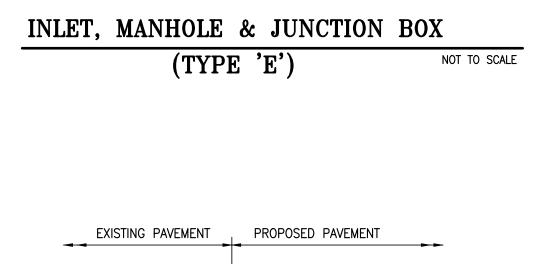

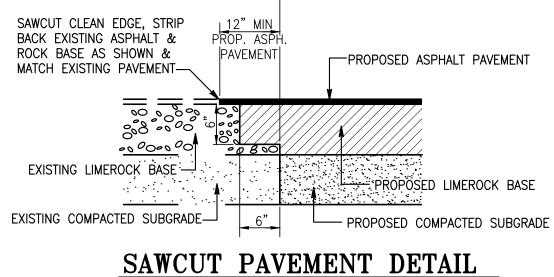

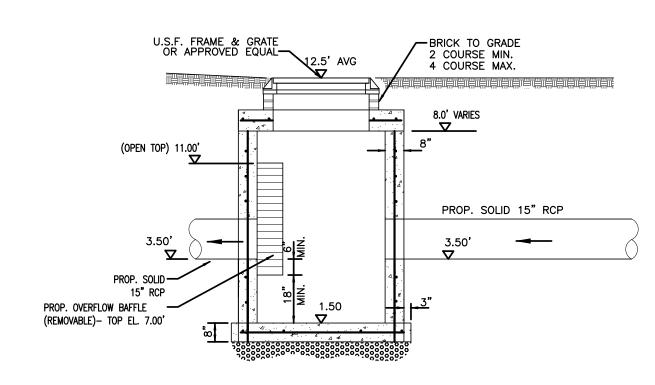



trench liner (note 6)

3/4" washed rock

3/4" washed rock

EXFILTRATION TRENCH DETAIL

1/2"x1/2".

COMPACTED

END VIEW OF TRENCH

COMPACTED

trench liner (note 6)

3/4" washed rock

0 0

0 0 0

4. COVER PIPE ENDS WITH NO. 10 GALVANIZED OR

5. BALLAST ROCK SHALL BE FROM FRESH WATER

WASHED FREE OF DELETERIOUS MATTER.

ALUMINUM SCREEN, OPENING NO LARGER THAN

6. SIDES AND TOP OF TRENCH TO BE LINED WITH ONE


EQUAL. OVERLAP TRENCH LINING MATERIAL A


MINIMUM OF TWO FEET AT TOP OF TRENCH.


LAYER OF PLASTIC TYPE FILTER CLOTH OR APPROVED

REFER TO C-2 (AVERAGE FGE=12.5)

EL. 10.5

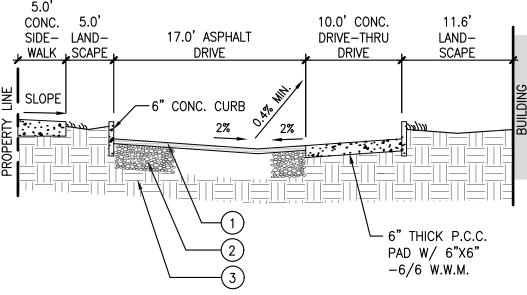


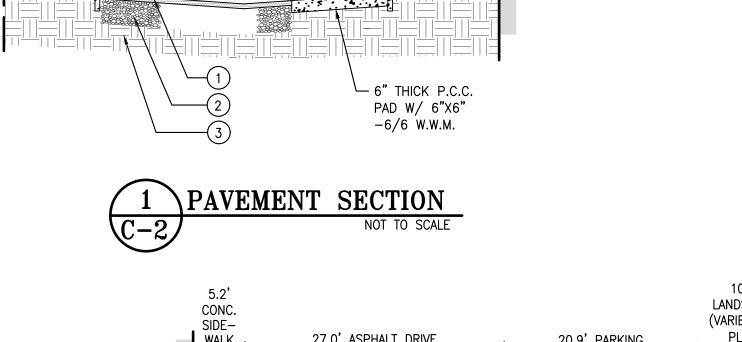


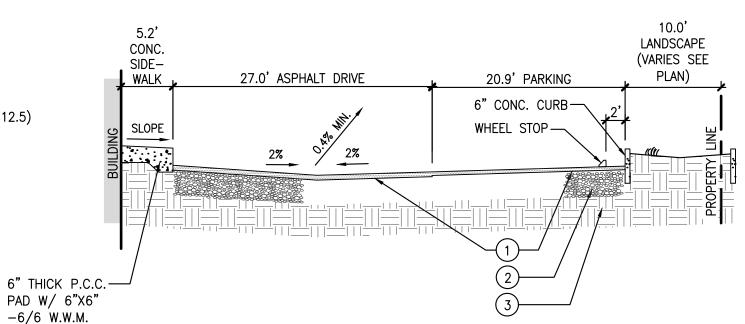

# PAVEMENT SECTION NOT TO SCALE

PAVEMENT SECTION

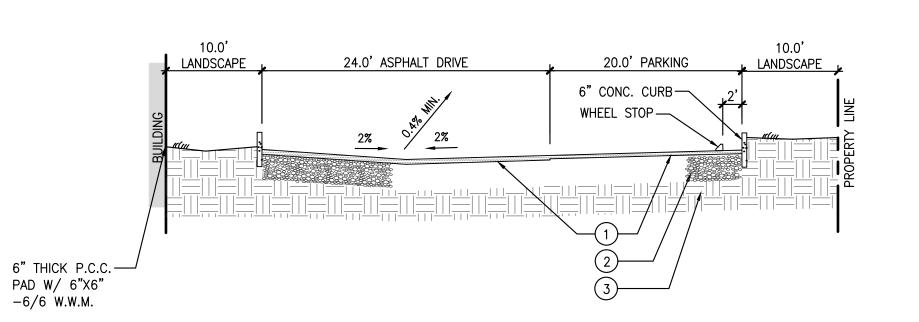

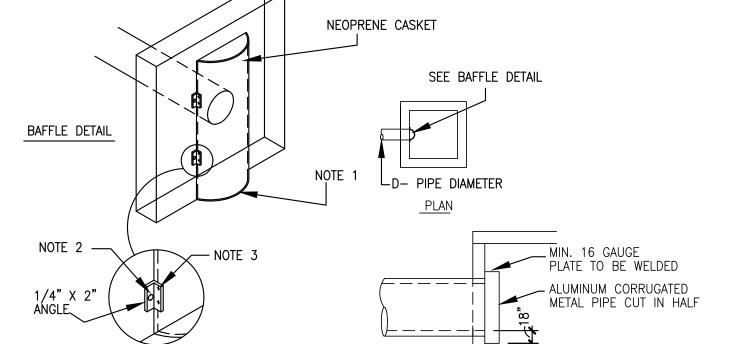

SECTION OF A.C.M.P. CUT IN HALF. BAFFLE DIAMETER TO BE AS PER TABLE 1
 1/2' GALVANIZED LAG BOLT IN LEAD SHIELD
 WELL OR 2-1/4" THRU BOLTS.

BRACKET DETAIL

TYPICAL CROSS SECTION

PRB BAFFLE

4 4 4 4

SPECIFICATIONS.

BASINS AS REQUIRED.

1. FOR CATCH BASIN SEE DETAIL (THIS SHEET)

2. DRAIN FIELD MAY BE OF SLOTTED CONCRETE PIPE

3. PIPES SHALL TERMINATE 2 FEET FROM END OF

TRENCH OR CONNECT TO ADDITIONAL CATCH

OR PERFORATED METAL PIPE MEETING CITY/COUNTY

AT EXFILT. SIDE

FILL

WELL OR 2-1/4 THRO BOLIS.
 MIN. SUMP IN P.R.B. INLET IS 2.5'
BELOW LOWEST INV. OF PIPE IN INLET.
 BOTTOM OF PRB TO BE MIN. 2'
BELOW CONTROL ELEVATION.


TABLE 1

D BAFFLE DIA.

12" 15"
15" 24"
18" 30"
24" 36"
30" 42"
36" 48"

POLLUTION RETARDANT BASIN
(BAFFLE TYPE)

NOT TO SCALE

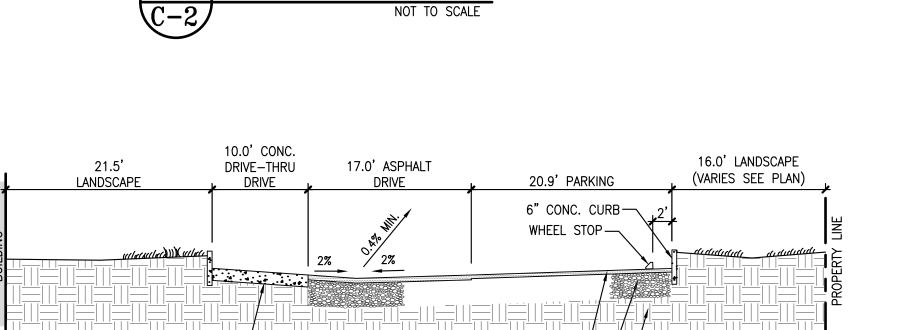



6" THICK P.C.C.

PAD W/ 6"X6"

-6/6 W.W.M.

#### LEGEND

- (1) 1 1/2" TYPE S-III ASPHALTIC CONCRETE AT PARKING 2" TYPE S-III ASPHALTIC CONCRETE AT DRIVES
- 2 6" LIMEROCK BASE AT PARKING 98% COMPACTION AS PER AASHTO T-180; MIN LBR=100; MIN CARBONATE CONTENT = 70%.

  8" LIMEROCK BASE AT DRIVES 98% COMPACTION AS PER AASHTO T-180; MIN LBR=100; MIN CARBONATE CONTENT = 70%.
- 3 12" SUBGRADE MIN LBR=40 98% COMPACTION, DRY DENSITY, AS PER AASHTO T-180

<u>NOTE:</u> REFER TO SOILS REPORT FOR DETAILED SPECS.

NOTES:

- 1. TRANSVERSE SLOPES FOR PAVEMENT SHALL BE 2% MIN. FOR ROADWAYS & 1% FOR PARKING.
- 2. LONGITUDINAL SLOPE OF PAVEMENT SHALL BE 0.4%



SITE NUMBER:

BASE MODEL:

ASSET TYPE:

CLASSIFICATION:

BASE VERSION:

PROJECT YEAR:

FURNITURE PACKAGE:

DRAWING RELEASE

OWNER: JAE REST. GROUP, LLC

GROUP

**INCORPORATED** 

15500 NEW BARN ROAD

MIAMI LAKES , FLORIDA 33014

PHONE: (305) 558-4124 FAX: (305) 826-0619

PROJECT TYPE: USB NRE 55

NEW

**UPGRADE CLASSIFICATION:** 

11670

FRAN

NEW

2017

2016 R3

2016 R3

USB NRE 55 R3

XXXXXXXX

CORP. NEW BUILD

REV. DATE DESCRIPTION

1 05-01-18

ISSUE DATE: 02/10/2016

PROJECT NUMBER: 1493

DRAWN BY: R. C.

CHECKED BY: E. C.

SEAL


EDUARDO L. CARCACHE, PE 31914 ANA A. GONZALEZ VALDES, AR 97769 LUIS VARGAS, LEED AP #701023753163800 CKE GROUP, INC. COA-4432


SITE DETAILS

SHEET NAME

SHEET NUMBER

**C-2** 

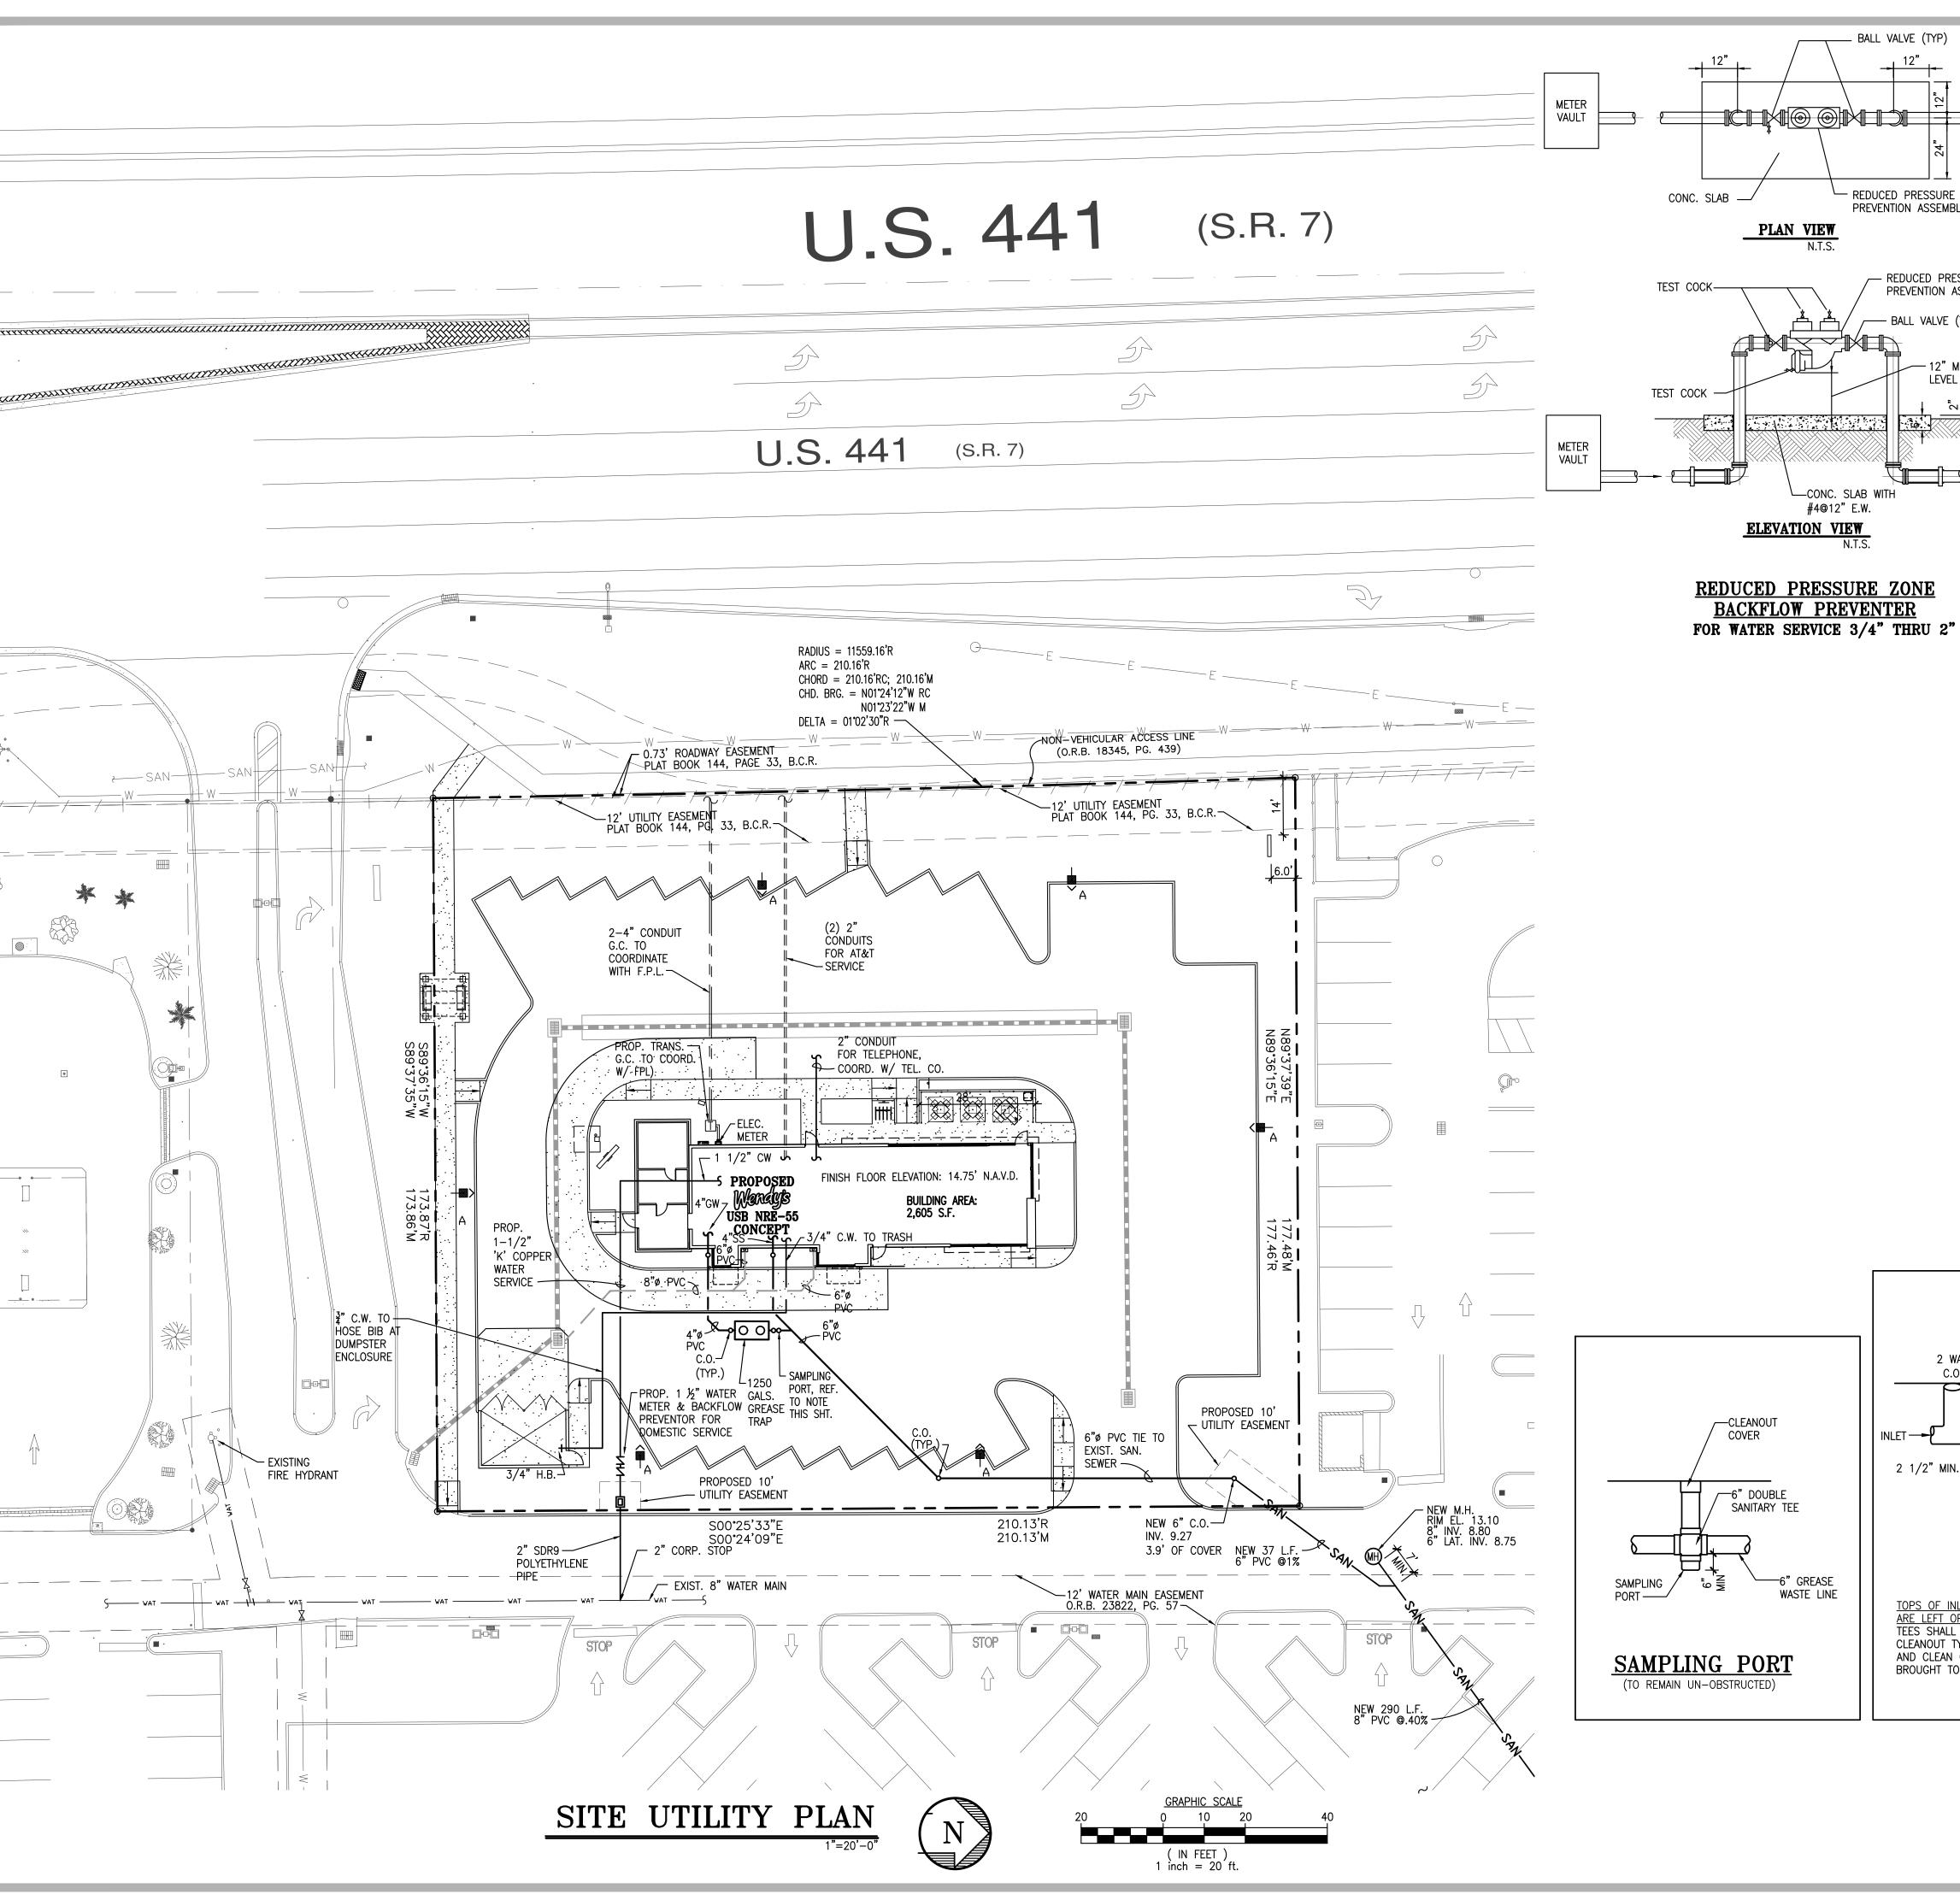

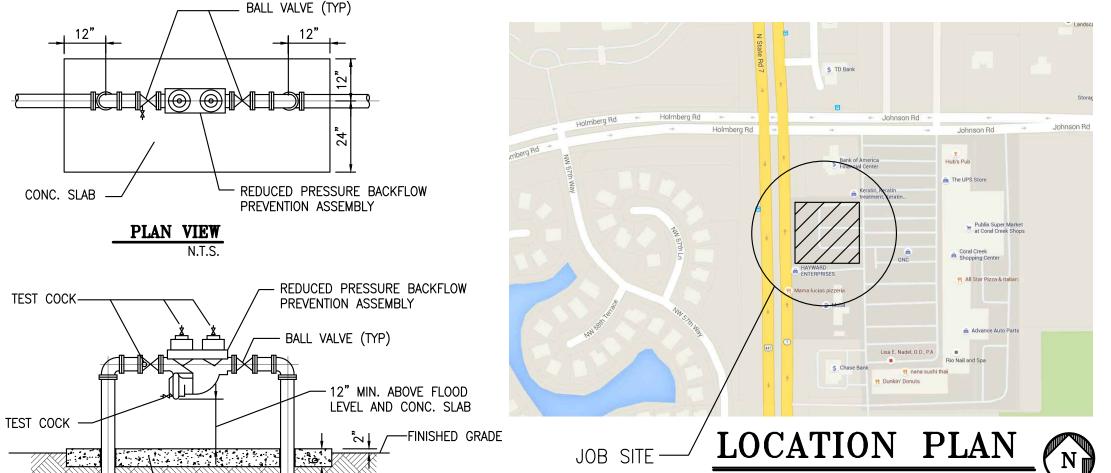

#### LEGAL DESCRIPTION


A PORTION OF TRACT "A", SAWGRASS PARK OF COMMERCE COMMERCIAL SECTION "B", ACCORDING TO THE PLAT THEREOF, AS RECORDED IN PLAT BOOK 144, PAGE 33, OF THE PUBLIC RECORDS OF BROWARD COUNTY, FLORIDA, BEING MORE PARTICULARLY DESCRIBED AS FOLLOWS.

COMMENCING AT THE WESTERLY NORTHWEST CORNER OF SAID TRACT "A". SAID POINT BEING ON THE EASTERLY RIGHT-OF-WAY LINE OF U.S. HIGHWAY NO. 441 (STATE ROAD NO. 7) AS SHOWN ON SAID PLAT AND ON THE ARC OF A CURVE CONCAVE WESTERLY, TO WHICH A RADIAL LINE BEARS NORTH 8712'47" EAST; THENCE SOUTHERLY ON SAID EASTERLY RIGHT-OF-WAY LINE, ON THE WESTERLY LINE OF SAID TRACT "A" AND ON THE ARC OF A CURVE TO THE RIGHT, HAVING A RADIUS OF 11,559.16 FEET, A CENTRAL ANGLE OF 0'51'46", FOR AN ARC DISTANCE OF 174.06 FEET TO THE POINT OF BEGINNING; THENCE NORTH 89°36'15" EAST ON A NON-RADIAL LINE 177.46 FEET; THENCE SOUTH 00°25'33" EAST 210.13 FEET; THENCE SOUTH 89°36'15" WEST ON A LINE NON-RADIAL TO THE FOLLOWING DESCRIBED CURVE 173.87 FEET TO THE INTERSECTION WITH THE AFOREMENTIONED EASTERLY RIGHT-OF-WAY LINE OF U.S. HIGHWAY NO. 441 (STATE ROAD NO. 7), SAID WESTERLY LINE OF TRACT "A" AND A POINT ON SAID CURVE CONCAVE WESTERLY, TO WHICH A RADIAL LINE BEARS NORTH 89°07'03" EAST; THENCE NORTHERLY ON THE ARC OF SAID CURVE TO THE LEFT, HAVING A RADIUS OF 11,559.16 FEET, A CENTRAL ANGLE OF 1°02'30", FOR AN ARC DISTANCE OF 210.16 FEET TO THE POINT OF BEGINNING.

SAID LANDS SITUATE, LYING AND BEING IN THE CITY OF COCONUT CREEK, BROWARD COUNTY, FLORIDA, CONTAINING 36,846 SQUARE FEET (0.8459 ACRES), MORE OR LESS.

#### NOTES:


- 1. ALL HYDRANTS TO FALL WITHIN 2 FEET OF CURB, STEAMER CONNECTION TO FACE ROADWAY.
- 2. LANDSCAPING SHALL NOT OBSCURE FIRE HYDRANT NOR SPRINKLER / STANDPIPE WYES.
- 3. BUILDING ADDRESS SHALL BE CLEARLY VISIBLE FROM ROADWAY.
- 4. ALL CLEAN-OUTS IN DRIVEWAYS TO HAVE TRAFFIC BEARING CAPS (USG #7630 VALVE BOX).
- 5. ON-SITE SANITARY SEWER TO BE PRIVATELY MAINTAINED.
- 6. CONTRACTOR TO VERIFY INVERTS AND EXACT LOCATION OF UTILITIES PRIOR TO COMMENCING WITH WORK.
- 7. MINIMUM SLOPE OF SANITARY WASTE = 1%.
- 8. CONTRACTOR TO PROVIDE CLEANOUTS AT EACH CHANGE OF DIRECTION OF SEWER LINE AND AT INTERVALS NOT TO EXCEED 70FT.
- 9. NO SOLVENT WELD SHALL BE USED.
- 10. REFER TO CITY OF COCONUT CREEK PUBLIC WORKS STANDARD DETAILS FOR ADDITIONAL DETAILS.
- 1. REFER TO SHEET PH-1 FOR SITE LIGHTING AND SITE ELECTRICAL.

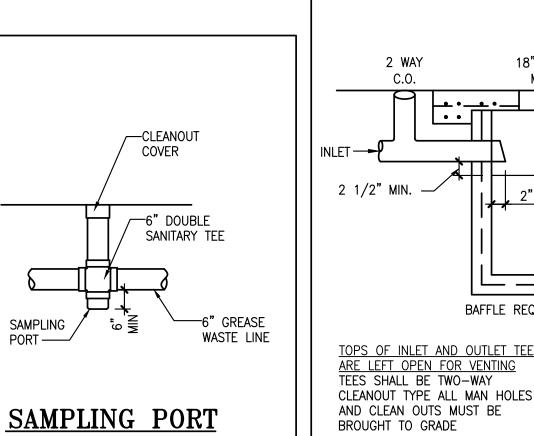

└─CONC. SLAB WITH


#4@12" E.W.

**ELEVATION VIEW** 

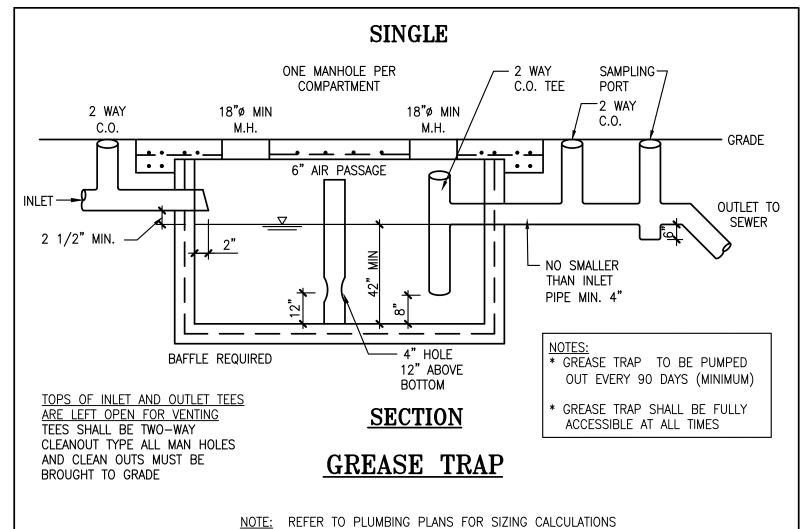

SITE NUMBER: 11670 BASE MODEL: USB NRE 55 R3 ASSET TYPE: FRAN CLASSIFICATION: NEW OWNER: JAE REST. GROUP, LLC BASE VERSION: XXXXXXXX UPGRADE CLASSIFICATION:

CORP. NEW BUILD PROJECT YEAR: 2017 FURNITURE PACKAGE: 2016 R3 DRAWING RELEASE 2016 R3

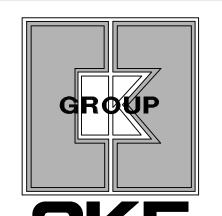

**INCORPORATED** 15500 NEW BARN ROAD

SUITE 106 MIAMI LAKES , FLORIDA 33014 PHONE: (305) 558-4124 FAX: (305) 826-0619


NEW

PROJECT TYPE: USB NRE 55

05-01-18 2 07-18-18 ISSUE DATE: PROJECT NUMBER: CHECKED BY:

EDUARDO L. CARCACHE, PE 31914 ANA A. GONZALEZ VALDES, AR 97769 LUIS VARGAS, LEED AP #701023753163800 CKE GROUP, INC. COA-4432

SITE UTILITY PLAN

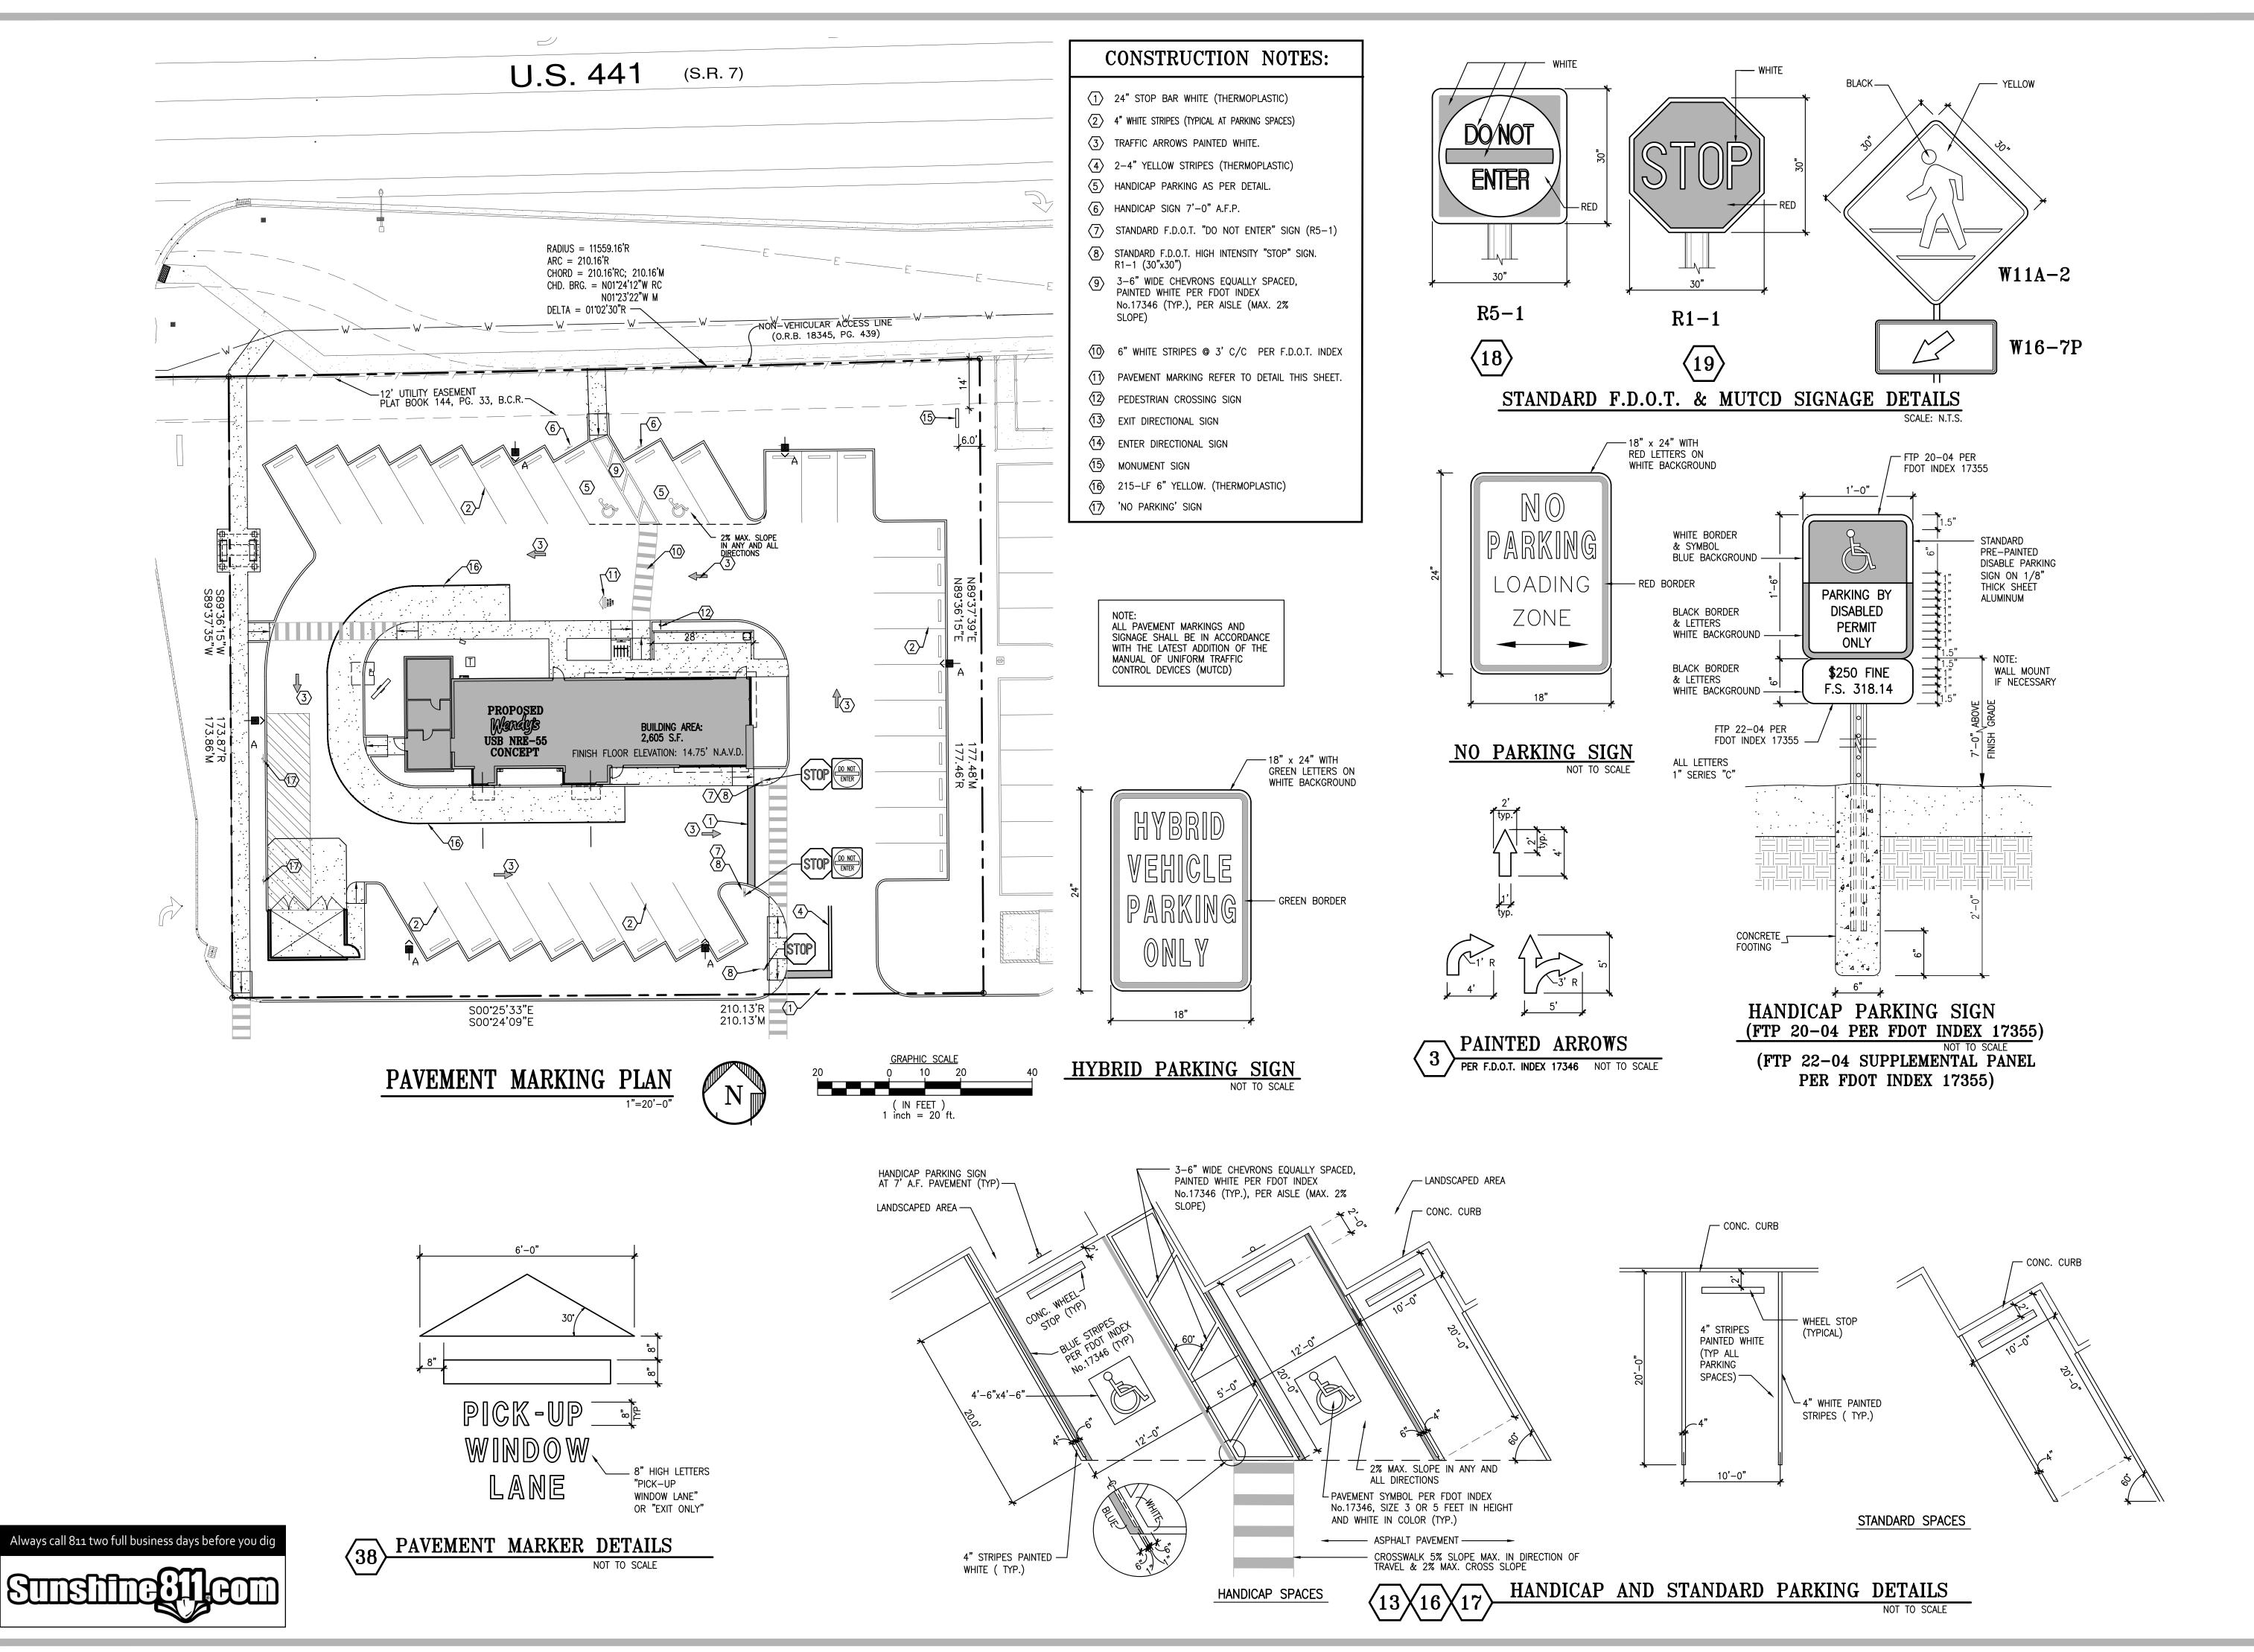

SITE NUMBER: 11670

BASE MODEL: USB NRE 55 R3

ASSET TYPE: FRAN

CLASSIFICATION: NEW

OWNER: JAE REST. GROUP, LLC

BASE VERSION: XXXXXXXXX


UPGRADE CLASSIFICATION:

CORP. NEW BUILD

PROJECT YEAR: 2017

FURNITURE PACKAGE: 2016 R3

DRAWING RELEASE 2016 R3

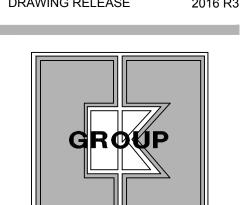

CKE
GROUP
INCORPORATED
engineering • architecture • planning
15500 NEW BARN ROAD

SUITE 106

MIAMI LAKES , FLORIDA 33014

PHONE: (305) 558-4124

FAX: (305) 826-0619

NEW

PROJECT TYPE: USB NRE 55

# 11670

REV. DATE DESCRIPTION

1 05-01-18
2 07-18-18

DISSUE DATE: 02/10/201
PROJECT NUMBER: 149
DRAWN BY: R. C
CHECKED BY: E. C


SEAL


EDUARDO L. CARCACHE, PE 31914 ANA A. GONZALEZ VALDES, AR 97769 LUIS VARGAS, LEED AP #701023753163800 CKE GROUP, INC. COA-4432

SHEET NAME

PAVEMENT MARKINGS PLAN

**C-4** 

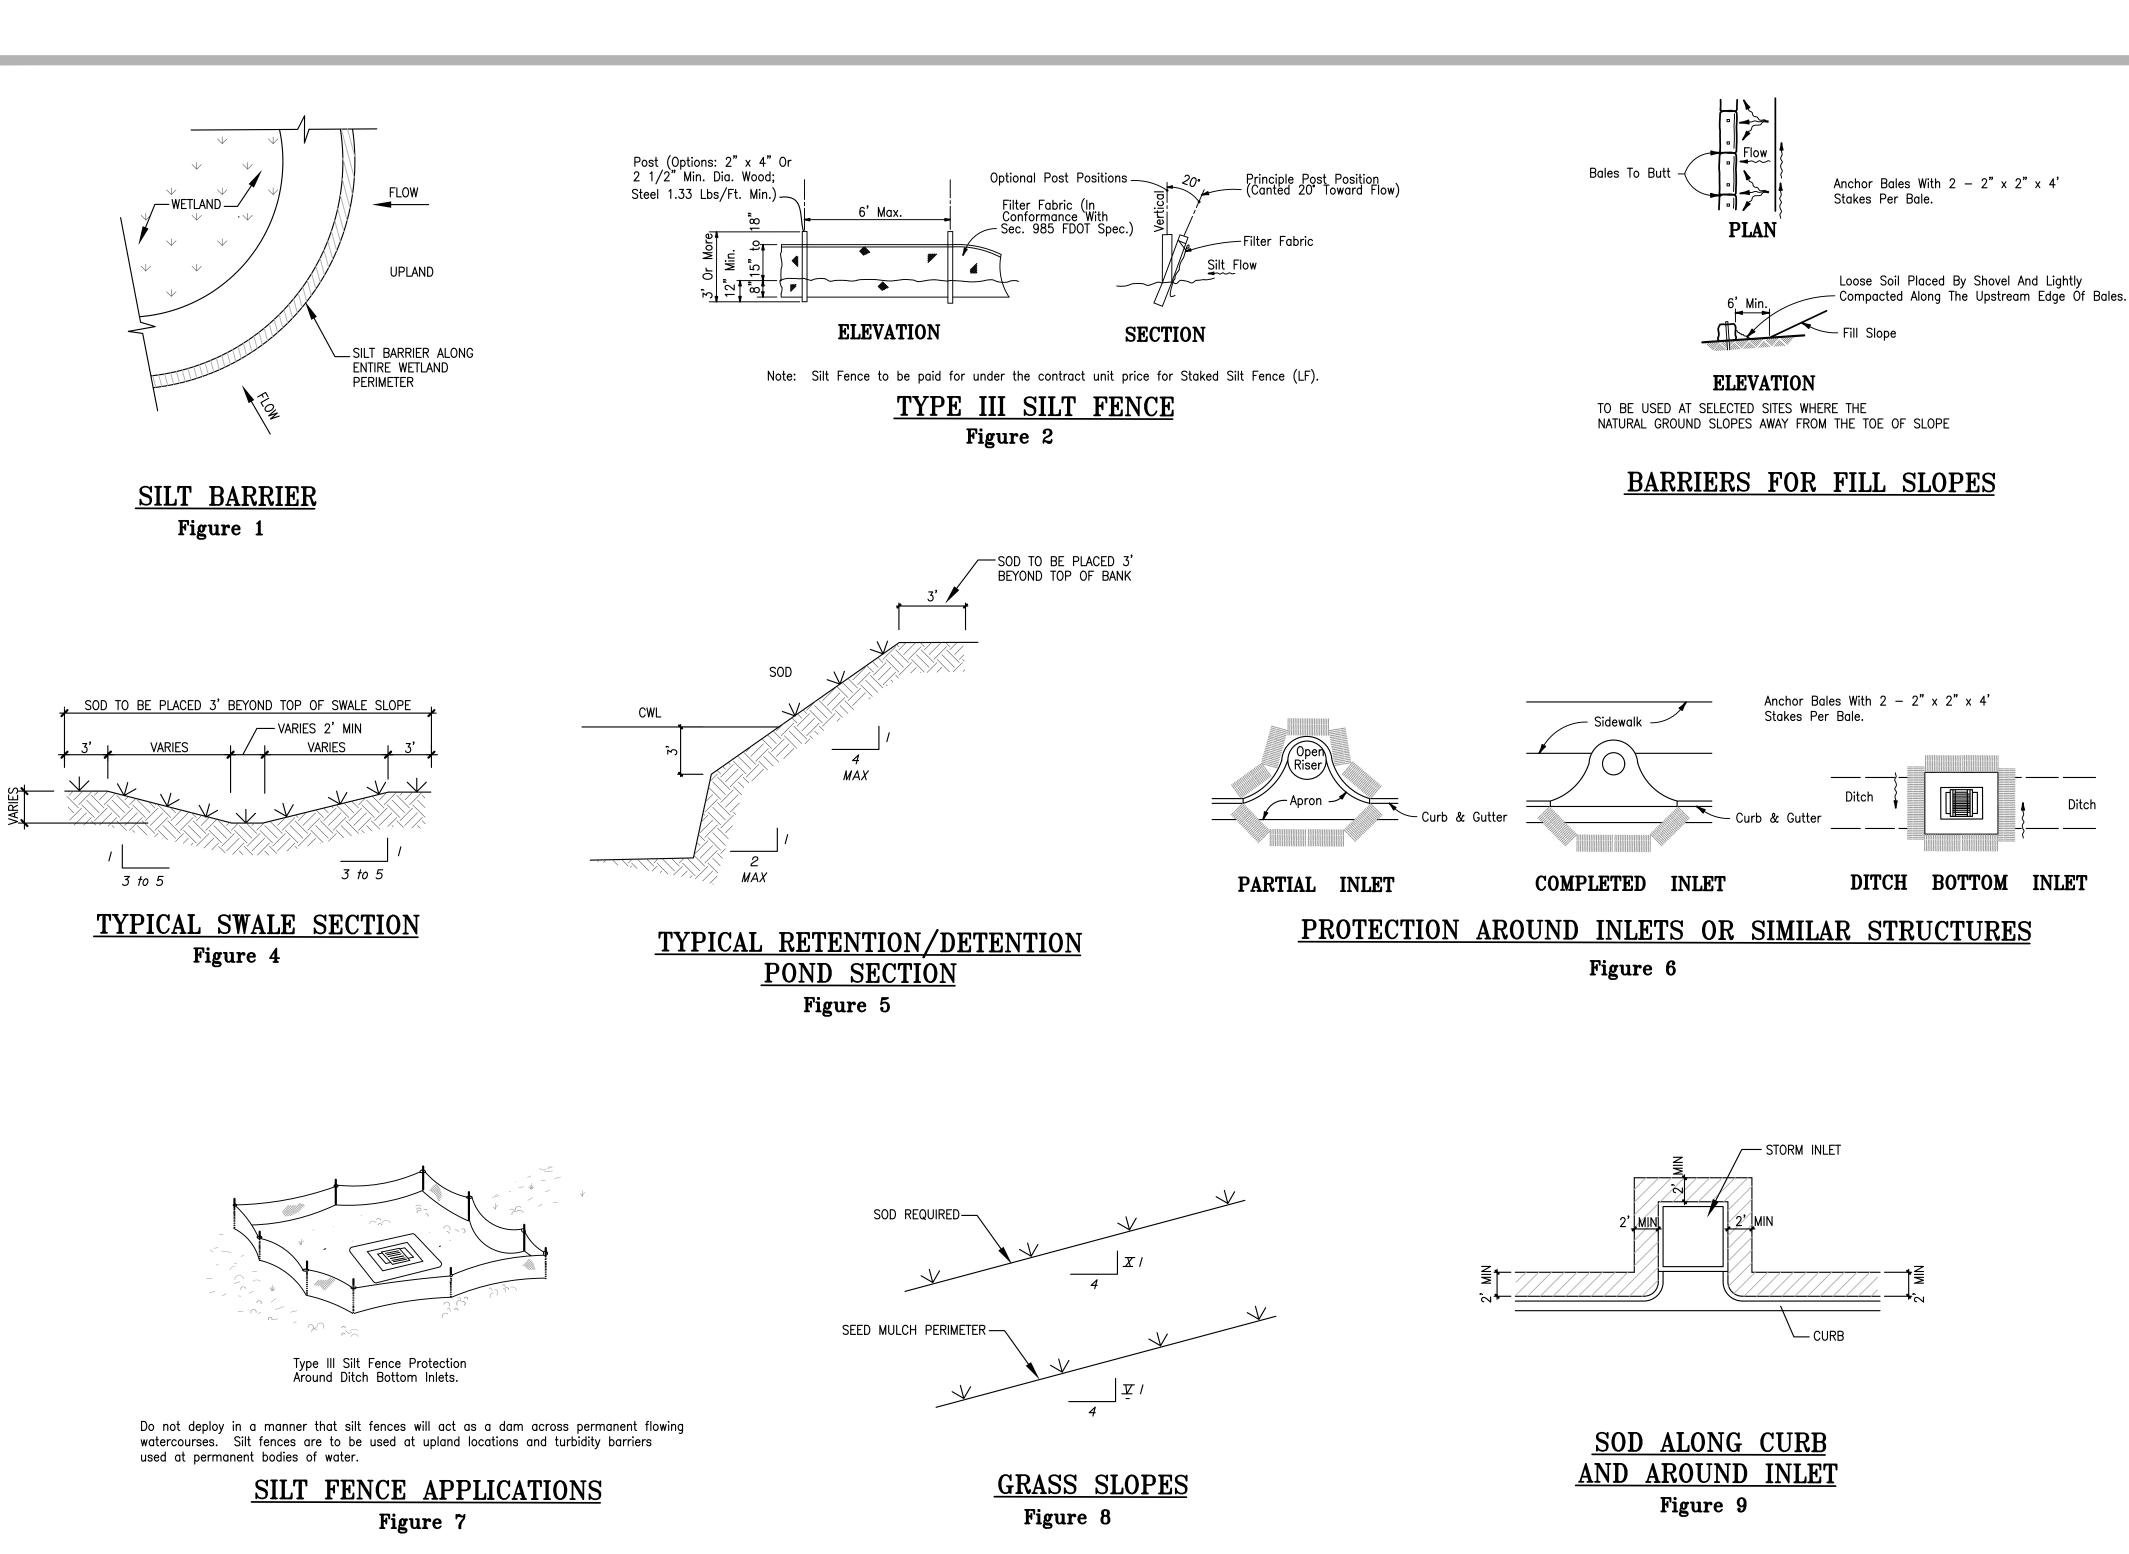

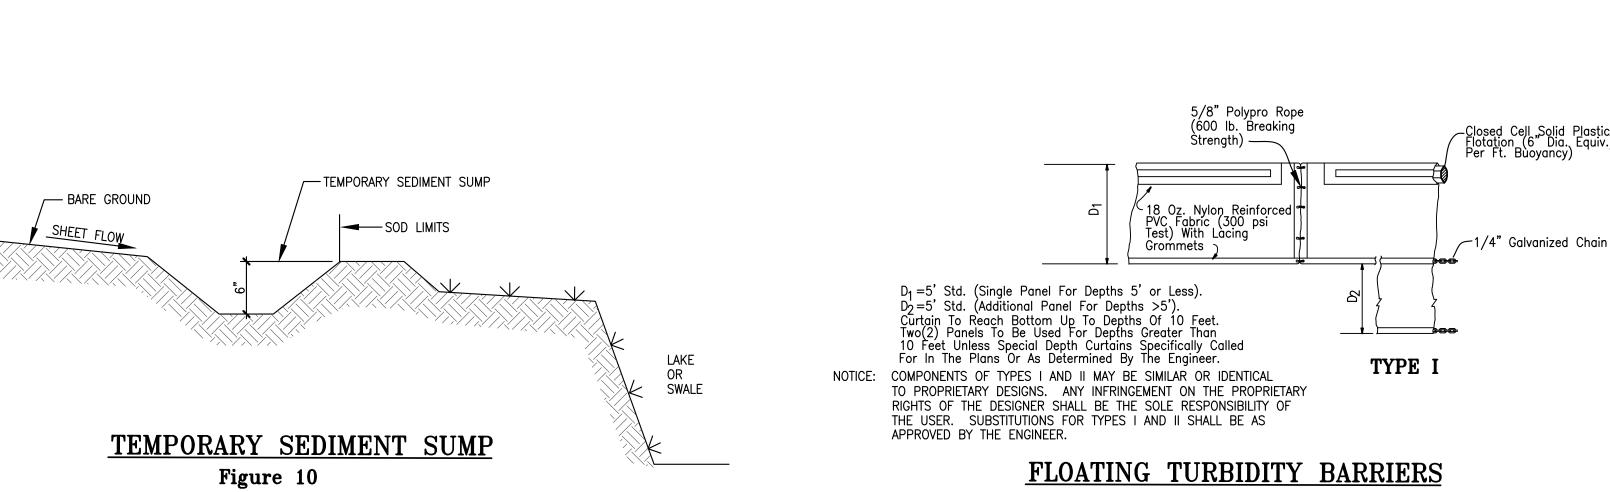

STORMWATER POLLUTION PREVENTION DETAILS

Best Management Practices

This plan has been prepared to ensure compliance with appropriate conditions of the Miami-Dade County Land Development Regulations, the Rules of the Florida Department of Environmental Protection, Chapter 17-25, F.A.C.. The plan addresses the following areas:

1. Protection of preserved/conserved wetland habitats during construction.

2. Protection of preserved/conserved upland habitats during construction.

3. General erosion control.

4. Protection of surface water quality during and after construction.

5. Control of wind erosion.

The various techniques or actions identified under each section indicate the appropriate situation when the techniques should be employed. Also identified is a cross-reference to a diagram or figure representing

It should be noted that the measures identified on this plan are only suggested BMP(s). The contractor shall provide pollution prevention and erosion control measures as specified in FDOT Index #100 and as necessary for each specific application.

SECTION 1 PROTECTION OF PRESERVED/CONSERVED WETLAND HABITATS DURING CONSTRUCTION

1.1 Wetland habitat protection BMPs shall be utilized for any development parcel which contains or abuts a preserved wetland and/or for any parcel which contains or abuts a mitigated wetland.

1.2 Preserved wetlands shall be protected prior to the start of site—work construction. Protection shall consist of a slip barrier constructed along the entire perimeter of the preserved wetland as shown in Figure 1. The slit barrier shall be constructed along the outer edge of the required 30 foot buffer adjoining preserved wetlands. The slit barrier may be either a slit fence as shown in Figure 2 or hay bales as shown in Figure 3.

1.3 Mitigated wetlands shall be protected as soon as practical after their construction. Protection shall be the same as for preserved wetlands.

1.4 Slit barriers used for wetland protection shall remain in place for the duration of any site—work or building construction located in the vicinity of the wetland. Slit barriers erected during development shall be designed and maintained to not impound intermittent standing water for more than 72 hours. Slit barriers, any slit which accumulates behind these barriers and any fill used to anchor the barriers shall be removed promptly after the end of the maintenance period specified for the barriers.

SECTION 2 PROTECTION OF PRESERVED/CONSERVED UPLAND HABITATS

2.1 Barricades shall be placed around all protected (preserved) habitats including mesic and uplands

2.2 Slit barriers required for the protection of preserved habitats other than wetlands shall be constructed along the perimeter of the preserved area in accordance with implementation guidelines contained in

SECTION 3 GENERAL EROSION CONTROL

3.1 General erosion control BMPs shall be employed to minimize soil erosion and potential lake slop cave—ins. While the various techniques required will be site and plan specific, they should be employed as soon as possible during construction activities.

3.2 Cleared site development areas not continually scheduled for construction activities shall be covered with hay or over-seeded and periodically watered sufficient to stabilize the temporary groundcover.

3.3 Slopes of banks of retention/detention ponds shall be constructed not steeper than 4H:1V from top of bank to two feet below normal water level as shown in Figure 5.

3.4 All gross slopes constructed steeper than 4H:1V shall be sodded as soon as practical after their construction as shown in Figure 8.

3.5 Sod shall be placed for a 3—foot wide strip adjoining all curbing and around all inlets as shown in Figure 9. Sod shall be placed before slit barriers, shown in Figure 6, are removed.

3.6 Where required to prevent erosion from sheet flow across bare ground from entering a lake or swale, a temporary sediment sump shall be constructed, as shown in Figure 10. The temporary sediment sump shall remain in place until vegetation is established on the ground draining to the sump.

SECTION 4 PROTECTION OF SURFACE WATER QUALITY DURING AND AFTER CONSTRUCTION

4.1 Surface water quality shall be maintained by employing the following BMPs in the construction planning and construction of all improvements.

4.2 Where practical stormwater shall be covered by swales. Swales shall be constructed as shown in

4.3 Erosion control measures shall be employed to minimize turbidity of surface waters located downstream of any construction activity. While the various measures required will be site specific, they shall be employed as needed in accordance with the following:

a. In general erosion shall be controlled at the furthest practical upstream location.

b. Stormwater inlets shall be protected during construction as shown in Figures 6 and 7. Protection measures shall be employed as soon as practical during the various stages of inlet construction. Slit barriers shall remain in place until sodding around inlets is complete.

4.4 Heavy construction equipment parking and maintenance areas shall be designed to prevent oil, grease, and lubricants from entering site drainage features including stormwater collection and treatment systems. Contractors shall provide broad dikes, hay bales or slit screens around, and sediment sumps within, such areas as required to contain spills of oil, grease or lubricants. Contractors shall have available, and shall use, absorbent filter pads to clean up spills as soon as possible after occurrence.

4.5 Slit barriers, any slit which accumulates behind the barriers, and any fill used to anchor the barriers shall be removed promptly after the end of the maintenance period specified for the barriers.

SECTION 5 CONTROL OF WIND EROSION

5.1 Wind erosion shall be controlled by employing the following methods as necessary and appropriate:

a. Bore earth areas shall be watered during construction as necessary to minimize the transport of fugitive dust. It may be necessary to limit construction vehicle speed if bare earth has not been effectively watered. In no case shall fugitive dust be allowed to leave the site under construction.

b. As soon a practical after completion of construction, bare earth areas shall be vegetated

c. At any time both during and after site construction that watering and/or vegetation are not effective in controlling wind erosion and/or transport of fugitive dust, other methods as are necessary for such control shall be employed. These methods may include erection of dust control fences. If required, dust control fences shall be constructed in accordance with the detail for a slit fence shown in Figure 2 except the minimum height shall be 4 feet.

NOTES

1. THE CONTRACTOR SHALL PROVIDE POLLUTION PREVENTION AND EROSION CONTROL MEASURES AS SPECIFIED IN FDOT INDEX #100 AND AS NECESSARY FOR EACH SPECIFIC APPLICATION

SITE NUMBER: 11670 BASE MODEL: USB NRE 55 R3 ASSET TYPE: FRAN CLASSIFICATION NEW OWNER: JAE REST. GROUP, LLC BASE VERSION: XXXXXXXX

**UPGRADE CLASSIFICATION:** 

CORP. NEW BUILD PROJECT YEAR: 2017 FURNITURE PACKAGE 2016 R3 DRAWING RELEASE 2016 R3



INCORPORATED 15500 NEW BARN ROAD SUITE 106 MIAMI LAKES , FLORIDA 33014

USB NRE 55

NEW

PHONE: (305) 558-4124 FAX: (305) 826-0619


PROJECT TYPE:

REV. DATE DESCRIPTION

PROJECT NUMBER: DRAWN BY: R. C. CHECKED BY: E. C.

EDUARDO L. CARCACHE, PE 31914 ANA A. GONZALEZ VALDES, AR 97769 LUIS VARGAS, LEED AP #701023753163800 CKE GROUP, INC. COA-4432

SHEET NAME POLLUTION PREVENTION

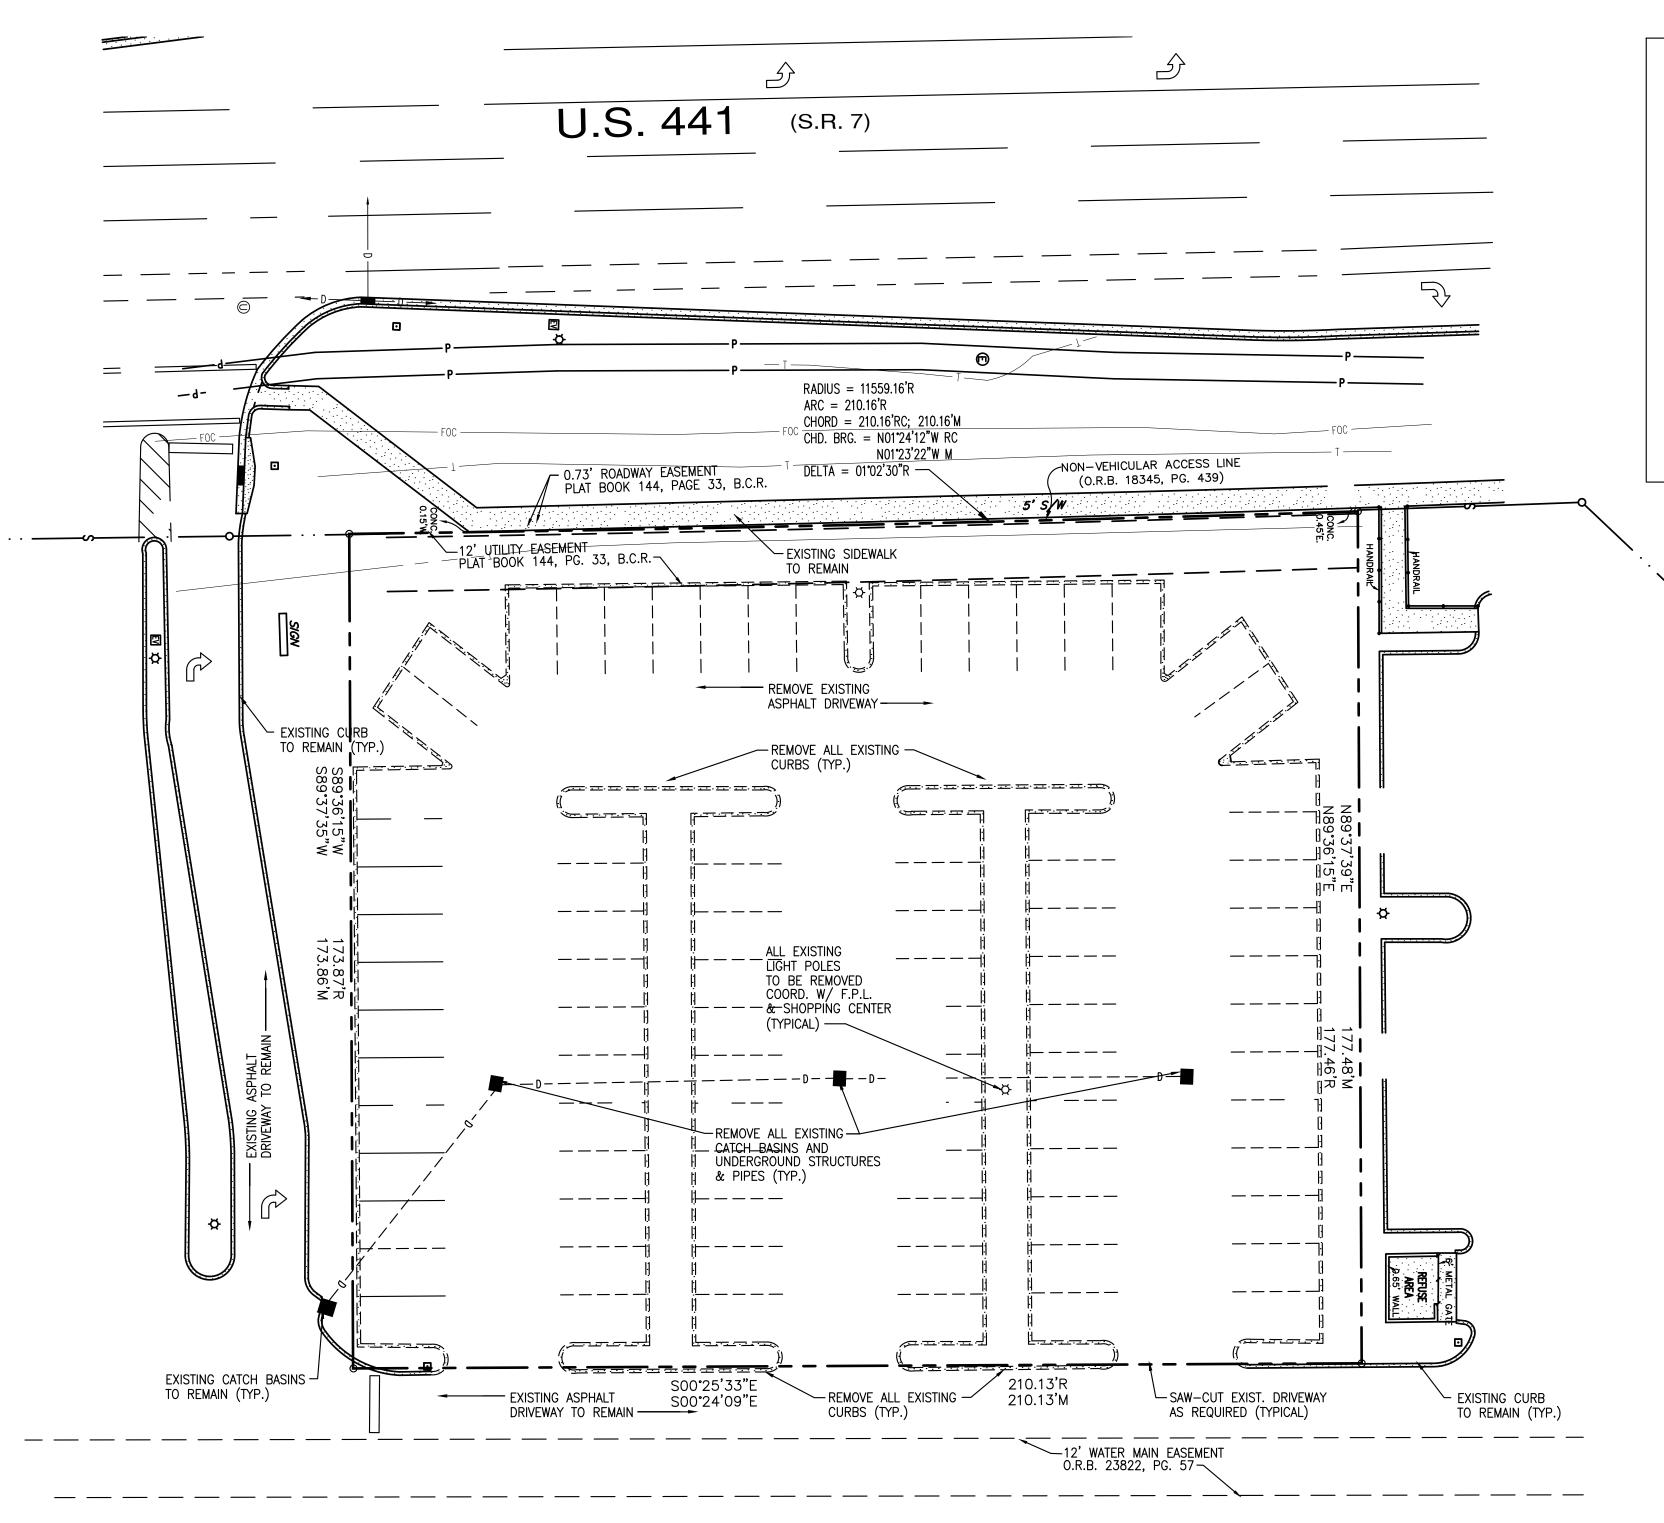

**DEMOLITION NOTES** 

1. FOR TREES AND/OR LANDSCAPE REMOVAL AND/OR RELOCATION, REFER TO LANDSCAPE DRAWINGS.

2. ALL EXISTING PAVEMENT MARKINGS AND SIGNS WITHIN PROPERTY LINES TO BE REMOVED.

3. EXISTING ASPHALT PAVEMENT AND BASE WITHIN PROPERTY LINES TO BE REMOVED (DEPTH OF BASE REMOVAL BASED ON PROPOSED GRADES) 4. EXIST. CURBS, CONC. WALKS, HAND RAILS, BOLLARDS,

LIGHTS, PLANTERS, METERS, ELECT. PANELS, OVERHANGS, PERTAINING TO AND AROUND BUILDING TO BE REMOVED

5. --- DENOTES TO BE REMOVED


6. — DENOTES TO REMAIN

- 1. SEE SURVEY FOR DESCRIPTION OF EXISTING FEATURES WITHIN SITE.
- OF EXISTING ON SITE FACILITIES ABOVE AND UNDERGROUND. THE CONTRACTOR IS RESPONSIBLE FOR THE REMOVAL FROM THE SITE OF ALL DEMOLISHED MATERIALS, THE FILLING OF ALL DEPRESSIONS CAUSED BY DEMOLITION, AND THE GRADING OF THESE AREAS SO AS NOT TO BE OBJECTIONABLE TO VIEW. THE CONTRACTOR SHALL OBSERVE ALL RE-QUIRED SAFETY PRECAUTIONS IN THE PERFORMANCE OF HIS WORK.
- . REMOVE ALL VEGETATION, ROLL AND COMPACT AREAS BEFORE REPLACING FILL. FILL SHALL BE PLACED IN 12" LAYERS LOOSE MEASURE AND COMPACTED TO 90% OF MAXIMUM DENSITY AS DETERMINED BY AASHTO-T180-78. FILL SHALL BE LOCALLY ACCEPTABLE AND SUITABLE FOR FILL PURPOSES. THE TOP 12" OF FILL OR CUT UNDER PAVEMENT BASE SHALL BE COMPACTED TO 95% OF MAXIMUM DENSITY AS DETERMINED BY AASHTO-T180-78. REFER TO SOILS REPORT FOR ADDITIONAL INFORMATION
- 4. THE CONTRACTOR SHALL BE REQUIRED TO STABILIZE SLOPED AREAS. THE CONTRACTOR SHALL GRADE AND SEED OR SOD THE AREA WITH THE PRO-VISION THAT HE SHALL MAINTAIN THE SEEDED OR SODDED AREA AS REQUIRED UNTIL SUCH TIME THAT THERE IS SUITABLE GROWTH TO ADEQUATELY PROTECT THE EMBANKMENT. THE MAXIMUM ALLOWABLE SLOPE SHALL BE 2: 1. CONTRACTOR SHALL MATCH EXISTING GRADES AND ALL PROPERTY LINES AROUND SITE, UNLESS OTHERWISE SHOWN ON GRADING PLAN. FINISHED GRADING AND LANDSCAPING BY LANDSCAPE CONTRACTOR. GENERAL CONTRACTOR IS TO GRADE ALL LANDSCAPED AREAS TO WITHIN 4" ( .33' ) OF FINISHED GRADES. ALL GRADES SHOWN ON GRADING PLAN ARE FINISHED GRADES.
- . DIMENSIONS, BUILDING LOCATION AND GRADING OF THIS SITE ARE BASED ON AVAILABLE INFORMATION AT TIME OF LAYOUT. DEVIATIONS MAY BE NECESSARY IN THE FIELD. ANY SUCH CHANGES OR CONFLICTS BETWEEN THIS PLAN AND FIELD CONDITIONS ARE TO BE REPORTED TO THE ENGINEER PRIOR TO STARTING CONSTRUCTION.
- BUILDING CODES.
- INSTALL WATER SERVICES AS REQUIRED. LINES TO BE INS-TALLED SHOULD BE EXTENDED FROM THE CLOSEST WATER MAIN
- ARE APPROXIMATE OR SCHEMATIC. LOCATION OF EXISTING UTILITIES MUST BE VERIFIED IN THE FIELD PRIOR TO ANY CONSTRUCTION.
- 9. GENERAL CONTRACTOR IS TO INCLUDE IN BID ALL UTILITY COSTS NECESSARY TO PROVIDE COMPLETE ELECTRICAL SERVICE, SEWER TIE-IN, TAP FEES, CONNECTION COSTS, AND WATER SERVICE AS REQUIRED BY LOCAL CODES AND UTILITY COMPANIES.
- 11. CONCRETE SIDEWALKS TO BE 3,000 P.S.I. CONCRETE, 4" THICK, WITH 6x6 - W1.4 x W1.4 WELDED WIRE MESH REINFORCED UNLESS OTHERWISE NOTED.
- 12. ALL CONCRETE CURB TO BE CONSTRUCTED OF 3,000 P.S.I. CONCRETE.
- 13. THE CONCRETE TRASH ENCLOSURE APRON SHALL BE 6" THICK OF 3,000 P.S.I. CONCRETE REINFORCED WITH #4 BARS @ 16" O.C. EACH WAY.
- STANDARD SPECIFICATIONS OF THE CITY, COUNTY, OR STATE HIGHWAY DEPARTMENT, WHICHEVER APPLIES.
- 15. ALL WORK TO BE PERFORMED THAT IS NOT COVERED BY THESE PLANS SHALL BE CONSTRUCTED IN ACCORDANCE WITH APPLICABLE STATE, COUNTY, OR LOCAL CODES. ALL WORK IN PUBLIC RIGHT OF WAYS SHALL BE IN ACCORDANCE WITH ALL STATE AND LOCAL REQUIREMENTS AND STANDARDS.
- WITH THE BID SET, IT IS THE BIDDER'S RESPONSIBILITY TO

Know what's **below**. **Call** before you dig.

**DEMOLITION PLAN** 



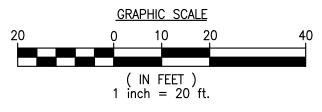

GENERAL NOTES

2. THE CONTRACTOR SHALL BE FULLY RESPONSIBLE FOR THE DEMOLITION

- 6. ALL CONSTRUCTION OF UTILITIES TO BE IN ACCORDANCE WITH LOCAL
- 7. IT IS THE CONTRACTOR'S FULL RESPONSIBILITY TO FURNISH AND CAP PLUGGED AT BUILDING. SEE C-3 FOR REQUIRED WATER SERVICE
- 8. LOCATION OF UNDERGROUND UTILITIES, EXISTING OR PROPOSED,
- 10. THE CONTRACTOR SHALL BE REQUIRED TO EXTEND AND CONNECT SANITARY SEWER TO THE EXISTING SEWER SYSTEM. IF SEWER IS NOT ADJACENT TO SITE. THE CONTRACTOR SHALL BE REQUIRED TO EXTEND THE SANITARY SEWER SERVICE TO THIS SITE IN ACCORDANCE WITH THE PLANS. SANITARY SEWER LINE TO BE CONNECTED AT A MINI-MUM 2% SLOPE USING A MINIMUM PIPE, MATCHING EXISTING PIPE MATERIAL, UNLESS OTHERWISE SPECIFIED.


- 14. COMMERCIAL DRIVEWAYS TO BE CONSTRUCTED IN ACCORDANCE WITH THE
- 16. THE CONTRACTOR IS ADVISED THAT THE SOILS REPORT IS A PART OF THE BIDDING DOCUMENTS. IF THE SOILS REPORT IS NOT RECEIVED OBTAIN AND REVIEW THE SOILS REPORT PRIOR TO SUBMITTING FINAL

CLASSIFICATION: NEW OWNER: JAE REST. GROUP, LLC BASE VERSION: XXXXXXXX UPGRADE CLASSIFICATION: CORP. NEW BUILD PROJECT YEAR: 2017 FURNITURE PACKAGE: 2016 R3

SITE NUMBER:

BASE MODEL:

ASSET TYPE:

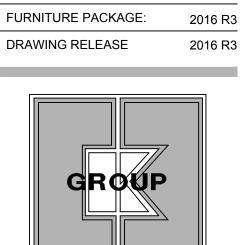

11670

USB NRE 55 R3

INCORPORATED 15500 NEW BARN ROAD

PHONE: (305) 558-4124 FAX: (305) 826-0619

PROJECT TYPE: USB NRE 55

NEW

Store # 11670 US 441 & JOHNSON RC Coconut Creek, Florida

REV. DATE DESCRIPTION ISSUE DATE: 02/10/2016 PROJECT NUMBER:

DRAWN BY:

CHECKED BY:


SEAL


R. C.

E. C.


EDUARDO L. CARCACHE, PE 31914 ANA A. GONZALEZ VALDES, AR 97769 LUIS VARGAS, LEED AP #701023753163800 CKE GROUP, INC. COA-4432

> SHEET NAME SITE DEMOLITION PLAN

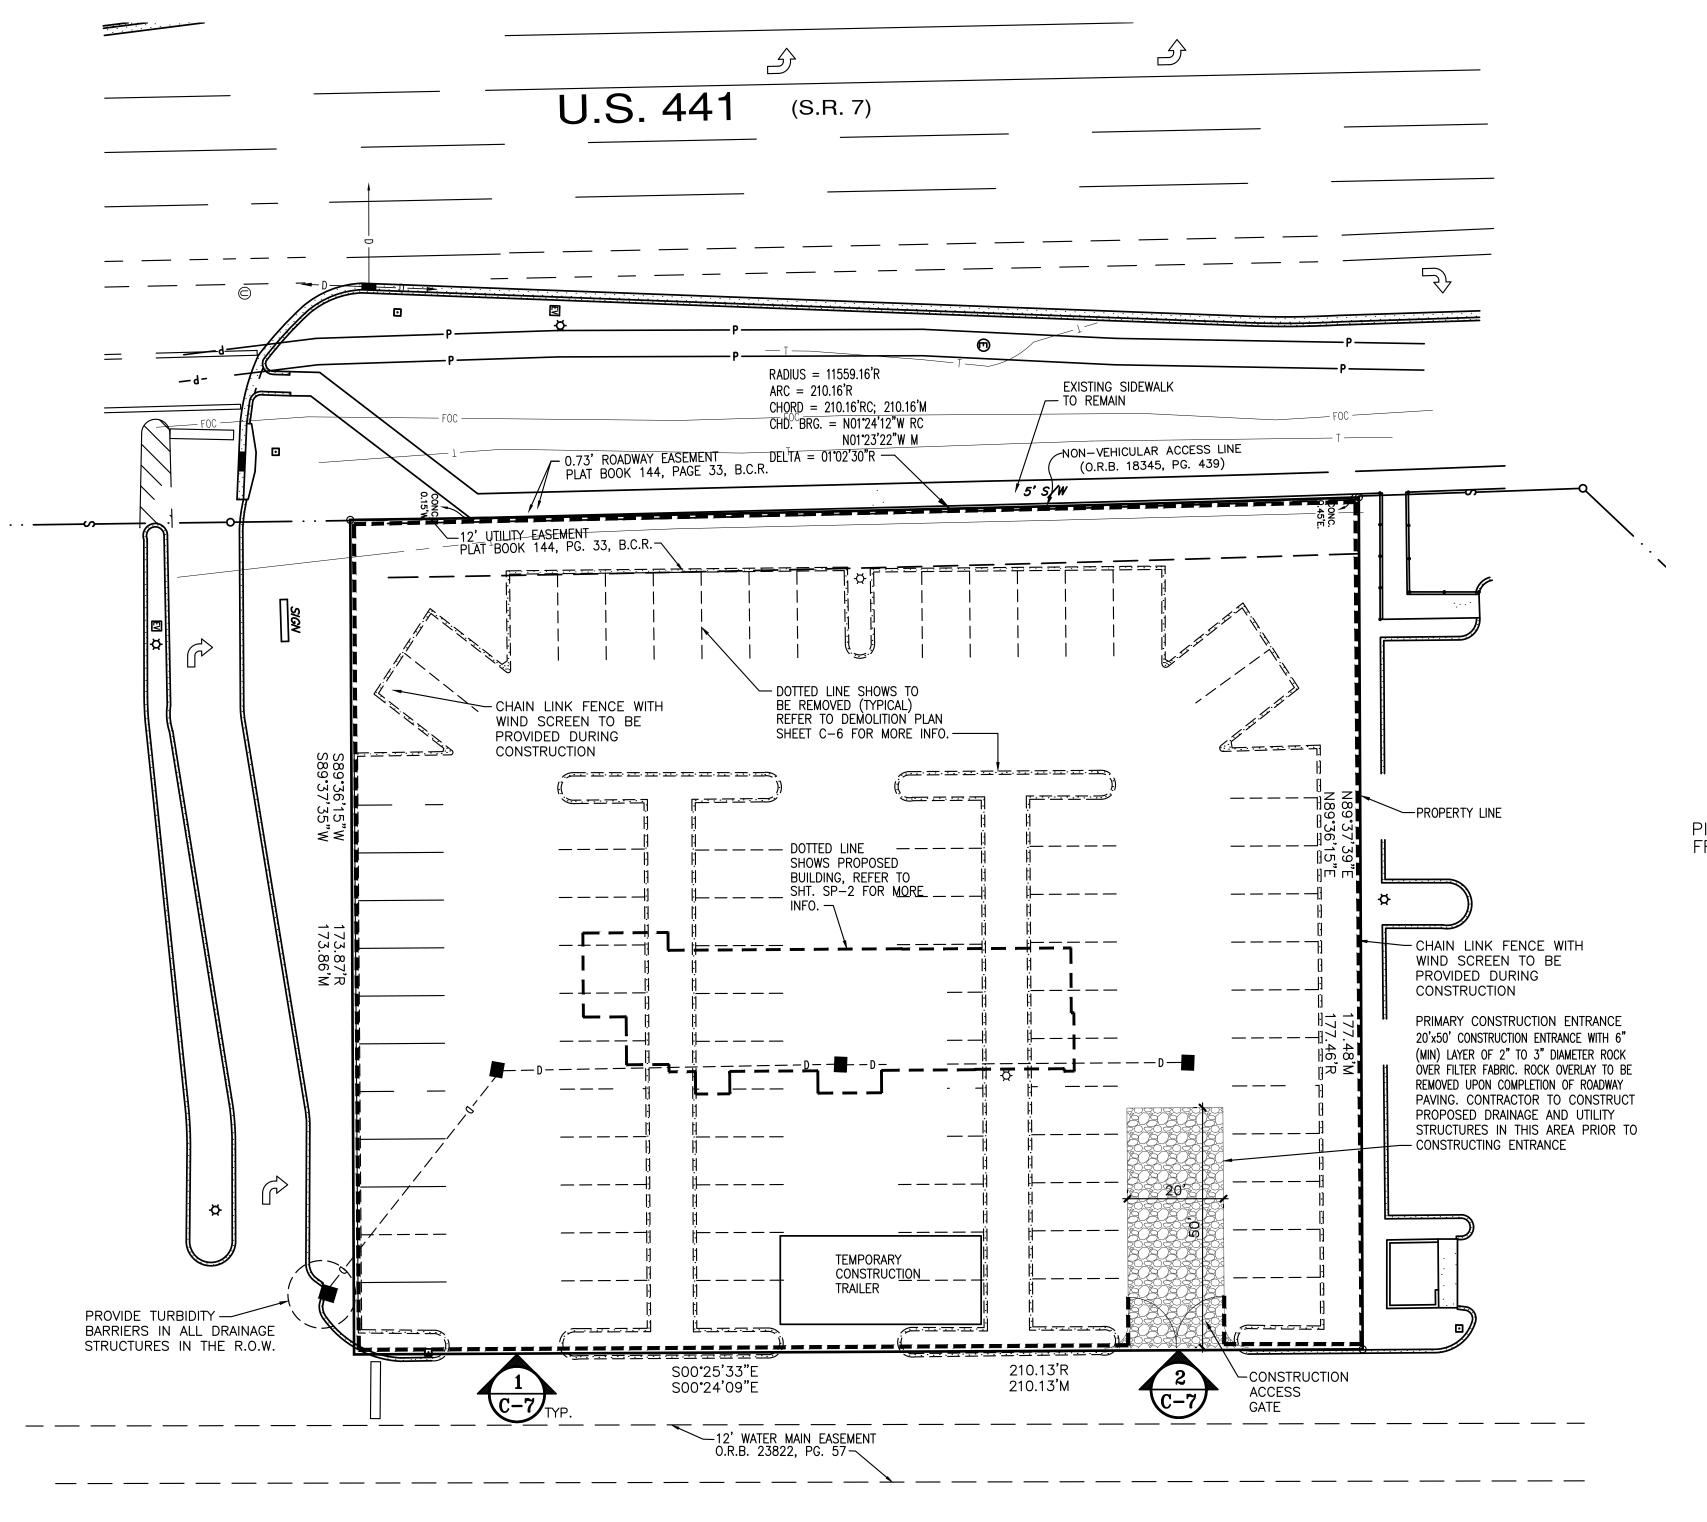

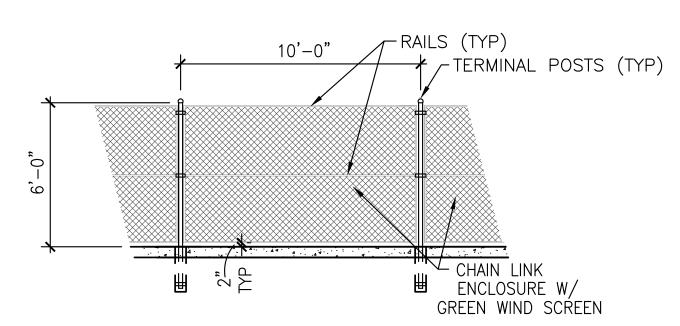


# 1 FENCE ELEVATION C-7 SCALE: 1/4" = 1'-0"

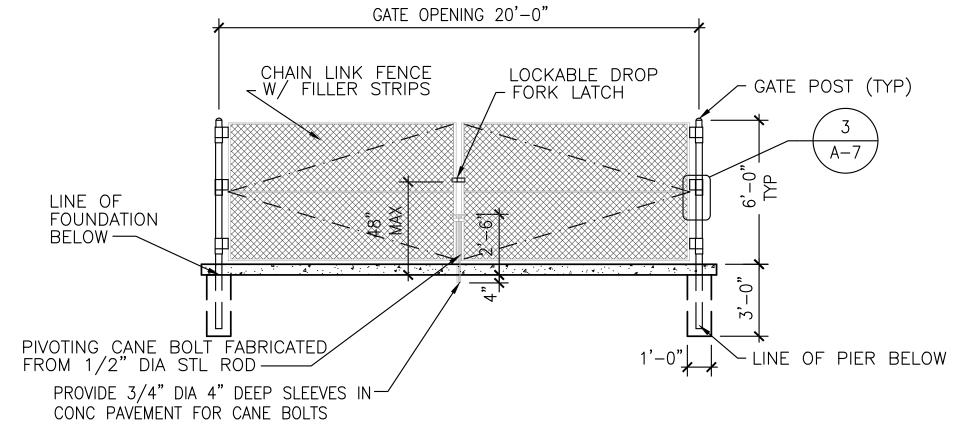

GATE ELEVATION

(C-7) SCALE: 1/4'' = 1'-0''

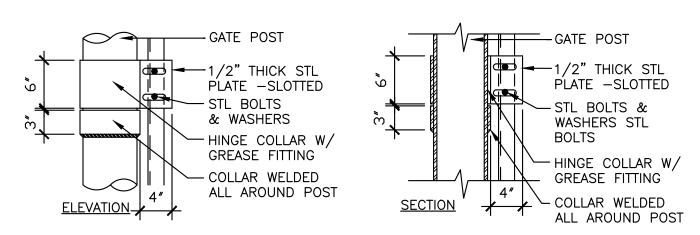

GATE HINGE DETAIL


C-7 SCALE: 1" = 1'-0"



Know what's below.

Call before you dig.



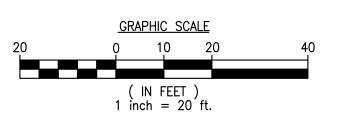

SITE NUMBER: 11670

BASE MODEL: USB NRE 55 R3

ASSET TYPE: FRAN


CLASSIFICATION: NEW

OWNER: JAE REST. GROUP, LLC

BASE VERSION: XXXXXXXXX

UPGRADE CLASSIFICATION:

CORP. NEW BUILD
PROJECT YEAR: 2017
FURNITURE PACKAGE: 2016 R3
DRAWING RELEASE 2016 R3

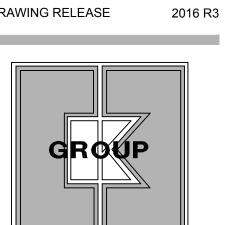

CKE
GROUP
INCORPORATED
engineering • architecture • planning

15500 NEW BARN ROAD

 SUITE 106

 MIAMI LAKES , FLORIDA 33014

 PHONE:
 (305) 558-4124

 FAX:
 (305) 826-0619

NEW

PROJECT TYPE: USB NRE 55

Store # 11670
JS 441 & JOHNSON ROAD

ISSUE DATE: 02/10/2016
PROJECT NUMBER: 1493
DRAWN BY: R. C.
CHECKED BY: E. C.


EDUARDO L. CARCACHE, PE 31914 ANA A. GONZALEZ VALDES, AR 97769 LUIS VARGAS, LEED AP #701023753163800 CKE GROUP, INC. COA-4432

CONST. FENCE / ACCESS PLAN

SHEET NAME

SHEET NUMBER

**C-7** 

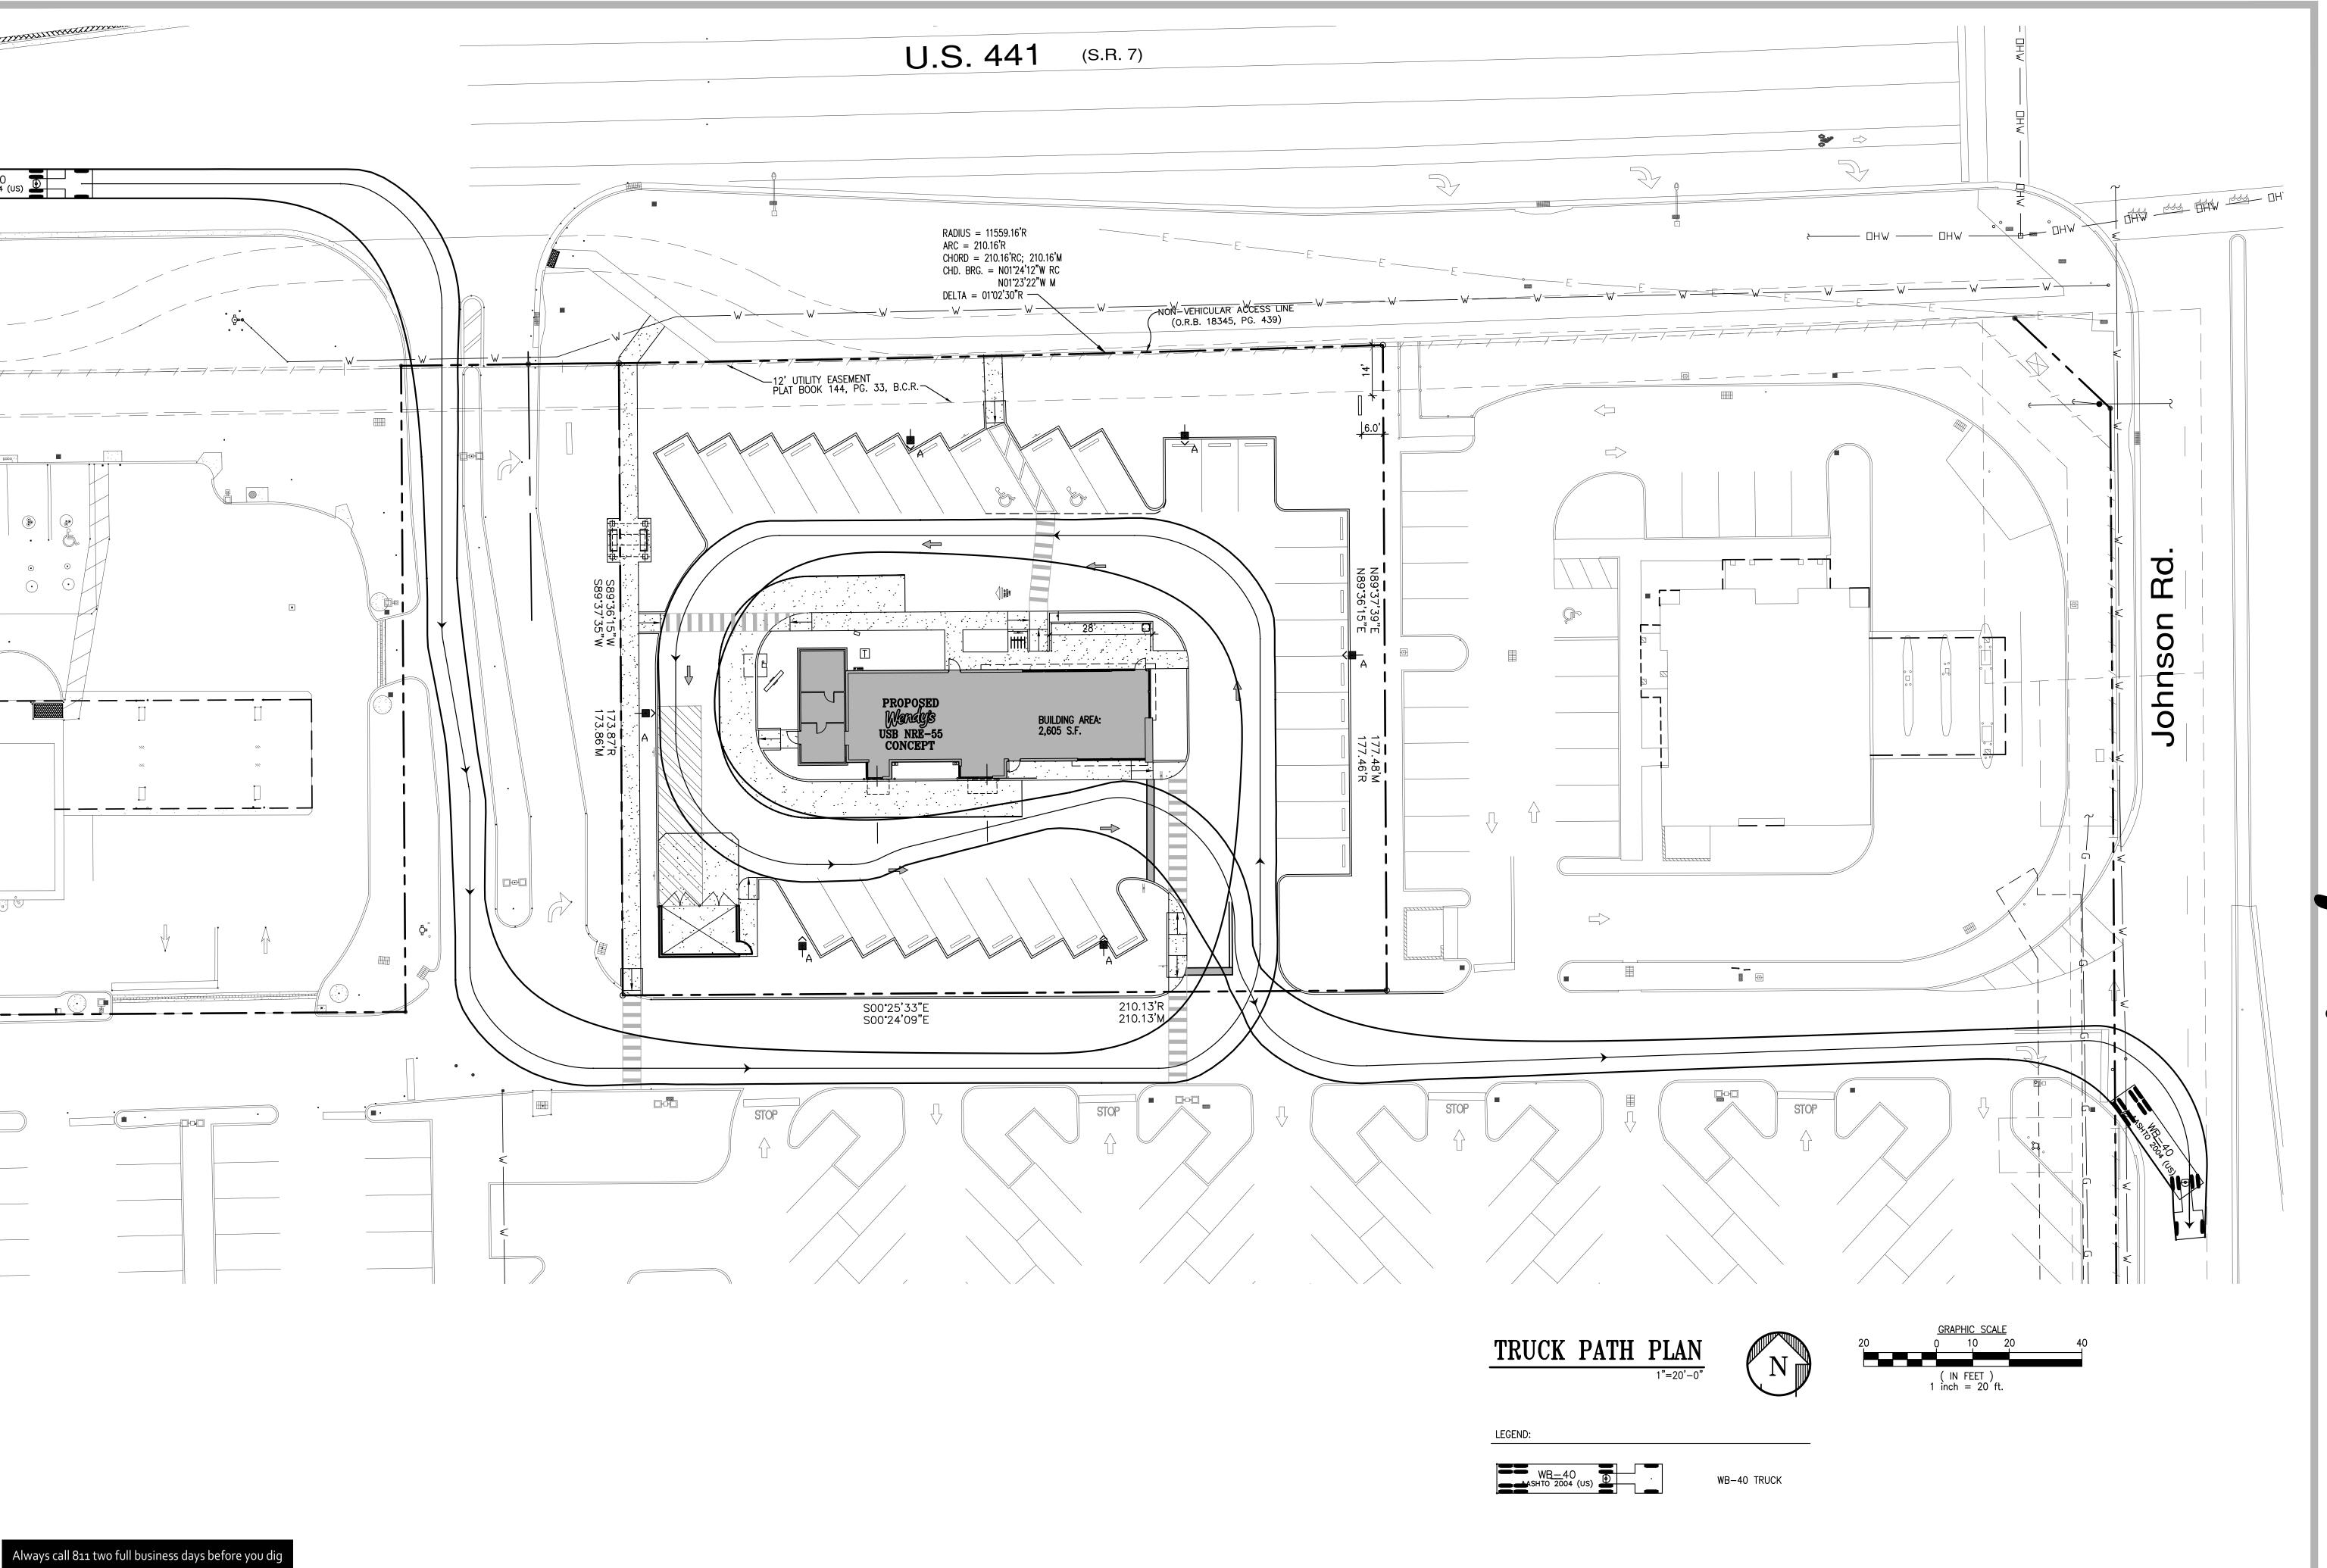

SITE NUMBER: 11670

BASE MODEL: USB NRE 55 R3

ASSET TYPE: FRAN

CLASSIFICATION: NEW

OWNER: JAE REST. GROUP, LLC

BASE VERSION: XXXXXXXXX

UPGRADE CLASSIFICATION:

PROJECT YEAR: 2017

FURNITURE PACKAGE: 2016 R3

DRAWING RELEASE 2016 R3



GROUP
INCORPORATED
engineering • architecture • planning
15500 NEW BARN ROAD

MIAMI LAKES , FLORIDA 33014

PHONE: (305) 558-4124

FAX: (305) 826-0619

PROJECT TYPE: USB NRE 55

NEW

Store # 11670 US 441 & JOHNSON ROAD

REV. DATE DESCRIPTION

1 05-01-18

2 07-18-18

ISSUE DATE: 02/10/2016

PROJECT NUMBER: 1493

DRAWN BY: R. C.

CHECKED BY: E. C.

SEAL

EDUARDO L. CARCACHE, PE 31914 ANA A. GONZALEZ VALDES, AR 97769 LUIS VARGAS, LEED AP #701023753163800 CKE GROUP, INC. COA-4432

TRUCK PATH PLAN

SHEET NAME

SHEET NI IMBER

**C-8** 



4800 WEST COPANS ROAD COCONUT CREEK, FLORIDA 33063

#### CITY OF COCONUT CREEK

DEVELOPMENT REVIEW COMMITTEE (DRC) REVIEW #1
03-08-17

PROJECT NA	ME:	Wendys Site					
PROJECT NU	MBER:	17020003					
LOCATION:		Coral Creek Shoppes					
APPLICANT/A	AGENT:	Corporate Property Services					
REVIEW/APP	LICATION	Site Plan					
DISCIPLINE	REVII	EWER	EMAIL	TELEPHONE			
DRC Chair	Liz Aguiar – Senior Pla	anner	laguiar@coconutcreek.net	(954) 973-6756			
Planning	Linda Whitman – Seni	or Planner	lwhitman@coconutcreek.net (954) 973-6756				
Planning	Natacha Josiah – Plar	nner	NJosiah@coconutcreek.net (954) 973-6756				
Building	Sean Flanagan - Chie	f Structural Inspector	sflanagan@coconutcreek.net (954) 973-6750				
Engineering	Eileen Cabrera - Engir	neer I	ecabrera@coconutcreek.net (954) 973-6786				
Engineering	Krishan Kandial – Eng	jineer I	KKandial@coconutcreek.net (954) 973-6786				
Fire	Jeff Gary – Fire Marsh	nall	igary@coconutcreek.net (954) 973-1563				
Landscape	Scott Peavler - Landso	cape (consultant)	speavler@coconutcreek.net (954) 973-6756				
Police	Brandi Delvecchio - Po	olice Department	bdelvecchio@coconutcreek.net (954) 956-6721				

#### **DEPARTMENTAL COMMENTS**

#### **BUILDING**

The Building Division approves this application.

This approval shall not imply full compliance with the Florida Building Code. Submittal of a building permit application and plans are required for review for a building permit.

Response: Understood as noted.

#### **ENGINEERING**

Hold

#### **GENERAL COMMENTS**

1. Additional comments may be provided and/or required upon review of any revised plans.

Response: Understood as noted.

 All required approvals from Broward County Health Department and Broward County Environmental Protection, Growth Management Department (BCEPGMD) or any other applicable agency shall be obtained and submitted to the Engineering Division prior to issuance of an Engineering permit.

Response: Understood as noted.



4800 WEST COPANS ROAD COCONUT CREEK, FLORIDA 33063

Clearly identify on plans the type of elevation datum used (which should only be NAVD 88 with conversion to NGVD 29).

Response: Please see sheet SP-2.

4. Indicate on plans the Finished Floor Elevation (FFE) for building.

Response: Please see sheet SP-2

5. A Water and Wastewater Agreement will be required including all water and wastewater impact fees paid to the City.

Response: Understood as noted.

6. If necessary, show all conflicts between water, wastewater, and drainage lines with the minimum separations.

Response: Please see sheet C-3 for site utilities.

#### TRAFFIC ENGINEERING

7. All pavement markings and signage shall be in accordance with the latest edition of the Manual on Uniform Traffic Control Devices (MUTCD).

Response: The plan has been updated to include all pavement markings and signage to comply with the Manual on Uniform Traffic Control Devices (MUTCD). Please see sheet C-4 that has a note included.

8. All proposed sidewalks shall be a minimum of 5' width.

Response: Please see sheet SP-2 where a minimum 5' sidewalk is proposed.

#### **ROADWAY AND PAVEMENT**

9. Sheet No C-1 not provided for paving and drainage plan.

Response: Sheet C-1 has been included with this submittal.

10. Transverse slope of pavement shall be a minimum of 2.0% for roadways and 1.0% for parking areas.

Response: There are notes that have been added to sheet C-1 and C-2. The proposed slopes shown on the plans comply with a minimum of 2% for roadways and 1.0 for parking.

11. Longitudinal slope of pavement shall be a minimum 0.4%.

Response: A note has been added to sheet C-1 and C-2, showing the proposed longitudinal slope of the pavement complies with the minimum 0.4%.



4800 WEST COPANS ROAD COCONUT CREEK, FLORIDA 33063

12. All accessible parking spaces and sidewalks shall conform to ADA standards.

Response: All accessible parking spaces and sidewalks conform to ADA standards. Please see sheets SP-2, SP-3 and C-4.

13. Disabled parking spaces shall conform to ADA and FDOT standards. Ensure all spaces have proper landing area.

Response: The plans and details have been updated to comply with the ADA and FDOT standards.

14. Disabled parking spaces shall be 20 ft in length. 18 feet to the curb stop and 2 feet overhang.

Response: The parking spaces are 20 feet in length. Please see sheets SP-2, Sp-3 and C-4.

#### **DRAINAGE COLLECTION SYSTEM**

15. Provide total pervious and impervious area before and after proposed construction on sheet SP-2.

Response: Please refer to table on Sheet SP-2 and C-1.

16. Broward County Environmental Protection, Growth Management Department (BCEPGMD) license for surface water management to be updated.

Response: Understood as noted.

#### **WATER & WASTEWATER SYSTEM**

17. Water service connection up to water meter shall be SDR 9 polyethylene pipe.

Response: Please refer to sheet C-3, as it is noted.

18. An easement shall be dedicated to the City for the proposed location of the water meter.

Response: Please refer to sheet C-3, as it is noted.

19. A fire flow test shall to be conducted to verify availability of required fire flow. Contact the Utilities and Engineering Department for details and submit fire flow calculations using I.S.O. criteria at Final Engineering Review. Fire flow tests can be requested from the City's Utilities & Engineering Department.

Response: A request for a fire flow test to be conducted has been submitted to the Joanne Lindholm from the City's Utilities & Engineering Department.

20. Fire line sprinkler services, fire hydrants and water service connections shall be connected to the water main independently and, shall not be connected to each other.



4800 WEST COPANS ROAD COCONUT CREEK, FLORIDA 33063

Response: Water service is tied to 8" main. No fire line or sprinklers are proposed or required.

21. Please clarify when will the new wastewater line be constructed and by whom.

Response: The new waterline will be constructed prior to Wendy's being constructed by the shopping center owner.

22. Service laterals for wastewater shall not be connected directly to a manhole. Laterals shall be a minimum of 7 ft. from manhole.

Response: Lateral connection is located 7 feet from the manhole. Please see sheet C-3.

23. City wastewater cleanout shall not be located in pavement area and shall be installed within green areas and utility easements for ease of access. City cleanout to be USF 7630. Provide a detail on the detail sheet.

Response: Shopping Center owner to provide.

#### LANDSCAPING, LIGHTING, AND IRRIGATION

24. Proposed trees shall not be placed within the utility easements.

Response: Proposed trees not placed within the utility easements. Please see sheet LP-1.

25. Show clear sight triangles (10 ft x 10 ft) at street intersections on landscape plans.

Response: Shown see LP-1 landscape

#### **FIRE**

Approved

#### **GREEN**

Hold

#### **General Comments**

1. Applicant shall be prepared to include applicable "green" or "sustainable" elements as part of the PowerPoint (or other) presentation to the Planning and Zoning Board.

Response: So noted. The "green" or sustainable" elements are on sheet CS-2.

2. Corrections shall be made to plans "addressing" and "correcting" each comment. Acknowledgements may not be considered corrections. Written responses to comments shall reference appropriate sheet(s) or detail(s) where corrections have been made.

#### Response: Understood as noted.

3. Additional comments may be provided at DRC meeting and/or upon review of any revised plans.



4800 WEST COPANS ROAD COCONUT CREEK, FLORIDA 33063

#### Response: Understood as noted.

4. Sec.13-81(14)b. – Any DRC application continued or inactive for more than six (6) months will be considered null and void and will be treated as a new application with applicable fees.

#### Response: Understood as noted.

5. Sec.13-320, Green Building Construction. All new commercial, office, industrial, hotels and civic use development or redevelopment projects seeking site plan approval shall comply with minimum Green Building Construction practices, pursuant to Ordinance 2007-040. Application submittals shall indicate how sustainable site development (see comment #7 below) will <u>exceed</u> the requirements of the Florida Building Code and other applicable codes.

#### Response: Please see sheet CS-2.

6. Sec.13-320(b)(1), all new development applicants must retain a LEED accredited professional within their planning and design team. *Please identify within application*.

#### Response: Please see sheet CS-2. The LEED accredited professional is Luis Vargas.

- 7. Sec.13-320(b)(2), all new development or redevelopment applications shall address the following green building components at time of development applications.
  - a. Sustainable site development
  - b. Water efficiency.
  - c. Energy efficiency.
  - d. Indoor environmental quality.
  - e. Materials and recycling.

#### Response: Please see sheet CS-2.

8. Sec.13-320(c)(1), be advised, at time of site plan submittal, property owner shall provide a written letter addressing each element listed in Sec.13-320(b)(2). Letter must detail how the property owner intends to comply with green building elements within the site and building(s). Site plans shall include lists, notes, drawings, or any other form of detail. In addition, the site plan shall include a checklist itemizing EACH green building element and indicate how each item will <u>exceed</u> Florida Building Code and other applicable code requirements.

#### Response: Please see sheet CS-2.

#### **Green Plan Comments**

The City Commission has adopted a City Green Plan, outlining city-wide "green" goals.
 Applicant shall make every effort to achieve goals outlined in the Green Plan during the site plan/rezoning process. Staff has provided a list below, of action steps from the



4800 WEST COPANS ROAD COCONUT CREEK, FLORIDA 33063

Green Plan that may be used for this project. A comprehensive list may be viewed on the City's website under the "live green" tab.

#### Response: Understood as noted.

10. Action 1.2 – Achieve LEED Certification or Florida Green Building Coalition (FGBC) Certification on 50% of buildings outside the MainStreet Project Area.
Staff recommends that the applicant consider pursuing LEED certification.

#### Response: The project will not be LEED certified.

11. Action 1.6 – Ensure 100% of new development projects throughout the City contain conspicuous displays of green technology that function in the project design while providing a social, artistic, and environmental value.

Project shall include <u>conspicuous</u> green technology "in excess" of minimum building code requirements such as but not limited to solar panels, solar powered landscape lighting, green screens, "effective" bio-filtration systems, cisterns or other rain water collection systems used for onsite irrigation or other creative green elements.

#### Response: There are "green screens" provided on the east building elevation.

12. Action 2.1 – Achieve 40% tree canopy coverage throughout the City with maximum tree coverage on public and private land by 2020.

Please demonstrate compliance in landscape plans and notes.

#### Response: Provided & noted see plan.

13. Action 2.2 – Achieve 40% greenroof coverage for new construction in MainStreet Project Area and 10% greenroof coverage for new construction for areas outside of MainStreet.

Green roofs may be either active or passive. To aide in heat island reduction, roofs should incorporate light colored/high albedo materials.

#### Response: Please note that a white roof membrane is being provided.

14. Action 5.1 – Increase recycling throughout the City. By increasing recycling the City can begin to reduce waste at the source of generation.

Staff recommends a dual receptacle bin for the use of the patrons for garbage and recycling at the entry to the facility.

#### Response: There will be 1 dumpster for recyclables.

15. Action 5.3 – Require all construction and demolition debris to divert 75% of waste from landfills.

Applicant shall commit to recycling construction debris.

Response: Site complies. Please see sheet CS-2.



4800 WEST COPANS ROAD COCONUT CREEK, FLORIDA 33063

16. Action 6.4 – Implement an alternative vehicle parking program to designated parking areas for alternative vehicle in developments throughout the City by 2020.

The City encourages the designation of alternative fuel or hybrid parking spaces and electric vehicle charging stations.

Response: See sheet SP-2. Site provides hybrid parking spaces.

#### LANDSCAPE ARCHITECTURE

Hold

#### <u>TS:</u>

1. Check sheet name with file name. TS-1 has L-2 on the sheet.

Response: Revised file name, see landscape plan.

2. In addition to the note at the top of the sheet, provide tree barricade notes from section 13-448 (n) and reference detail on sheet L-3.

Response: Added notes & detail. Please see sheet LP-1 and LP-2.

3. Provide note requiring general contractor to prepare final relocation sites for trees that are proposed to be relocated. Trees are only to be moved once and shall have tree barricades in place during the entire duration of construction.

Response: Added note, see landscape plan. Please see sheet LP-1 and LP-2.

#### L-1:

4. The South, East, and West perimeters do not meet the required 10' landscape strip per Section 13-443 (10).

Response: Revised site to 10'.

5. Commercial buildings require a 10' landscape area between the building and vehicular circulation. Sidewalks or other hardscape surfaces are not permitted within this 10'.

Response: Revised site, see plan.

6. Provided dimensions for landscape areas, including islands.

Response: Please see sheet SP-2 and LP-1.

7. Correct data table under "special provisions" from D to E for commercial. Provide shrubs and groundcover calculations.

Response: Revised to E and shown.





4800 WEST COPANS ROAD COCONUT CREEK, FLORIDA 33063

8. Shift trash enclosure west to allow space for existing tree at the SE corner of the site.

Response: Revised site, see plan.

9. Provide calculations for interior landscape requirement. Section 13-443 (12)(b).

Response: Provided see plan.

10. In the data table provide cardinal direction for which perimeter the code is applying too.

Response: Added see plan and chart.

11. Note that existing material outside of the proposed parcel lines cannot be counted towards code requirements for this project.

Response: Noted on plan, not counted. Please see sheet LP-1.

12. Roadway landscape buffer along state road 7 does not meet code. Additional tiers of landscape are needed in addition to a continuous hedge.

Response: Added two tiers, see plan. Please see sheet LP-1 and LP-2.

13. Provide 15' light pole setbacks on the plans with a dashed circle. Adjust any conflicts with proposed or existing trees/ palms.

Response: shown, see plan. Please see sheet SP-2 and LP-1.

14. Label fire hydrant locations if applicable and provide clear zone.

Response: N/A offsite, detail provided. Please see sheet SP-2 and LP-1.

15. Separate out existing trees from the proposed plant list in the legend. Provide two lists if necessary.

Response: Provided two lists, see plan. Please see sheet and LP-1, LP-2 and LP-3.

16. Provide species diversification calculation in data table. No more than 25% of one species is permitted.

Response: Species provided 25% max., see plan.

17. Native calculation is to include all proposed landscape material. Revise as necessary.

Response: shown see breakdown plantings.

18. Remove Guava tree from the plant list as it is listed as a Cat. 1 tree on the invasive plant list.



4800 WEST COPANS ROAD COCONUT CREEK, FLORIDA 33063

Response: Revised to Silver Buttonwood & Clusia.

#### PLANNING AND ZONING

Hold

#### **General Comments**

1. Applicant shall be prepared to make a PowerPoint (or other) presentation at the Planning and Zoning Board meeting which should include an overall site plan and color rendering(s).

Response: Understood as noted.

2. Applicant will be required to provide one (1) digital copy and 14 sets of application packages prior to the Planning and Zoning Board meeting. Sets will be required ONLY when ALL revisions have been made and application is in substantial compliance with applicable code requirements.

Response: Understood as noted.

Applicant shall make every effort to ensure public participation as part of this project review.
 Provide an itemized accounting and/or correspondence demonstrating efforts including any mailed notices, HOA meetings, site postings, correspondence etc.

Response: Understood as noted.

4. An address request letter, 11"x17" site plan and \$100.00 filing fee shall be submitted to the Sustainable Development Department. Addresses, subject to City and Post Office approval, will be assigned only upon site plan approval by the Planning & Zoning Board.

Response: Understood as noted.

5. Corrections shall be made to plans "correcting" each comment and re-submitted per digital submittal requirements. Acknowledgements in lieu of corrections, as applicable, are not considered corrections. Written responses to DRC comments shall reference correction location.

Response: Understood as noted.

6. Sec.13-81(14)b. – Any DRC application continued or inactive for more than six (6) months will be considered null and void and will be treated as a new application with applicable fees.

Response: Understood as noted.

7. Sec.13-81(14)c. – Final site plan revisions to be completed within seven days of Planning & Zoning Board approval. Failure to complete will result in a delinquent fee, per week, per item of \$100.00 unless otherwise stipulated by staff. Be advised, building permit will not be issued until all outstanding DRC items have been addressed and fees have been paid.

Response: Understood as noted.



4800 WEST COPANS ROAD COCONUT CREEK, FLORIDA 33063

8. Additional comments may be provided at DRC meeting and/or upon review of any revised plans.

Response: Understood as noted.

#### **Project Comments**

9. The proposed site plan assumes creation of an outparcel where one does not exist and where one is not permitted by Code. In so doing, the substandard outparcel has further created the need for numerous variances solely by the direct actions of the applicant. Further, review of this proposed site plan application has generated a list of staff comments identifying additional land development code requirements that may necessitate additional variance requests by the applicant. City staff maintains a position that the overall Shopping Center site has the maximum number of outparcels allowed by code and cannot support the site plan request.

Response: A rezoning application has been filed by the owner of the shopping center to alleviate the creation of an outparcel.

10. The previously approved site plan does not provide for any further development on this property, including outparcel development.

Response: A rezoning application has been filed by the owner of the shopping center to alleviate the creation of an outparcel.

10. Staff has concerns regarding the proposed architecture. Building facades should incorporate varied architecture elements to provide visual interest. Staff cannot support the rear elevation facing the main entrance, as proposed.

Response: The rear of the building has been redesigned, Please see sheets A1.1, A2.1 and A2.2.

11. Staff has concerns regarding the building footprint. The building must allow for foundation areas that provide adequate space for landscape material to thrive. A minimum of 10'ft planting is required on the north, east, and south area.

Response: A green screen has been added on the drive thru side (east) and increased planting area on south side. The north side is glass.

#### **Plat**

12. Sec.13-351 – Building permits will NOT be issued until the Plat note amendment has been recorded. See special land use comments regarding plat restrictions.

Response: Understood as noted.

#### **Impact Fees**

13. Section 13-110 thru 13-117, Affordable Housing Program. Pursuant to Ordinance 2006-005, all non-residential development will be subject to an affordable housing linkage fee. The fee, based on use and building square footage, must be paid prior to building permit issuance. Calculations are based on gross floor area minus stairwells, elevator shafts, mechanical rooms, and external storage rooms. An itemized floor area table will be required at time of building permit review.



4800 WEST COPANS ROAD COCONUT CREEK, FLORIDA 33063

Response: Understood as noted.

14. Division 5, Impact Fees, Section 13-118 through 13-126. Pursuant to Ordinance 2006-017, all new development shall assume a fair share cost of providing Police and Fire/Rescue facilities. Fee, based on use and building square footage, must be paid prior to issuance of building permit. An itemized floor area table will be required at time of building permit review.

Response: Understood as noted.

#### **Underground Utilities**

15. Section 13-142, Underground Utilities. Pursuant to Ordinance 2005-032, any project seeking site plan approval will be required to place all utilities including existing overhead utilities within the site or in public right-of-way adjacent to the site, underground. Electrical transmission and distribution lines with a rate load of 23k volts or higher shall be exempt from this requirement. Applicant must complete one of the following requirements prior to Planning & Zoning Board meeting; (1) provide a signed agreement between the applicant and each affected utility company demonstrating that the utility will be placed underground, (2) process an agreement with the City indicating the property owners' intent to comply with the under-grounding requirements for utilities, (3) if electrical lines with a rate load of 23k volts or higher exists, then a written detailed statement from a licensed professional engineer, qualified to verify such utility issues and, stating the rate load shall be provided, or (4) process an Underground Utility Waiver Application, which must be processed concurrently with the site plan, for consideration by the Planning & Zoning Board. Applicant must specify which option, as stated above, will be proposed for Board consideration. Appropriate information demonstrating compliance with City ordinance shall be submitted to the City for review as part of the DRC process. Be advised, failure to submit information in a timely manner, may prevent the site plan application from consideration by the P&Z Board.

Response: This does not apply as the overhead utilities are located on the west side of 441.

16. If technical reasons are the basis for a waiver application, the application shall contain a detailed statement by a Florida licensed Professional Engineer, qualified with respect to utility issues, explaining why it is technically not feasible to locate such utilities underground.

Response: N/A

17. Underground Utility Waiver submissions shall be prepared in accordance with the standards established in the City's Land Development Code, Section 13-142 "Underground Utilities Required" pursuant to Ordinance No. 2005-032. Applicant must provide a written justification that demonstrates the reasons for seeking a waiver to the underground placement of utilities. If technical reasons are the basis for the waiver application, the application must contain a detailed statement by a Florida licensed Professional Engineer, qualified with respect to utility issues, explaining why it is technically infeasible to locate such utilities underground.

Response: N/A





4800 WEST COPANS ROAD COCONUT CREEK, FLORIDA 33063

18. The City may grant a waiver if the application is supported by information detailing justifiable reasons for not pursuing the subject under-grounding.

Response: N/A

19. If a waiver is granted, a dollar amount equal to the cost of placing the utilities underground as determined by an estimate established by the relevant utilities and as agreed to by the City, may be required to be paid into the City's Underground Utility Fund, prior to building permit issuance.

Response: N/A

20. Applicant should include pictures of the utilities.

Response: Pictures are included of utilities on the west side of 441.

#### **Aesthetic Criteria**

21. Applicant shall provide correspondence responding to aesthetic design criteria including but not limited to differences between existing and proposed development, architectural style, heights, materials, color palette, etc.

Response: The proposed new Wendy's building design is a very contemporary but similar in size and height to the other buildings in the shopping center. The exterior wall finishes are Nichiha which is a fiber cement board panel that produce an attractive contrast in finishes and colors. The dining room has glass all around which enhances the look and also serves to invite pedestrian activity in the area. The existing shopping center is a little dated and we hope that with this new contemporary building, it will encourage more contemporary development.

22. Sec.13-37(c)(1)d. - Without restricting permissible limits of the applicable zoning district, the height and scale of each building shall be compatible with its site and existing or anticipated adjoining buildings.

Response: The proposed Wendy's is a one story building which is similar in height as the adjacent freestanding buildings in the shopping center.

23. Sec.13-37(c)(3)b.2. - Materials shall be selected for suitability to the type of buildings and the design in which they are used. Buildings shall have the same materials, or those that are architecturally harmonious, used for all building walls and other exterior building components wholly or partly visible from public ways.

Response: As stated above, the proposed building has a contemporary look and the materials are architecturally harmonious with the surrounding area.

#### **Elevations**

24. Architectural compatibility within the plaza shall be maintained. See aesthetic design criteria above. Architecture for all elevations shall be provided and be detailed.





4800 WEST COPANS ROAD COCONUT CREEK, FLORIDA 33063

Response: The proposed new Wend's building design is very contemporary but similar in size and height to other buildings in the shopping center. The exterior wall finishes are Nichiha which is a fiber cement board panel that produce an attractive contrast in finishes and colors. Revised plan and elevations to fully enclose the walk in freezer and also provide a green wall on the east side of the building. Outdoor patio seating is provided to encourage outdoor activity and bring in pedestrians from the street. The existing shopping center is a little dated and we hope that with this new contemporary building, it will encourage the shopping center to promote the use of contemporary styles for future development.

25. Show all light fixtures on building if proposed, they must be included in photometric calculations.

Response: Removed wall mounted fixtures, all others accounted in photometric plans and calculations.

26. Detail all elevations to show mean and maximum roof height, colors for all elements including decorative molding, banding, doors, etc. Identify all architectural treatments including finish material (ie stucco or other), width and depth cornices, banding etc.

Response: Please see sheet A-2.1 and A-2.2.

27. Sec.13-37(c)(3)b.2 - Buildings shall have the same materials, or those that are architecturally harmonious, on all walls and other exterior components that can be seen from public ways.

Response: The proposed building has a contemporary look and the materials are architecturally harmonious with the surrounding area.

#### Outparcel

28. Sec.13-359(b)(1) - Each outparcel must be developed so as to independently meet the provisions of the city's code. For the purpose of determining whether an outparcel has provided for sufficient landscaping, setbacks, as well as all other city code regulations have been met, each outparcel shall be reviewed independently and the condition of other parcels will not be considered in determining whether code criteria are met.

Response: A rezoning application has been filed by the owner of the shopping center in order to address this comment and allow for the creation of an outparcel.

29. Sec. 13-359(b)(2) – Number of outparcel permitted on any commercial development shall be no more than one (1) outparcel for every five (5) acres of total site area.

Response: A rezoning application has been filed by the owner of the shopping center in order to address this comment and allow for the creation of an outparcel.

30. Sec.13-359(b)(3) - No outparcel shall be less than forty three thousand five hundred sixty (43,560) square feet (one (1) acre) in area, with a minimum width of two hundred (200) feet.



4800 WEST COPANS ROAD COCONUT CREEK, FLORIDA 33063

Response: A rezoning application has been filed by the owner of the shopping center in order to address this comment and allow for the creation of an outparcel.

32. Sec.13-359(b)(6) - No building or canopy on any outparcel shall be located within 300 feet of any building or canopy on any other outparcel along the same street frontage.

Response: A rezoning application has been filed by the owner of the shopping center in order to address this comment and allow for the creation of an outparcel.

33. Sec.13-359(b)(14) - Landscape requirements. Outparcel development sites shall comply with the city's landscaping requirements for the number, type, size and quality of both trees and ground cover. Any area not devoted to a structure or paved parking must be landscaped and irrigated in accordance with minimum standards set by the city.

Response: A rezoning application has been filed by the owner of the shopping center in order to address this comment and allow for the creation of an outparcel. The PCD rezoning application includes a request for a waiver to comply with the landscape requirements. Please see sheet LP-1. The proposed site will be landscaped and irrigated in accordance with the minimum standards set by the City.

34. Sec.13-359(b)(15) - Pedestrian access. The owner/developer of an outparcel site shall provide pedestrian walkways connecting the outparcel to the principal development throughout the site.

Response: Please see the master site plan that is included with this submittal as it provides the pedestrian connectivity from the out parcel to the principal development.

#### Site Plan

35. Provide details for previously approved vs proposed, site data information for open space, building coverage etc. Indicate how/where the differences were achieved. Any site data provided as such must meet the requirement of Sec.13-359.

Response: Please see the table on sheet SP-2

36. Show ALL ground mounted equipment around the proposed structure. Ensure landscape and screening compliance. See aesthetic criteria section above.

Response: Mechanical equipment is located on the roof screened by a parapet. FPL transformers and other equipment is reflected on sheet SP-2.

37. Sec. 13-331(g) – Landscape buffers along major right-of-way must be at 35'.

Response: A rezoning application has been filed by the owner of the shopping center and the PCD manual that accompanies the request list various waivers that are being requested to accommodate the development of the proposed Wendy's on Parcel C.





4800 WEST COPANS ROAD COCONUT CREEK, FLORIDA 33063

38. Sec. 13-443(1) perimeter landscape requirement must be provided. Refer to landscape comments.

Response: A rezoning application has been filed by the owner of the shopping center.

39. Sec. 13-443(15)a – Roadway landscape buffer widths shall conform to Sec. 13-331(g).

Response: A rezoning application has been filed by the owner of the shopping center and the PCD manual that accompanies the request list various waivers that are being requested to accommodate the development of the proposed Wendy's on Parcel C.

40. Sec.13-443(15)b – Roadway landscape buffer shall be shown and delineated as separate parcels on all plats and site plans.

Response: Please see sheet SP-1 and SP-2. Also see sheet LP-1.

41. Sec.13-359(b)6 – Any outparcel shall not be located within 300' of any building or canopy of any other outparcel along the same street frontage.

Response: A rezoning application has been filed by the owner of the shopping center and the PCD manual that accompanies the request list various waivers that are being requested to accommodate the development of the proposed Wendy's on Parcel C.

42. Sec.13-359(11) – All service and deliveries shall be to the rear of the building. There shall be no outside display or storage of materials, products or goods.

Response: All service and deliveries shall be to the rear of the building and a loading zone has been proposed.

43. Sec.13-409(a)(3) - Provide a loading zone designated by pavement markings and a no parking sign. A full size loading zone of 12'x55', must be provided for parcels which are larger than 10,000 square feet. Loading zone must be accessible from the interior of the building it is intended to serve. Appropriate screening will be required.

Response: Please see loading zoning on sheet SP-2.

#### **Construction Trailer**

44. Show location of any temporary trailer(s) if proposed. Trailer(s) shall not be located adjacent to major thoroughfares, may require screening and will require sign review.

Response: The proposed construction trailer has been depicted on sheet C-7.

#### **Parking**



4800 WEST COPANS ROAD COCONUT CREEK, FLORIDA 33063

45. Sec.13-401 – Required parking for restaurant with high turn-over shall be calculated at 1 space per 150 square feet per customer service area, plus 1 space per 300 square feet noncustomer service area.

Response: Please see parking analysis table on sheet SP-2. The code requires 10 parking spaces be provided and 31 spaces are being provided.

46. Parking spaces must be 10' wide.

Response: The parking spaces provided are 10' wide.

#### **Truck Movement and Loading**

47. A truck movement plan must depict vehicles of appropriate size circulating around the site. Truck parking shall not be permitted on internal access aisle. Signs prohibiting parking or vehicle standing shall be provided.

Response: The truck path is depicted on C-8.

#### **Dumpster**

48. Applicant must obtain an approval from Republic Services (waste provider)(Francisco Valdes 954-583-1830).

Response: A letter of approval from Republic Services is included with this submittal.

#### **Signage**

49. The following sections are provided to assist with sign design.

Response: Understood as noted.

50. Subdivision 5.2 (13-458) – Permitted and prohibited permanent and temporary signs.

Response: Understood as noted.

51. Sec. 13-459 – Schedule of permitted signs.

Response: Understood as noted.

52. Sec. 13-460 – General provisions for all signs.

Response: Understood as noted.

53. Sec.13-460(k) – Cabinet signs.

Response: N/A

54. Sec.13-460(n) – Additional description of services provided or attributes.



4800 WEST COPANS ROAD COCONUT CREEK, FLORIDA 33063

Response: N/A

55. Sec.13-466.1 – Nonresidential frontages eligible for building signage.

Response: N/A

56. Sec. 13-467.4 – Directional signs.

Response: Please see signage package.

57. Sec.13-468.1 – Address signs.

Response: The monument sign will contain the 6" address numbers. Please see the signage package.

58. Sec.13-466.8 – Wall identification signs.

Response: Please see signage package.

59. Sec.13-468.7 – Drive through signs.

Response: Please see signage package.

60. Sec.13-468.8. - Service entrance signs.

Response: N/A

61. Sec. 13-468.9 - Window signs.

Response: Please see signage package.

62. Sec. 13-471 – Sign review procedures.

Response: Understood as noted.

63. Sec. 13-474 – Designer signs.

Response: N/A

#### **Photometric**

64. Photometric plan shall include ALL lighting including parking, exterior building, signage, and landscaping. Please provide all additional lighting/footcandles not currently shown on the plans.



4800 WEST COPANS ROAD COCONUT CREEK, FLORIDA 33063

Response: Please see sheet PH-1.

65. Sec.13-374 - Review the lighting code and provide the table as required (Sec.13-371(5)1) to determine if the proposed lighting design exceeds the acceptable number of lumens.

Response: Please see the table provided on sheet PH-1.

66. Sec.13-374 (2) d 4 - Light shall not trespass off the subject property. Revise the plans accordingly.

Response: Please see sheet PH-1. The over spill is limited to 0.0 foot candles along street and on adjacent boundaries of the parcel.

67. Sec.13-374 (2)d 11 - Address how the required reduction to a maximum of 1 footcandle will be achieved after hours.

Response: Please see note on sheet PH-1

68. Please note, per the lighting ordinance, wallpacks and flood lighting are prohibited. Luminaires shall be full cut-off or equivalent.

Response: Please see sheet A2.1 and A2.2.

69. Provide cut sheets for all luminaires which include lumen information.

Response: Please refer to sheet PH-1

70. Be advised, site lighting will be measured in the field using a light meter to ensure that the 10 fc limit is not exceeded. The building C.O. is predicated on meeting this requirement.

Response: Understood as noted.

#### POLICE

**Approved** 



May 10, 2018

City of Coconut Creek
Department of Sustainable Development
4800 West Copans Road
Coconut Creek, FL 33063

**RE:** Wendy's #11670

6710 North State Road 7 Coconut Creek, FL

Below please find Site Plan Aesthetic Design Criteria Justification Statement comments and responses regarding the above-described project.

Comment #1: Harmonious and efficient organizations. The site plan shall be organized harmoniously and efficiently in relation to topography, the size and type of plot, the character of adjoining property, and the type and size of buildings. The site will be developed to facilitate orderly development of surrounding property.

Response #1: The proposed Wendy's site plan is an efficient layout that promotes safe site circulation, combined with appealing landscaping and a harmonious architectural design. The site is organized harmoniously and efficiently in relation to the topography, the size of the parcel, the character of the adjoining property, and the size of the proposed fast food restaurant with a drive-thru. This proposed Wendy's will create a more visually appealing site, and also improve compatibility within the shopping center and further maintain the value of the land. The shopping center owner has filed a rezoning application that will result in a more harmonious and efficient development within its parameters.

Comment #2: Preservation of natural state. Desirable vegetation or other unique natural features shall be preserved in their natural state when practical. Tree and soil removal and filling of natural watercourses shall be minimized.

Response #2: The site is currently a parking lot, with existing landscaping adjacent to 441, and throughout the parcel. Several existing trees will be relocated within the site and additional new trees, hedge material, ground cover and sod will be planted within the property. Tree and soil removal, as well as filling of natural watercourses, will be minimized with the proposed development.



Comment #3: Enhancement of residential privacy. The site plan shall provide reasonable visual and sound privacy for all adjacent dwelling units. Fences, walks, barriers and vegetation shall be arranged for protection and privacy.

Response #3: The site is located within a highway commercial district, adjacent to State Road 7, with no residential property in the direct vicinity of the subject parcel.

Comment #4: Emergency access. Structures and other site features shall be arranged to permit practical emergency vehicle access to all sides of buildings

Response #4: The proposed Wendy's site plan has been designed to accommodate emergency vehicle access to all sides of the proposed Wendy's restaurant.

Comment #5: Access to public ways. Every structure and dwelling unit shall have access to a public street, walkway or other area dedicated to common use.

Response #5: An ADA public access connection to the existing public sidewalk along the east side of State Road 7 will be provided from the west side of the proposed Wendy's building. This will also allow access to the parcels to the north and south of the subject site.

Comment #6: Pedestrian circulation. A pedestrian circulation system shall be provided which is separate from the vehicular circulation system.

Response #6: Pedestrian access is provided at west side of the building, which will in turn provide access from the building to the public sidewalk. Pedestrians have access to the building on the east and west side of the building, adjacent to existing parking spaces. The ADA compliant parking spaces utilize the west entrance and ADA pedestrian walkway from the parking lot to the building. Wendy's and the shopping center owner have worked together in order to provide a pedestrian connection from the sidewalk along State Road 7, to the main shopping center. The pedestrian path will run along the Wendy's south property line and then continue through a landscape island in the parking lot of center and connect to the main structure of the shopping center.

Comment #7: Design of access and egress drives. The location, size, and numbers of ingress and egress drives to a site will be designed to minimize the negative impacts on public and private streets and on adjacent property.

Response #7: The proposed Wendy's parcel will not have a direct vehicular access connection to State Road 7. This project will minimize the negative impacts on the private shopping center driveway that runs north/south, by providing one curb cut into the parcel located at the northeast corner of the site. The location of the proposed driveway, into the site, is located at the northeast corner of the parcel, in order to minimize a traffic congestion from the main shopping center drive aisle located immediately south of the parcel. This driveway connection provides safe and adequate ingress/egress to the property.



- Comment #8: Coordination with off-site vehicular and pedestrian circulation systems. The arrangement of rights-of-way or easements for vehicular and pedestrian circulation shall coordinate the pattern of existing and planned streets and pedestrian or bicycle pathways in the area.
- Response #8: The property has vehicular ingress/egress and pedestrian access connection to the east and west sides of the parcel respectively. Pedestrian connectivity throughout the site is being provided by the shopping center through sidewalks to assist patrons with maneuvering through various parcels in a safe and efficient manner.
- Comment #9: Stormwater control. Protective measures shall ensure that removal of stormwater runoff will not adversely affect neighboring properties or the public storm drainage system. Provisions shall be made for construction of wastewater facilities including grading, gutters, and piping to direct stormwater and prevent erosion. Surface water on all paved areas shall be collected at intervals which do not obstruct vehicular or pedestrian traffic.
- Response #9: The proposed Wendy's property is incorporated within the overall retail shopping center storm water system. Wendy's will comply with all drainage design requirements for the City of Coconut Creek, Broward County, SFWMD, and FDOT.
- Comment #10: Exterior lighting. Location, type, size and direction of exterior lighting shall not glare or direct illumination which interferes with adjacent properties or safety of public rights-of-way.
- Response #10: The proposed site lighting for Wendy's will comply with the City of Coconut Creek Code requirements and will not provide glare or direct illumination which will interfere with adjacent properties or safety of public rights-of-way.
- Comment #11: Protection of property values. Elements of a site plan shall be arranged to have minimum negative impact on values of adjoining property.
- Response #11: The proposed Wendy's will not only enhance the Shops at Coral Creek but it will enhance the State Road 7 corridor and surrounding businesses. This project will have a a positive impact on the shopping center as well as the surrounding properties.



4800 WEST COPANS ROAD COCONUT CREEK, FLORIDA 33063

#### CITY OF COCONUT CREEK

DEVELOPMENT REVIEW COMMITTEE (DRC) REVIEW #2
05-24-18

PROJECT NA	ME:	Wendy's	Wendy's					
PROJECT NU	MBER:	17020003	0003					
LOCATION:		Coral Creek Shoppes						
APPLICANT/A	AGENT:	Corporate Propert	Corporate Property Services					
REVIEW/APP	LICATION	Site Plan						
DISCIPLINE	REVI	EWER	EMAIL	TELEPHONE				
DRC Chair	Liz Aguiar – Senior Pl	anner	laguiar@coconutcreek.net	(954) 973-6756				
Planning	Linda Whitman – Sen	ior Planner	lwhitman@coconutcreek.net (954) 973-6756					
Planning	Natacha Josiah – Pla	nner	NJosiah@coconutcreek.net (954) 973-675					
Building	Sean Flanagan - Chie	ef Structural Inspector	sflanagan@coconutcreek.net (954) 973-6750					
Engineering	Eileen Cabrera - Engi	neer II	ecabrera@coconutcreek.net	(954) 973-6786				
Engineering	Mohammed Albassan	n – Engineer I	malbassam@coconutcreek.net (954) 973-6786					
Fire	Jeff Gary – Fire Marsl	nall	jgary@coconutcreek.net (954) 973-1563					
Landscape	Scott Peavler - Lands	cape (consultant)	speavler@coconutcreek.net (954) 973-6756					
Police	Brandi Delvecchio - P	olice Department	bdelvecchio@coconutcreek.net (954) 956-6721					

#### **DEPARTMENTAL COMMENTS**

#### **BUILDING**

#### **APPROVED**

1. This approval shall not imply full compliance with the Florida Building Code. Submittal of a building permit application and plans are required for review for a building permit.

Response: Acknowledged, a building permit application and plans will be submitted for review to be in compliance with the Florida Building Code.

#### **ENGINEERING**

HOLD

1. Please specify by whom the new wastewater line will be constructed, the response says the waterline, not the wastewater line (please clarify).

Response: Wastewater line to be constructed by RAMCO/Coral Creek and it is not part of Wendy's scope of work.

2. The west side of the property has a 12 foot Utility Easement that shows trees being planted on it. No trees should be planted within the Utility Easement.



4800 WEST COPANS ROAD COCONUT CREEK, FLORIDA 33063

Response: Please note the tree has been removed and there are no trees planted within the utility Easement.

**FIRE** 

**APPROVED** 

Response: Approval noted.

#### LANDSCAPE ARCHITECTURE

**HOLD** 

1. Dimension text is difficult to read in planter beds. Pull text outside of beds legibility.

Response: Please see the revised sheet LP\_1 (Landscape Plan). The text is shown outside.

2. Correct data table under "special provisions" € for commercial. Groundcover calculation is to be provided as well.

Response: Please see sheet LP\_1, the data table has been revised and ground cover calculation provided.

3. In the data table provide cardinal direction for which perimeter the code is applying. 13-443 (13) & 13-443 (15) is West, Section 13-443 (10a) is applied to the North, South, and East perimeters. For the North, South, and East perimeter, in addition to the trees, a continuous hedge is required. Contact reviewer to discuss if needed.

Response: Please see sheet LP\_1, the cardinal direction codes have been added and continuous hedges provided.

4. Section 13-443 (9) is not applicable for the south or west perimeters.

Response: Acknowledged as noted. Please see sheet LP\_1, a note added stating not applicable.

5. Species diversification calculation and Native calculations is to be per the proposed plant material. Existing material is not to be included. Contact reviewer to discuss if needed.

Response: Please see the revised data on sheets LP\_1 and TS-1.

6. Elevations propose green wall systems along the east façade. What plant material is proposed for this wall and include in proposed plant list.





4800 WEST COPANS ROAD COCONUT CREEK, FLORIDA 33063

Response: Please see sheet LP\_1, the new landscape legend provides the plant material being provided for the green wall system.

#### PLANNING AND ZONING

HOLD

#### **General Comments**

 Applicant shall make every effort to ensure Community Involvement (business) as part of this project review. Provide an itemized accounting and/or correspondence demonstrating efforts including any mailed notices, meetings, correspondence, etc. Be advised, applicant shall submit a report to the Director of Sustainable Development or her designee prior to being scheduled for the Planning and Zoning Board and/or City Commission agenda.

Response: Consistent with our discussions with Staff, Ramco-Gershenson Properties, L.P., as the owner of the Coral Creek Shops, distributed a letter to the tenants within the Shopping Center of the pending applications and provided an opportunity to obtain more information. A copy of the correspondence is included in the re-submittal for the PCD rezoning.

 Applicant shall revise and strengthen justification responses to address City Land Development Code requirements. Site specific standards shall address existing site conditions and constraints that may have been created by the proposed parcel. The burden of demonstrating code compliance listed in Sec.13-355, is the responsibility of the applicant.

Response: The justification responses have been revised and strengthen to address the City Land Development Code requirements.

3. Applicant has stated that endorsements or letters of support from the plaza outparcel owners have been received. Provide copies of documents. See comment #1 above.

Response: Per Ramco-Gershenson Properties, L.P., all consents required by the underlying leases have been obtained to allow the Wendy's development.

4. Pending PowerPoint presentation at the Planning and Zoning Board meeting and City Commission meetings.

Response: Acknowledged, a PowerPoint presentation will be provided for the Planning & Zoning Board meeting and City Commission meeting

5. Pending receipt of one (1) digital copy of site plan package and PowerPoint presentation and 11 sets of site plan packages prior to the Planning and Zoning Board meeting.

Response: Acknowledged as noted and will be provided prior to Planning and Zoning Board meeting.

6. Pending approval of the Special Land Use application for the proposed restaurant.





4800 WEST COPANS ROAD COCONUT CREEK, FLORIDA 33063

Response: Acknowledged as noted. The Special Land Use application for the proposed restaurant is being reviewed.

7. Be advised, approval of Site plan is subject to approval of concurrent rezoning development review application.

Response: Acknowledged as noted that the Site Plan is subject to approval of concurrent rezoning.

8. Pending correspondence from Broward County ensuring that the proposed Wendy's development has not exceeded any plat restriction or condition.

Response: Correspondence from Broward County will be provided prior to building permit issuance.

9. Pending recordation of Plat Note Amendment prior to building permit issuance.

Response: Acknowledged as noted. Recordation of Plat Note Amendment will be provided prior to building permit issuance.

10. Pending receipt of signed/sealed drawings prior to issuance of any building permit.

Response: Acknowledged as noted. The signed/sealed drawing will be provided prior to the issuance of any building permit.

11. Pending payment of Police and Fire/Rescue facilities impact fee prior to building permit issuance.

Response: Acknowledged as noted.

12. Pending payment of Affordable Housing impact fee prior to building permit issuance.

Response: Acknowledged as noted.

#### **Underground Utilities**

13. Section 13-142, Underground Utilities. Pursuant to Ordinance 2005-032, any project seeking site plan approval will be required to place all utilities including existing overhead utilities within the site or in public right-of-way adjacent to the site, underground. Electrical transmission and distribution lines with a rate load of 23k volts or higher shall be exempt from this requirement. Applicant must complete one of the following requirements prior to Planning & Zoning Board meeting; (1) provide a signed agreement between the applicant and each affected utility company demonstrating that the utility will be placed underground, (2) process an agreement with the City indicating the property owners' intent to comply with the under-grounding requirements for utilities, (3) if electrical lines with a rate load of 23k volts or higher exists, then a written detailed



4800 WEST COPANS ROAD COCONUT CREEK, FLORIDA 33063

statement from a licensed professional engineer, *qualified to verify such utility issues* and, stating the rate load shall be provided, or (4) process an Underground Utility Waiver Application, which must be processed concurrently with the site plan, for consideration by the Planning & Zoning Board. Applicant must specify which option, as stated above, will be proposed for Board consideration. Appropriate information demonstrating compliance with City ordinance shall be submitted to the City for review as part of the DRC process. Be advised, failure to submit information in a timely manner, may prevent the site plan application from consideration by the P&Z Board.

Response: Per meeting with Liz Aguiar, Craig McDonald and Janna Lhota the requirement to underground utilities is not applicable due to the fact that the above ground utilities are located on the west side of 441.

14. Underground Utility Waiver submissions shall be prepared in accordance with the standards established in the City's Land Development Code, Section 13-142 "Underground Utilities Required" pursuant to Ordinance No. 2005-032. Applicant must provide a written justification that demonstrates the reasons for seeking a waiver to the underground placement of utilities. If technical reasons are the basis for the waiver application, the application must contain a detailed statement by a Florida licensed Professional Engineer, qualified with respect to utility issues, explaining why it is technically infeasible to locate such utilities underground.

Response: This is not applicable.

15. The City may grant a waiver if the application is supported by information detailing justifiable reasons for not pursuing the subject under-grounding.

Response: This is not applicable.

16. If a waiver is granted, a dollar amount equal to the cost of placing the utilities underground as determined by an estimate established by the relevant utilities and as agreed to by the City, may be required to be paid into the City's Underground Utility Fund, prior to building permit issuance.

Response: This is not applicable.

#### **Elevations**

17. Staff suggests a "Decorcable Green Wall" on the west elevation.

Response: Wendy's, respectfully suggest that this is not necessary since adequate pedestrian zone landscape is provided in this area and the north section is all glass with outdoor patio seating next to it.

18. Provide a color rendering elevation plan.

Response: A color rendering elevation plan will be provided prior to public hearing meeting.



4800 WEST COPANS ROAD COCONUT CREEK, FLORIDA 33063

#### **Dumpster**

19. Staff recommends that a pedestrian access and walkway be provided on the north side of the enclosure to reduce use of dumpster gates as a means a pedestrian access.

Response: Please see the revised sheets SP-2 for the pedestrian access and walkway and see the trash enclosure details on sheet SP-4.

#### Site Plan

20. Clarify item #31 on sheet SP-2.

Response: Please see sheet SP-2 where item #31 has been corrected to item #22.

21. Identify the 25' front setback noted on the master site plan to reflect the correct verbiage.

Response: The Master Site Plan on sheet SP-1 has been revised to reflect the correct verbiage.

22. The total of number of required parking spaces resulting in a fractional space shall require a full parking space. Revise parking analysis.

Response: Please see sheet SP-2, the parking analysis has been revised to provide the correct parking space total.

23. Include in the parking analysis, the required number of parking spaces for the outdoor dining area.

Response: Please see sheet SP-2, the updated parking analysis includes outdoor seating.

24. Identify existing transit stops located on State Road 7. State how this project will enhance and connect to transit.

Response: Please see the sheet SP-5, the Master Site pedestrian connectivity sheet that provides the existing transit stops located on State Road 7.

25. Improvements adjacent to State Road 7 shall include opportunities for pedestrian sidewalk connections and other features such as plazas, bench seating and pergolas. Applicant shall identify and show proposed amenities on site and landscape plan. Staff may provide additional details for pergola installation.

Response: Please see sheet SP-2, where Wendy's is adding a free standing trellis with benches at SW corner of the site.

26. Staff recommends that applicant consider additional pedestrian improvements throughout the plaza as part of the concurrent PCD and master site plan applications. Ensure additional amenities are reflected in the overall site and landscape plans.

# CONUT COLLEGE

#### **DEPARTMENT OF SUSTAINABLE DEVELOPMENT**

4800 WEST COPANS ROAD COCONUT CREEK, FLORIDA 33063

Response: Please see sheet SP-5, the Master Site pedestrian connectivity plan.

#### <u>Signage</u>

27. Sign located on the east elevation appears to be larger than allowed. However, the detail plan provides for a sign of six (6) feet in overall height which is the maximum permitted by City code. Both plans must be consistent. Revise accordingly.

Response: Please see both plans have been revised to show the height consistently.

28. Item #22, monument sign – Identify location of monument sign on Sheet SP-2.

Response: Please see sheet SP-2, where the monument sign has been correctly identified as #22.

29. Ground sign - Be advised, must provide a minimum 5 foot setback from property line. Provide a dimension demonstrating compliance.

Response: Please see sheet SP-2, a 6 foot dimension has been provided from the property line.

30. *Ground sign* - Be advised, permanent ground sign cannot encroach into utility easement.

Response: Please see sheet SP-2, the sign has been located outside the utility easement.

31. *Ground sign* - The sign face area shall not exceed sixty (60) percent of the sign structure area. Provide and demonstrate compliance with this requirement.


Response: The monument face is less than 60%. The sign face area is 22.75 square feet.

#### **POLICE**

**APPROVED** 

# Attachment A

Coral Creek Shops Master Plan

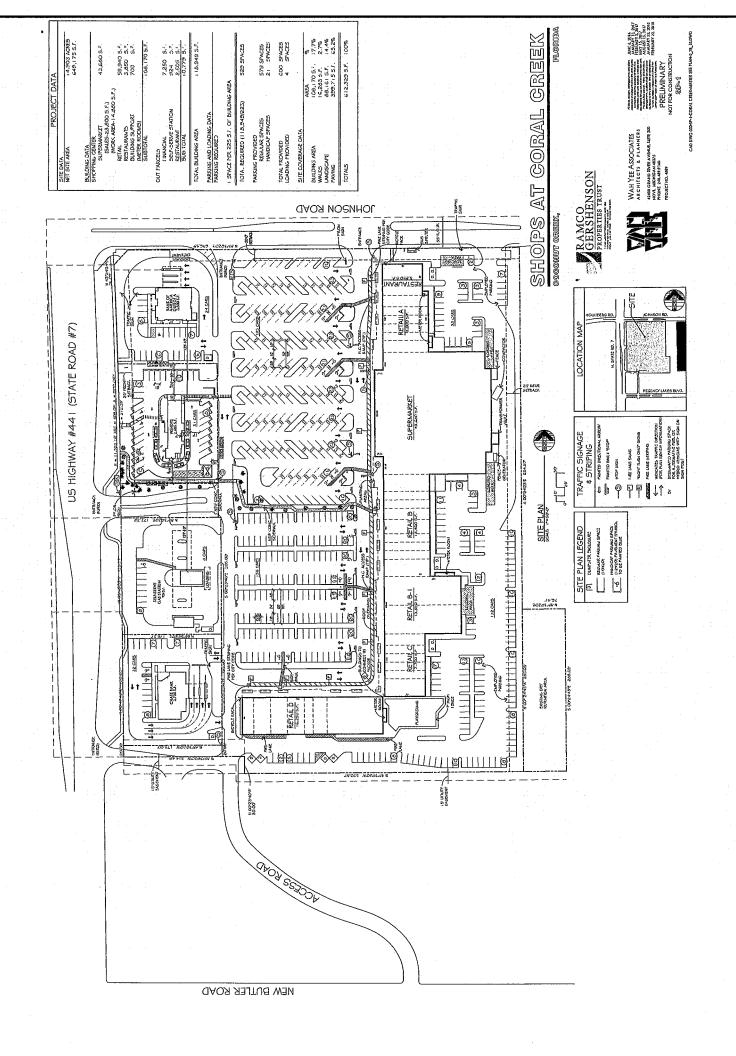

## Attachment B

Wendy's Preliminary Site Plan BROUP GALTED
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PARKING ANALYSIS		
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HUGOLV SPICES REQUIRED:	7	Ř
HUDDICAP SPACES PROVIDED.	.24	Ř
TOTAL PARKING SPACES PROYDED: (HOLLEWID HANDICAP IN OUT PARCEL)	ñ	34.



U.S. 441

(S.R. 7)

441


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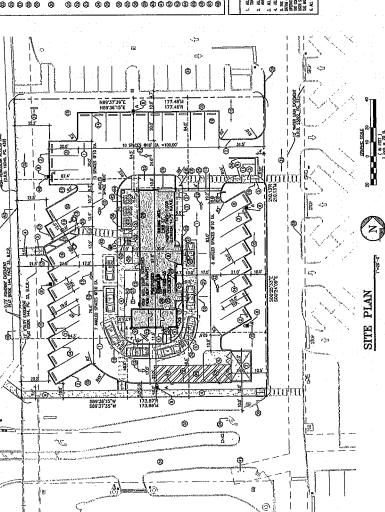
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ON SAD PLAT AND ON THE ARC OF A CHINE CONCAVE MESTERLY, TO MINCH A BUDLA LINE
REASS HORTH 87/247" EAST, THENCE SAVINERLY ON SAID EASTERLY RIGHT-OF-WAY LINE, ON THE WESTERN YIELD OF SAID TRAFF "A" MAD ON THE ARC OF A CHEME TO THE ROOT HANNIG A
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LINE HON-RADIAL TO THE FOLLOWING DESCRIBED CURNE 173.87 FEET TO THE INTERSECTION WITH
THE ACOCOMMINIONED EXSTENSY NOTIFICATION THE OF U.S. HOMBINY NO. 441 (STATE ROLD).  NO. 71 CAID MENTERNY INC. OF TRACT. "A" AND A STORT ON CAID CHOOSE CHARACE WESTERNY.
TO WHICH A PADAL LINE BEARS HORTH BOUTOS" EAST, THENCE HORTHERLY ON THE ARC OF
sad curse to the left, hands a radius of 11,580 is feet, a compal ande of 12230", for an are destant of 200 is feet to the poot of bedandin.
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	RORDA	FLORDA, CONTINUNG 36,846 SQUARE FEET (0.8459 ADRES), MORE OR LESS	), MORE OR LESS.
TON METER CO.			
The same work		ZOMING: B-3 COMMUNITY SHOPPING DISTRICT	PING DISTRICT
MIN NUMBRAS 9		LAND USE: COMMERCIAL	RCIAL
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(4" HGH)		Exerting	TISSOCIA
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	TOTAL BULBACE CONTINCE:		2,005,00 50, FI. ( 7,07 X )
SO OR APPROVED EQUAL.	TOTAL LANDSCAPED ANDLE	8,056,38 SQ. FL. ( 21,57 % )	1231420 SQ. FI. ( 35.05 2 )
DETAIL ON SHEET SP-3)	SOME A KEN COMP TOTAL	28,783,E 50, FL ( 78.13 % )	21,226,29 SQ, FI. ( 57,88 X )
	PERMOLES AREA:	8,056,38 SQ. FL. ( 21.87 S. ). (0.1854: A2825)	1291420 St. F. ( 35.05 X ) (0286± 40305)
ACCESSORES SWALL BE	SPERIOUS ARCK	ZAZELES SO. FL. ( TAIN I ) (LEGI± ACTES)	2183120 St. F. ( 64.05 X ) (0349± 40625)

виговис	RORDA	florda, containing 36,846 square feet (0,8459 aones), aigre or less.	), MORE OR LESS.
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		ZONING: B-3 COMMONITY SHOPPING DISTRICT	TIME DISTRICT
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DE CONSSIBIL IN STALE (4" HIGH)		Exertage	CESTAGREE .
WENENT	TOTAL LAND ARDIC	MANGO SQ. FT. ( BANK ASSIS )	JECHANO SO FI. ( 0.845± ACRES )
VACANC' SIGN	TOTAL BULBAC CONTINCE:	ı	2,005,00 St. FT. ( 7,50 x )
CK BY HUNTO-WODEL 8R3 OR APPROVED EDUM.	TOTAL LANDSCAPED AREA	8,056,38 SQ. FL.( 21,57 X )	12,914.80 50, FT. ( 35.05 2 )
DOR CONTED BLACK (SEE DETAIL ON SHEET SP-3)	SOME A VEN COMP LICE	28,783,E2 SQ. FL.( 78,13 X.)	21,226.20 SQ, FL. ( 57.85 % )
WOURL TELLOR	PERMITS AREA:	8,05630 50, FL ( 21.07 2 ) (0.1854 A2255)	12914.20 SQ. FT. ( 35.05 X ) (0.296± ACRI
JOUNTED EQUIPMENT AND ACCESSORIES SHALL BE FROM VICH BY PARAPET	SPERIOUS ARK	ZAZBACK SO, FL ( 78.13 IL ) (LEGILE ACRES)	21,831.20 St. F., ( 64.85 x ). (0.549± AUR
CROSSING SIGN			
	PAR	PARKING ANALYSIS	
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TIMOGRA	HANDICAP SPACES REQUIRED:	PDF 1 SPACES	и
SOURCE	HUDDON SPACES PROVIDED:	DED: 2 SPACES	13
DAGS ROARD	TOTAL PARRIED SPACES PROVIDED:	PROVIDE: 31 SPACES	'n



RADINS = 71559 16R
ANC = 216.6R
CHOND = 216.8NC, 210.16M
CHO. BHC, # M727.72 NC
NO 172.72 NL
DELIA = 0172.72 NR

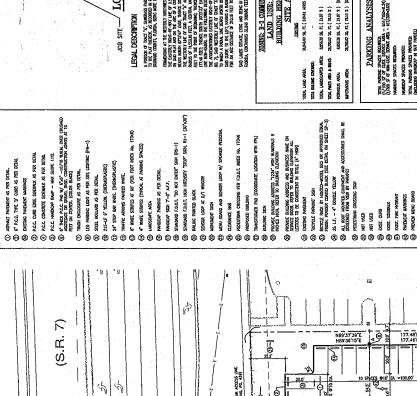

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## Attachment C

ITE Trip Generation Manual (10th Edition)

**Data Excerpts for Land Use #934** 

# Land Use: 934 Fast-Food Restaurant with Drive-Through Window

#### Description

This category includes fast-food restaurants with drive-through windows. This type of restaurant is characterized by a large drive-through clientele, long hours of service (some are open for breakfast, all are open for lunch and dinner, some are open late at night or 24 hours a day) and high turnover rates for eat-in customers. These limited-service eating establishments do not provide table service. Non-drive-through patrons generally order at a cash register and pay before they eat. Fast casual restaurant (Land Use 930), high-turnover (sit-down) restaurant (Land Use 932), fast-food restaurant without drive-through window (Land Use 933), and fast-food restaurant with drive-through window and no indoor seating (Land Use 935) are related uses.

#### **Additional Data**

sers should exercise caution when applying statistics during the AM peak periods, as the sites contained in the database for this land use may or may not be open for breakfast. In cases where it was confirmed that the sites were not open for breakfast, data for the AM peak hour of the adjacent street traffic were removed from the database.

The outdoor seating area is not included in the overall gross floor area. Therefore, the number of seats may be a more reliable independent variable on which to establish trip generation rates for facilities having significant outdoor seating.

Time-of-day distribution data for this land use for a weekday, Saturday, and Sunday are presented in Appendix A. For the 46 general urban/suburban sites with data, the overall highest vehicle volumes during the AM and PM on a weekday were counted between 11:45 a.m. and 12:45 p.m. and 12:00 and 1:00 p.m., respectively. For the one dense multi-use urban site with data, the same AM and PM peak hours were observed.

The sites were surveyed in the 1980s, the 1990s, the 2000s, and the 2010s in Alaska, Alberta (CAN), California, Colorado, Florida, Indiana, Kentucky, Maryland, Massachusetts, Minnesota, Montana, New Hampshire, New Jersey, New York, North Carolina, Ohio, Pennsylvania, South Dakota, Texas, Vermont, Virginia, Washington, and Wisconsin.

#### **Source Numbers**

163, 164, 168, 180, 181, 241, 245, 278, 294, 300, 301, 319, 338, 340, 342, 358, 389, 438, 502, 552, 577, 583, 584, 617, 640, 641, 704, 715, 728, 810, 866, 867, 869, 885, 886, 927, 935, 962, 977



### **Fast-Food Restaurant with Drive-Through Window**

(934)

Vehicle Trip Ends vs: 1000 Sq. Ft. GFA
On a: Weekday

Setting/Location: General Urban/Suburban

Number of Studies: 67 1000 Sq. Ft. GFA: 3

Directional Distribution: 50% entering, 50% exiting

#### Vehicle Trip Generation per 1000 Sq. Ft. GFA

Average Rate

Range of Rates


Standard Deviation

470.95

98.89 - 1137.66

244.44

#### **Data Plot and Equation**

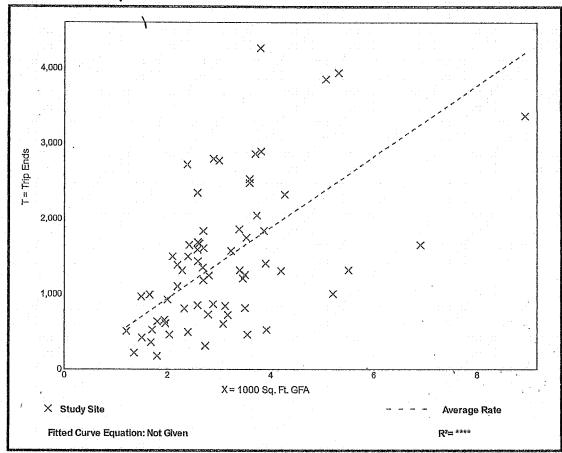



### **Fast-Food Restaurant with Drive-Through Window**

(934)

Vehicle Trip Ends vs: 1000 Sq. Ft. GFA

On a: Weekday,

Peak Hour of Adjacent Street Traffic,

One Hour Between 7 and 9 a.m.

Setting/Location: General Urban/Suburban

Number of Studies: 111 1000 Sq. Ft. GFA: 4

Directional Distribution: 51% entering, 49% exiting

#### Vehicle Trip Generation per 1000 Sq. Ft. GFA

Average Rate

Range of Rates


Standard Deviation

40.19

0.38 - 164.25

28.78

#### **Data Plot and Equation**

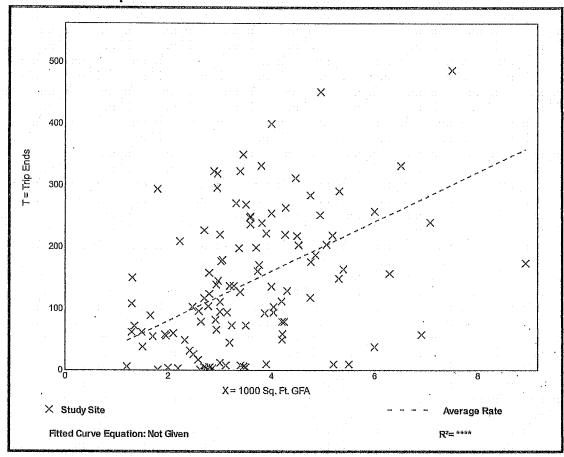



### **Fast-Food Restaurant with Drive-Through Window**

(934)

Vehicle Trip Ends vs: 1000 Sq. Ft. GFA

On a: Weekday,

Peak Hour of Adjacent Street Traffic,

One Hour Between 4 and 6 p.m.

Setting/Location: General Urban/Suburban

Number of Studies: 18 1000 Sq. Ft. GFA: 3

Directional Distribution: 52% entering, 48% exiting

#### Vehicle Trip Generation per 1000 Sq. Ft. GFA

Average Rate

Range of Rates


Standard Deviation

32.67

8.17 - 117.22

17.87

#### **Data Plot and Equation**

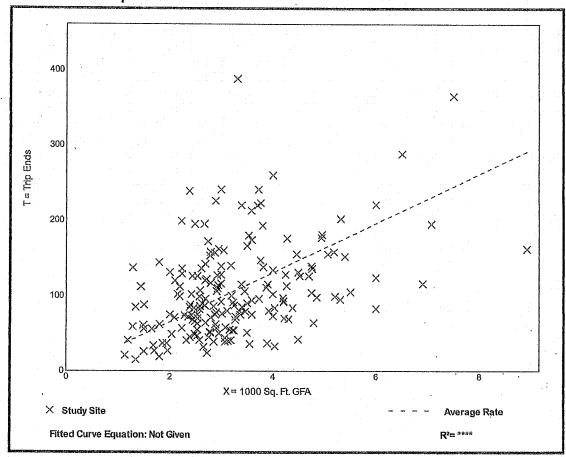



### Attachment D

**FDOT Q/LOS Tables** 

Peak Hour / Two-Way / Urbanized Area Table

# Generalized **Peak Hour Two-Way** Volumes for Florida's **Urbanized Areas**<sup>1</sup>

12/18/12

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Lanes	Median	B	C	D	Е	4	4,120	5,540	6,700	7,190
2	Undivided	*	1,510	1,600	**	6	6,130	8,370	10,060	11,100
4	Divided	*		3,580	**	8	8,230	11,100	13,390	15,010
6	Divided	*	3,420 5,250	5,390	**	10	10,330	14,040	16,840	18,930
4	Divided	ж	-		**	12	14,450	18,880	22,030	22,860
8	Divided	4	7,090	7,210						
	Class II (35 mph	or slowe	er posted sp	eed limit)				reeway Adjus		
Lanes	Median	В	C	$\mathbf{D}_{-}$	E		Auxiliary Lan		Ramı	ř
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4	Divided	*	1,310	2,920	3,040		+ 1,800		T 370	'
6	Divided	*	2,090	4,500	4,590		*:			
8	Divided	*	2,880	6,060	6,130					
1	Non-State Signal	lized Ro	oadway A	diustmen	ts					
	(Alter corre	esponding	state volum							
			percent.)							
	Non-State Signs	alized Ro	oadways	- 10%						
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Multi		No	No		-25%					
_	<b>-</b> :	-: "	Yes	. :	+ 5%		Uninterrun	ted Flow High	way Adiustm	ents
						Lanes	Median	Exclusive left		stment factors
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(A.G.)			MODE <sup>2</sup>					l as peak hour two-w modes unless specifi		
	ltiply motorized vehic tional roadway lanes					constitute	e a standard and she	ould be used only for	general planning ap	plications. The
ance.	nonar rolla way ranes	volumes		maximanqo				h this table is derived able and deriving cor		
David C	houldow/Diavala					corridor	or intersection desi	in, where more refine	ed techniques exist.	Calculations are
	houlder/Bicycle	n		ъ.	177			ons of the Highway C	apacity Manual and	the Transit
Lan	e Coverage	B *	C -	D	E	Capacity	and Quality of Ser	vice Manual.		
	0-49%		260	680	1,770			yele and pedestrian i		
ð	50-84%	190	600	1,770	>1,770	of motori	ized vehicles, not n	umber of bicyclists o	r pedestrians using t	he facility.
1 . {	35-100%	830	1,770	>1,770	**	<sup>3</sup> Buses pe	er hour shown are or	ly for the peak hour in	the single direction o	f the higher traffic
PEDESTRIAN MODE <sup>2</sup>						flow.			ROME TO STATE OF THE STATE OF T	
(Multiply motorized vehicle volumes shown below by number of						* Canno	t be achieved using	table input value de	faults.	
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		volume	s.)					vel of service letter g f service D become l		
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	(Buses in pe	neu rixet n peak directi	ion)							
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{	35-100%	> 4	≥3	$\geq 2$	≥ 1					